The Banks – Phase 3C
Public Infrastructure Development
Bid Package #2 – Lot 28 Park & Garage
January 13, 2022
THP #98090.40

ADDENDUM #2

GENERAL COMMENTS:

1. Post bid review meeting will be held on January 24, 2022.

QUESTIONS AND ANSWERS:

- 1. **A350** Drawing A102 has a blow-up drawing noted, 1/A350 at granite clad display area. A 350 is not in drawing packet. Can you please provide.
 - Response to question 1: See new Drawing A350 in Addendum #2.
- 2. **A341** Details 1 & 2 do not show concrete back up walls or soffits. Is this correct?
 - **Response to question 2:** No, there is to be a concrete backup wall. See revised Drawing A341 in Addendum #2.
- 3. **A206** Details 3 & 4. Please provide dimensions and reinforcing for the granite cladding seat wall (4/A206)
 - Response to question 3: See Drawings A205 & A206 in Addendum #1 for seat dimensions. For reinforcing, see updated Section 11/S201 in Addendum #2.
- 4. **A510.1** Please provide reinforcing details, elevations, and dimensions for all concrete back up foundations, for granite elements.
 - Response to question 4: See revised Drawing A510.1 in Addendum #2.
- 5. **A510.1** Detail 2/A510.1 depicts a granite structure to the east of the viewing screen structure. Please provide details for this area?
 - Response to question 5: See new Drawings A350, A351 & A352 in Addendum #2.
- 6. **A510.2** Please provide reinforcing details, elevations, and dimensions for all concrete back up foundations, for granite elements.
 - Response to question 6: See revised Drawing A510.2 in Addendum #2.
- 7. S101 Please define the structural connections for grade beams and walls shown outside the SOG footprint. Will current contractor furnish dowel savers in existing construction or will TC 03 contractor be required to drill and dowel to existing grade beams, pile caps, and walls.
 - Response to question 7: At west side, where retaining wall meets basement
 wall, see Plan Note 12 on Drawing S101. Coordinate with CM if the footing and
 pile cap will be poured integral. If not, DBR's will be provided in BP #1 to
 connect pile cap to the retaining wall footing. At east side, new retaining wall

footing will pour on top of BP #1 grade beam – no dowels required. Per keynote 11, both walls have an expansion joint; no connection required for the walls.

- 8. **A102** Please provide details for granite backup concrete for planter structures located between column lines W11.6 thru W12.4 / 4 thru 7.
 - Response to question 8: See revised drawings in Addendum #2.
- 9. **A202** Please provide top of wall/curb for details 5,6,7. This curb and wall will sit on the upturn beam located at along column line PJ1.
 - **Response to question 9:** See revised Drawing A202 in Addendum #2 and refer to details 10 & 15/S401.
- 10. **A230 –** Please provide detail 7/A230.
 - Response to question 10: See revised Drawing A230 in Addendum #2.
- 11. Please confirm that all third party testing agencies are hired and paid for by the owner including the third party testing agency for monitoring the settling plates.
 - Response to question 11: All Third Party Testing is by the Owner.
- 12. The schedule shows the concrete site walls, walkways, and site stairs starting right after the completion of structural soil fill. The schedule also has an activity for a 15 day settling period for the structural soil fill. The settling period and concrete site walls, walkways and stairs activities are happening at the same time. Does the settling period need to be complete before the concrete work can begin?
 - Response to question 12: The schedule calls for starting the walks South to North. This is intended to allow the deepest parts of the soil to have the time needed to settle. Terracon believes the majority of settlement will take place quickly with the remaining ½-1" taking place over the 15 days. Final tie into the podium will be dependent on settling plates located at the deepest locations.
- 13. Refer to S101. Is the battered wall along Elm St. between column lines PJ1.2 and PL1 part of TC-03 scope of work?
 - Response to question 13: The part of this wall that is above the podium slab (from elevation 497.67' up) is part of the TC-03 scope of work (the section of the wall below the podium slab is part of BP #1).
- 14. Refer to S101. Is the battered wall along Elm St. between column lines PL1 and PN1 part of TC-03 scope of work?
 - Response to question 14: Yes, this wall is part of the TC-03 scope of work.
- 15. Please confirm that the only footings/grade beams/ foundation systems to be included in TC-03 scope of work are the ones associated with the walls installed under this package.
 - Response to question 15: Confirmed. Only the foundations required to complete the walls and site concrete are required. Refer to the Referenced BP#1 Addendum #2 produced in BP#2 Addendum #1 for more clarity of what was included in the previous Package.

- 16. TC-03 Contract Description, item 13, states light pole bases are by TC-03. TC-04 Contract Description, item 31, states light pole bases are by TC-04. Please confirm which Trade Contract is to include the light pole bases.
 - Response to question 16: See revised Summary of Work included in Addendum #2.
- 17. Drawing A206, revised in Addendum #1, references a detail 7/A230. There s not a detail 7 on A230. Please provide.
 - Response to question 17: See revised Drawing A230 in Addendum #2.

PROJECT MANUAL:

- 1. Section 000100 PROJECT MANUAL INDEX (Reissued Document).
- 2. Section 000115 DRAWING INDEX (Reissued Document).
- 3. Section 011100 SUMMARY OF WORK (Reissued Document).
- 4. Section 071300 SHEET MEMBRANE WATERPROOFING (New Document).

DRAWINGS:

- 1. **Drawing C102.1:** (Sheet Reissued)
 - Revised Rim elevation M100.
 - Revised Mehring Way clean out elevation.
 - Revised Elm Street clean out elevation.
- 2. **Drawing C103:** (Sheet Reissued)
 - Revised grading in landscape areas.
 - Wall extended 7' west on radial line 5, revised grading at wall/landscaping.
- 3. **Drawing A002**: (New Sheet Issued)
 - Revised drawing per clouded areas.
- 4. **Drawing A101**: (Sheet Reissued)
 - Revised drawing per clouded areas.
- 5. **Drawing A102**: (Sheet Reissued)
 - Revised drawing per clouded areas.
- 6. **Drawing A202**: (Sheet Reissued)
 - Granite finish clarifications and updates.
- 7. **Drawing A220**: (Sheet Reissued)
 - Bollard detail removed/replaced.
 - Shading updated.
- 8. **Drawing A230**: (Sheet Reissued)
 - Details revised, see drawing per clouded areas.

- 9. **Drawing A240**: (Sheet Reissued)
 - Handrail details revised, see clouded areas.
 - Elm Street stair handrail added.
- 10. **Drawing A250**: (Sheet Reissued)
 - Revised drawing per clouded areas.
- 11. **Drawing A260**: (New Sheet Issued)
 - Revised drawing per clouded areas.
- 12. **Drawing A261**: (New Sheet Issued)
 - Revised drawing per clouded areas.
- 13. **Drawing A300**: (Sheet Reissued)
 - Granite finish clarification and geometric updates per clouded areas.
- 14. **Drawing A301**: (Sheet Reissued)
 - Granite finish clarification and geometric updates per clouded areas.
- 15. **Drawing A302**: (Sheet Reissued)
 - Granite finish clarification and geometric updates per clouded areas.
- 16. **Drawing A310**: (Sheet Reissued)
 - Granite finish clarification and geometric updates per clouded areas.
- 17. **Drawing A320**: (Sheet Reissued)
 - Granite finish clarification and geometric updates per clouded areas.
- 18. **Drawing A330**: (Sheet Reissued)
 - Granite finish clarification and geometric updates per clouded areas.
- 19. **Drawing A340**: (Sheet Reissued)
 - Granite finish clarification and geometric updates per clouded areas.
- 20. **Drawing A341**: (Sheet Reissued)
 - Granite finish clarification and geometric updates per clouded areas.
- 21. **Drawing A350**: (New Sheet Issued)
 - Fountain and Lower Landing Display.
- 22. **Drawing A351**: (New Sheet Issued)
 - Lower Landing Display Sections and Details.
- 23. **Drawing A352**: (New Sheet Issued)
 - Fountain Sections.
- 24. **Drawing A360**: (Sheet Reissued)
 - Granite finish clarification and geometric updates per clouded areas.

25. **Drawing A361**: (Sheet Reissued)

• Granite finish clarification and geometric updates per clouded areas.

26. **Drawing A370**: (Sheet Reissued)

• Granite finish clarification and geometric updates per clouded areas.

27. **Drawing A371**: (Sheet Reissued)

• Granite finish clarification and geometric updates per clouded areas.

28. **Drawing A372**: (Sheet Reissued)

• Granite finish clarification and geometric updates per clouded areas.

29. **Drawing A508.1**: (New Sheet Issued)

Added new sheet to address upper landing bench (plans/elevations)

30. **Drawing A510.1**: (Sheet Reissued)

- Added granite bench details w/ structural notes (Baker question 4).
- Updated section w/ detail callout.
- Added new section to address east granite seat cluster (Baker question 5).
- Added notes for top of bench for scattered benches.

31. **Drawing A510.2:** (Sheet Reissued)

- Updated foundation layout
- Updated sections to respond to new foundation layout
- Added details w/ structural notes (Baker question 6)

32. **Drawing A512.1:** (Sheet Reissued)

- Added section and elevation (missing info).
- Added notes to elevations.

33. **Drawing A513:** (Sheet Reissued)

- Added new elevation
- Added notes & elevation marker

34. **Drawing P001**: (Sheet Reissued)

- Revised "Irrigation Booster Pump Detail" to accommodate new pump design basis. Added irrigation components.
- Added Equipment Data to specify irrigation pump design Basis.
 - New pump has been down rated from 5 HP to 1.5 HP. Refer to new verbiage for further details.

35. **Drawing P101A**: (Sheet Reissued)

- Lot 23 Plan: Relocated Booster pump assembly location from "Extra Room" to "Sprinkler Room". Revised pipe sizes.
- Lower Level Plan:
 - Removed large portion of new 1.5" NPW piping extending from Lot 23 connection to the east, to supply riser location. Due to revised pressure and flow requirements, irrigation supply can now be tapped from adjacent existing 1" NPW main as shown.

 Lot 28 Hose bibbs and yard hydrants require a separate water supply system, and have been separated from the irrigation piping. Provided new 0.75" NPW tap in Lot 27,and extended into Lot 28.

36. **Drawing P101**: (Sheet Reissued)

- Below grade yard hydrant piping not shown in previous submittal. Piping added for clarity. Drawing notes 4 and 5 added for description of hydrant work and specification.
- Hose bibbs and yard hydrants shown on separate NPW system fed from lot 27.

37. **Drawing E002:** (Sheet Reissued)

- Revised PL6 fixture and pole type.
- Revised S1 fixture catalog number.

38. **Drawing E003:** (Sheet Reissued)

- BP-1 removed from Panelboard L-23.
- BP-1 added to Panelboard RP23A.
- Added lighting circuit to Panelboard L-23.

39. **Drawing E201:** (Sheet Reissued)

- Revised Upper Level Lighting Plan and layout.
- Added plan for relocating street pole lights.
- Revised Note 8 &13 and added Notes 17 21.
- Booster pomp BP-1 was revised from 5HP-480V-3PH to 1.5HP-208V-1PH

40. **Drawing E301:** (Sheet Reissued)

Booster pump BP-1 circuit information revised to allow for revised pump voltage.

41. **Drawing SW101:** (Drawing Clarifications)

- Drawing Hex Notes:
 - Modify Hex note #1 to read:

"Review and prepare concrete for membrane application. Refer to details 1 and 2 on drawing SW301 and specification section 030100."

- Drawing Legend:
 - Change hex note #4 to #10.
 - Change hex note #5 to #6.
 - Change hex note #6 to #7.

42. **Drawing SW201:** (Drawing Clarifications)

- Add Hex Note #13:
 - "Review and prepare concrete for expansion joint installation. Refer to details 1, 2, and 3 on drawing SW301 and specification section 030100."
- Detail 3:
 - o Change hex note #3 to #13.
 - Change hex note #3 to #13.
 - o Change hex note #5 to #51.
- Detail 8:
 - Change hex note #3 that is pointing to the expansion joint hex note #13.
 - Change hex note #16 to #11.

GENERAL:


- 1. Provide (4) Litter Receptacles:
 - a. Manufacturer: Landscape Forms, Inc.
 - b. Model: Chase Park litter receptacle.
 - c. Style: Side Opening.
 - d. Color: As selected by Architect.
 - e. Mounting: Surface-mounted.
 - f. Lock: Keyed with 2 brass keys (coordinate keying with Owner).
 - g. Materials:
 - Base: Rotationally molded linear low-density polyethylene. Color is dark gray.
 Base is filled with concrete for stability.
 - ii. Sides & Door: Cast 319 Aluminum.
 - iii. Hinges: Two, stainless steel, connects sides and door.
 - iv. Latch: Stainless steel.
 - v. Lock Cam & Lock Plate: Stainless Steel.
 - vi. Lid: 0.100" thick, spun 1100-0 aluminum.
 - vii. Lid Bracket: 1" x 1" x 1" aluminum angle.
 - viii. Liners: Black, formed polyethylene, 36 gallon capacity.
 - ix. Fasteners: Stainless Steel.

ATTACHMENTS:

- 1. Reference Drawing A102 submitted by Bidder as part of Q&A.
- 2. Section 000100 PROJECT MANUAL INDEX
- 3. Section 000115 DRAWING INDEX
- 4. Section 011100 SUMMARY OF WORK
- 5. Section 071300 SHEET MEMBRANE WATERPROOFING
- 6. Drawing A101
- 7. Drawing A102
- 8. Drawing A202
- 9. Drawing A220
- 10. Drawing A230
- 11. Drawing A240
- 12. Drawing A250
- 13. Drawing A260
- 14. Drawing A300

- 15. Drawing A301
- 16. Drawing A302
- 17. Drawing A310
- 18. Drawing A320
- 19. Drawing A330
- 20. Drawing A340
- 21. Drawing A341
- 22. Drawing A350
- 23. Drawing A351
- 24. Drawing A352
- 25. Drawing A360
- 26. Drawing A370
- 27. Drawing A371
- 28. Drawing A372
- 29. Drawing A508.1
- 30. Drawing A510.1
- 31. Drawing A510.2
- 00. Drawing 7.010.2
- 32. Drawing A512.1
- 33. Drawing A513
- 34. Drawing P001
- 35. Drawing P101A
- 36. Drawing P101
- 37. Drawing P102
- 38. Drawing E002
- 39. Drawing E003
- 40. Drawing E201
- 41. Drawing E301

End

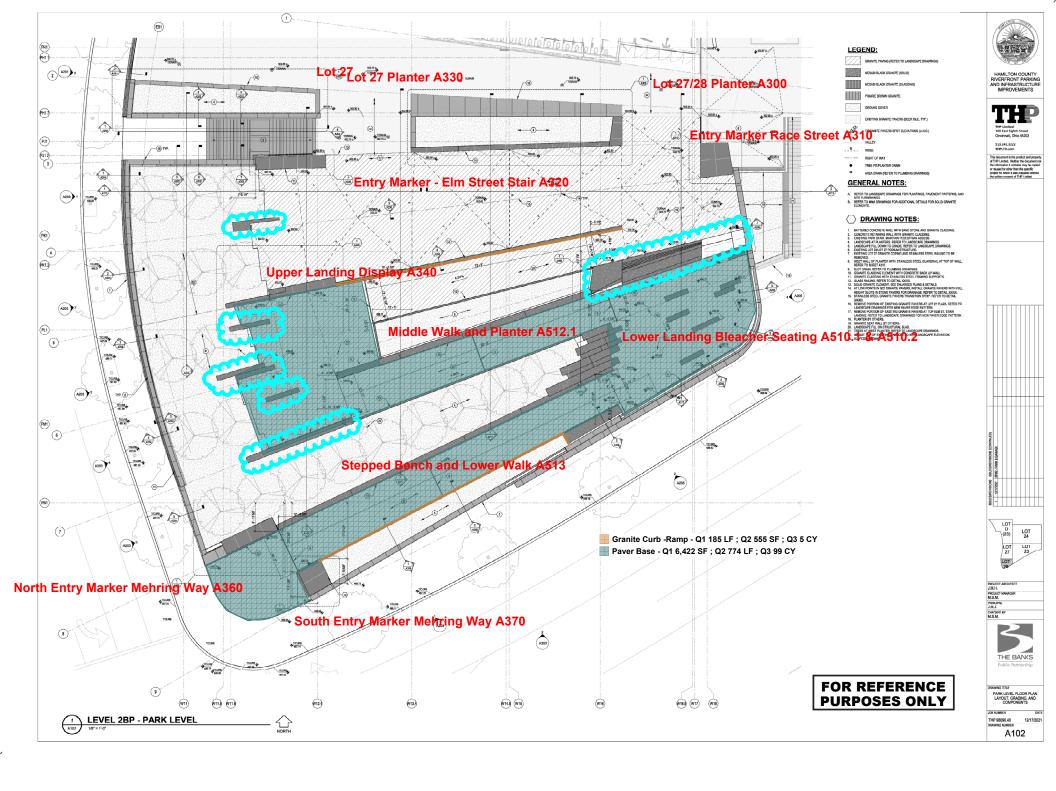

SECTION 000110 PROJECT MANUAL INDEX

Introductory Pages

Section 000110 Project Manual Index

000115 Drawing Index 000125 Project Directory

Bidding Requirements, Contract Forms, and Conditions of the Contract

Section 001000 Bidding Documents

001000.1	Advertisement for Bids (Legal Notice)
001000.2	Instructions to Bidders – AIA A701
001000.3	Additional Bid Conditions
001000.4	Bid Form
001000.5	Bid Guaranty and Contract Bond
001000.6	Certificate of Compliance, Ohio Department of Insurance -
	Hamilton County
001000.7	Non-Collusion Affidavit of Contractor
001000.8	Bidder's Certification Concerning Equal Employment
	Opportunity Requirements
001000.9	Personal Property Tax Statement
001000.10	Subcontractor and Material Supplier List
001000.11	The Banks Project SBE Program Summary
001000.12	Subcontractor Utilization Plan – (Form 2003)
001000.13	Statement of Good Faith Efforts – (Form 2007)
001000.14	Outreach/Good Faith Summary Sheet – (Form 2007-a)
001000.15	Warranty Against an Unresolved Finding For Recovery
001000.16	Homeland Security Declaration
001000.17	Responsible Bidder Certification
001000.18	Tax Statement Sheet
001000.19	Not Used
001000.20	Not Used
001000.21	Certified Check Form
001000.22	Registration Form
001000.23	Prevailing Wages and Prevailing Wage RateTables
	(See Appendix A)

003200	Geotechnical Data
005000	Agreement Form
006100	Contract Bond
006150	Escrow Agreement
007200	General Conditions
007319	Health and Safety Requirements
007319a	Safety, Health, and Environmental Requirements
008100	Project Safety Program
008260	Joint Policy for Small Business Enterprise, Economic Inclusion

and Workforce Development
008270 Responsible Bidder Requirements
009000 Contract Forms

Division 01 - General Requirements

Division of General nequirements	
011100	Summary of Work
012100	Allowances
012513	Product Substitution Procedures
013100	Project Coordination
013119	Project Meetings
013216	Construction Progress Schedule
013226	Construction Progress Reporting
013300	Submittals
013323	Shop Drawings, Product Data, and Samples
013543	Environmental Procedures
014000	Quality Requirements
014216	Definitions, Standards, and Regulatory Requirements
014516	Ground Penetration Requirements
015000	Construction Facilities and Temporary Controls
017329	Cutting and Patching
017700	Closeout Procedures and Submittals
	011100 012100 012513 013100 013119 013216 013226 013300 013323 013543 014000 014216 014516 015000 017329

Technical Specifications:

Division 02 -	Existing	Conditions
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Section	024100	Demolition
Section	024100	Demonuon

Division 03 – Concrete

Section 030100 Concrete Repair 033000 Cast-in-Place Concrete

Division 04 – Masonry

Section 042000 Unit Masonry

044213 Dimensional Stone Cladding

044302 Solid Granite

Division 05 – Metals

Section 055000 Metal Fabrications 057000 Ornamental Metals

Division 07 – Thermal and Moisture Protection

Section 071300 Sheet Membrane Waterproofing 071400 Fluid Applied Waterproofing

079200 Sealants

Division 08 – Openings

Section 081100 Steel Doors and Frames

087100 Door Hardware

Division 09 – Finishes

Section 099100 **Painting**

Division 10 – Specialties

Fire Protection Specialties Section 104400

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Division 21	- Fire Suppres	ssion
Section	210501	Basic Fire Suppression Requirements
	210502	Agreement and Waiver for Use of Electronic Files
	210502A	Electronic Files - Heapy Release Form to Contractors
	210504	Basic Fire Suppression Materials and Methods
	210505	Firestopping
	210507	Piping Materials and Methods for Fire Suppression
	210517	Expansion Loops for Fire Suppression Systems
	210519	Gauges for Fire Suppression Piping
	210529	Hangers and Supports for Fire Suppression Piping
	210533	Heat Tracing for Fire Suppression Piping
	210553	Identification of Fire Suppression Piping & Equipment
	211312	Fire Suppression Piping
	211313	Fire Suppression Sprinkler & Standpipe System
Division 22	– Plumbing	
Section	220501	Basic Plumbing Requirements
	220502	Agreement and Waiver for Use of Electronic Files
	220502A	Electronic Files - Heapy Release Form to Contractors
	220504	Basic Plumbing Materials and Methods
	220505	Firestopping
	000507	District Market in Land and Market and

Division 22	– Plumbing	
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	220502	Agreement and Waiver for Use of Electronic Files
	220502A	Electronic Files - Heapy Release Form to Contractors
	220504	Basic Plumbing Materials and Methods
	220505	Firestopping
	220507	Piping Materials and Methods
	220517	Expansion Loops for Plumbing Systems
	220523	General Duty Valves for Plumbing Piping
	220529	Hangers and Supports for Plumbing Piping
	220553	Identification of Plumbing Piping
	221116	Interior Domestic Water Piping
	221119	Interior Domestic Water Piping Specialties
	221316	Interior Drainage and Vent Systems
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	230502A	Electronic Files - Heapy Release Form to Contractors
	230504	Basic HVAC Materials and Methods
	230505	Firestopping
	230553	Identification of HVAC Piping & Equipment
	230923	Direct Digital Control System for HVAC
	230925	Instrumentation & Control Devices for HVAC

	230947	Control Power & Wiring for HVAC
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Section	260501	Basic Electrical Requirements
	260502	Agreement and Waiver for Use of Electronic Files
	260502A	Electronic Files – Heapy Release Form to Contractors
	260504	Basic Electrical Materials and Methods
	260505	Firestopping
	260519	Low-Voltage Electrical Power Conductors - Copper
	260526	Grounding and Bonding for Electrical Systems
	260533	Raceways and Boxes for Electrical Systems
	260553	Identification for Electrical Systems
	260565	Specific Wiring Applications
	260923	Lighting Control Devices
	262213	Distribution Transformers
	262416	Panelboards
	262716	Electrical Cabinets and Enclosures
	262726	Wiring Devices and Coverplates
	262813	Fuses
	262816	Disconnect Switches
	262913	Motor Controllers
	2020.0	Wester Germanene
	265113	Interior Luminaires, Lamps and Ballasts
	265114	Lighting Control Panels
	265115	Lighting Control System
	265200	Exit and Emergency Lighting
	265600	Exterior Lighting
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Division 31		E. d I
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	312000	Earth Moving
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	328400	Underground Irrigation System
	329113	Planting Soils
	329113.23	Structural Soil
	329300	Plants

Appendix A – Prevailing Wage Rates

334100 334600

Division 33 – Site Utilities

Section

END OF SECTION

Storm Drainage

Subdrainage

SECTION 000115 DRAWING INDEX

DRAWING TITLE

TITLE SHEET

SURVEY: (MSP)
TOPOGRAPHIC SURVEY

GENERAL: (THP)

G001 BUILDING CODE NOTES

CIVIL: (THP)

C101 SITE PLAN

CIVIL: (KLEINGERS)

C102 UTILITY PLAN
C102.1 STORM PROFILES
C102.2 STORM DETAILS

C103 GRADING PLAN

EROSION CONTROL: (KLEINGERS)

C104 EROSION CONTROL NOTES AND DETAILS C104.1 EROSION CONTROL NOTES AND DETAILS

ARCHITECTURAL: (THP/MMA) A001 GEOMETRIC LAYOUT

A100 SITE PLAN

A101 LOWER LEVEL FLOOR PLAN A102-S SUBSTRUCTURE LEVEL PLAN

A102 PARK LEVEL FLOOR PLAN, LAYOUT, GRADING, AND COMPONENTS

A200 OVERALL ELEVATIONS

A201 LOT 27 ELEVATIONS AND SECTIONS

A202 ELM ST. STAIR ELEVATIONS AND SECTIONS

A203 ELM ST. ELEVATIONS

A204 ELM ST. WALL SECTIONS

A205 MEHRING WAY ELEVATIONS

A206 MEHRING WAY WALL SECTIONS

A210 BUILDING SECTIONS

A211 BUILDING SECTIONS

A212 BUILDING SECTIONS

A213 BUILDING SECTIONS

A220 ARCHITECTURAL DETAILS

A230 PARK DETAILS

A240	RAILING DETAILS
A250	ELM STREET STAIR DETAILS
A260	CMU ELEVATIONS AND DETAILS
A300 A301 A302	LOT 27/28 PLANTER PLAN & SECTIONS LOT 27/28 PLANTER DETAILS LOT 27/28 PLANTER DETAILS
A310	RACE STREET ENTRY MARKER
A320	ELM STREET STAIR ENTRY MARKER
A330	LOT 27 PLANTER PLAN & SECTIONS
A340 A341	UPPER LANDING DISPLAY UPPER LANDING DISPLAY SECTIONS
A350 A351 A352	FOUNTAIN AND LOWER LANDING DISPLAY LOWER LANDING DISPLAY SECTIONS AND DETAILS FOUNTAIN SECTIONS
A360 A361	MEHRING WAY NORTH ENTRY MARKER MEHRING WAY NORTH ENTRY MARKER DETAILS
A370 A371 A372	MEHRING WAY SOUTH ENTRY MARKER MEHRING WAY SOUTH ENTRY MARKER E-W SECTION MEHRING WAY SOUTH ENTRY MARKER N-S SECTION
A508.1 A510.1 A510.2 A512.1 A513	UPPER LANDING DISPLAY & SEATING LOWER LANDING BLEACHER SEATING LOWER LANDING BLEACHER SEATING STEPPED BENCH & PLANTER @ MIDDLE WALK STEPPED BENCH @ LOWER WALK
A801	GUARDRAIL DETAILS
	APE: (TKG)
L100	HARDSCAPE PLAN
L200	LANDSCAPE SOILS PLAN
L300 L301 L302 L303	OVERALL LANDSCAPE PLAN LANDSCAPE ENLARGEMENT PLAN LANDSCAPE ENLARGEMENT PLAN PLANTING DETAILS
L400	DETAILS

IRRIGATION: (TKG)

L500 IRRIGATION PLAN L501 IRRIGATION DETAILS

STRUCTURAL: (THP)

S001 GENERAL NOTES AND TYPICAL DETAILS

S002 TYPICAL DETAILS S101 FOUNDATION PLAN

S102 UPPER LEVEL (503) FRAMING PLAN

S201 FOUNDATION DETAILS

S301 PILE CAP AND COLUMN DETAILS

S401 FRAMING DETAILS S402 FRAMING DETAILS

S501 TYPICAL BEAM DETAILS AND BEAM DIAGRAMS

S502 BEAM DIAGRAMS S503 BEAM DIAGRAMS

FIRE PROTECTION: (HEAPY)

F101 LOWER LEVEL FS PLAN

PLUMBING: (HEAPY)

P001 LEGEND SCHEDULES & NOTES

P101 LOWER LEVEL PLUMBING PLAN

P101A LOWER LEVEL PLUMBING PLAN (LOT 27)

P102 UPPER TERRACE LEVEL PLUMBING PLAN

HVAC: (HEAPY)

H001 HVAC SYMBOLS, NOTES, LEGENDS

H101 LOWER LEVEL HVAC PLAN (LOT 28)

H301 CONTROL SCHEMATIC H302 CONTROL SCHEMATIC

ELECTRICAL: (HEAPY)

E001 LEGEND AND INDEX

E002 SCHEDULES
E003 PANELBOARDS
E004 SINGLE-LINE
E005 DETAILS

E201 LIGHTING PLANS LOT 28

E301 POWER PLANS LOT 28

WATERPROOFING: (THP)

SW101 PARK LEVEL SUBSURFACE WATERPROOFING PLAN

SW201 WATERPROOFING SECTIONS SW301 WATERPROOFING DETAILS SW302 WATERPROOFING DETAILS

END OF SECTION

SECTION 011100 SUMMARY OF WORK

PART 1 GENERAL

1.01 GENERAL PROVISIONS OF BID PACKAGE #2 TRADE CONTRACTS

The following summary is a description of work for all Contract A. Descriptions for THE BANKS - PHASE 3C. Work related to the Project is as indicated on the Drawings and Specifications as prepared by THP Limited, Inc. This section describes and assigns work to each Contract as designated by the Construction Manager. Each Contractor shall cooperate and coordinate with all other Contractors for proper and expedient completion of the work in this Project. Each Contract Description identifies the major portions of Scope of Work to be performed by the Bidder in specific Contract Descriptions. This summary should in no way be construed as being all-inclusive. It is issued as a guide to aid in the assignment of work. Refer to the Drawings and Specifications for a detailed accounting of any work not explicitly specified or noted. Each Trade Contract Description lists specification sections included, in whole or in part, in that Contract Description. All work activities not explicitly specified or noted, but required to complete the work included in a Contract Description are a part of the work scope.

PART 2 TRADE CONTRACT DESCRIPTIONS

2.1 SECTION INCLUDES:

- List of Trade Contracts
- General Provisions of Bid Package #2 Trade Contracts
- 3. Contract Descriptions

2.2 LIST OF TRADE CONTRACTS

List of Bid Package #2 Trade Contracts:

TC-03 Concrete Structure and Site Concrete

TC-04 Park Finishes

- 2. General Provisions of Bid Package #2 Trade Contracts
 - A. Each Contractor shall be responsible for the proper protection of adjacent structures and public rights of way.
 - B. Prospective bidders are reminded that all of the contracts described herein contain specific Joint Policy for Small Business Enterprise, Economic Inclusion and Workforce Development for the Banks Project requirements.
 - C. Each Trade Contractor shall comply with the Responsible Bidder Requirements specified in section 001000 and herein.
 - D. All work is to comply with the rules and regulations of governing authorities having jurisdiction. Work shall be performed by skilled tradesmen having experience in performing the work.
 - E. Storage of all materials is limited and must be approved by the Construction Manager. Offsite storage of material may be required. All costs associated with material delivery in small quantities, relocation of materials that impede work progress, and off site material storage must be included in the bid.
 - F. A 48-HOUR NOTICE MUST BE GIVEN FOR DELIVERIES. IF NOTICE WAS NOT GIVEN DELIVERIES MAY BE TURNED AWAY. ALL COST ASSOCIATED WITH THIS ACTION WILL BE THE RESPONSIBILITY OF THE CONTRACTOR. ALL DELIVERIES MUST BE COORDINATED & APPROVED BY THE CONSTRUCTION MANAGER. NO PARKING BY EMPLOYEES OR DELIVERY VEHICLES IS PERMITTED ON SITE. STORAGE, TOOL OR OFFICE TRAILERS WILL NOT BE PERMITTED ON SITE WITHOUT THE PRIOR APPROVAL OF, AND IN COORDINATION WITH, THE CONSTRUCTION MANAGER.
 - G. Each Contractor is responsible to review the site and be familiar with all existing conditions within and around the building including local conditions and requirements. The impact of the site conditions on the cost of performing the work shall be included in the bid. Contractors shall notify the Construction Manager in writing of any discrepancies or conditions detrimental to proper performance of the Work.
 - I. Each Contractor to provide to all other trades information and materials, shop drawings, diagrams, templates, and embedments necessary for the coordination of the Work. It is each Contractor's responsibility to field verify and coordinate all interface with other trades.

- J. Where new work connects with existing, do all necessary cutting and patching required to make a satisfactory connection with the work to be performed under the Contract Documents so as to leave the entire work in a finished and workmanlike condition. This requirement shall include all required work where new items connect, fit, or otherwise interface with existing surfaces. Provide all labor and materials to this end, whether or not shown or specified. Verify and match existing conditions. This shall include full block replacement to nearest construction expansion joint of any concrete pavement removed or damaged.
- K. Each Contractor shall at all times maintain a clean and safe passage to all areas of the site, and for the public around the site.
- Each Contractor shall field verify all dimensions, materials and conditions of the existing site.
- M. Initial benchmarks and control lines will be provided by the Construction Manager. Each Contractor is responsible for all detailed layout and grade from the indicated benchmark and control points.
- N. Each Contractor is to coordinate all work with the work of other trades for proper function and sequence to avoid construction delays or additional cost.
- O. Each Contractor is responsible for daily cleanup and disposal of all debris associated with its work activities. This shall include removal of debris from public property and/or roadways caused by work on site or carried outside of the site by vehicles employed by the Contractor. Street cleaning of this debris is expected by each Contractor, as necessary. Debris not removed by the Contractors will be discarded at the delinquent Contractor's expense. All areas of work are to be broom cleaned at the end of each work day. In addition to daily cleanup each Trade Contractor to provide 1 person for every 4 Trade Contractor employee and their subs to a once a week jobsite general cleanup activity. Each Trade Contractor to provide its worker with all the necessary tools and equipment to do cleanup. There will be no tools or equipment provided by the Construction Management organization. Coordination of the weekly cleanup will be the responsibility of the General Trades Contractor. Designated eating areas will be identified by the Construction Manager. These areas will be the only place for workers to eat and drink. Workers found violating this policy maybe directed to leave the jobsite.
- P. Each Contractor shall be restricted to working hours of <u>7:00am to 4:00pm</u> unless alternate arrangements are approved by the Construction Manager. This does not alleviate the Trade Contractor's responsibility to work overtime as required to maintain the schedule.

- Q. Signs of any type are prohibited, except as specifically assigned by the Contract Documents.
- R. Each Contractor shall be responsible for the protection of its own materials, tools, equipment, and finish work until substantial completion is granted. Damage to or theft of any materials, tools or equipment prior to substantial completion will be repaired or replaced at the Contractor's expense.
- S. Each Contractor shall provide all temporary heat, utilities and protection required for the completion of all work as scheduled, except where specifically provided by others in the Contract Documents.
- T. Each Contractor shall have their superintendent attend all <u>weekly</u> Trade Contractor Meetings (time & location to be scheduled by Construction Manager).
- U. Each Contractor shall secure all permits required by governing authorities for the completion of its own work scope. This includes all Plumbing, HVAC, Traffic or permit that are issued by the City's Department of Transportation and Engineering, street barricade and other special permits. No Permits will be secured by the Construction Manager.
- V. Each Contractor shall submit daily reports and the weekly work plan twentyfour (24) hours before the weekly Trade Contractor meetings. Failure to submit these items each week for the prior week's work will result in rejection of this Contractor's pay request.
- W. Testing shall be performed in accordance with the Contract Documents. Where Owner and Contractor testing are specified, the Contractor shall provide complete testing. The Owner may provide additional testing at its discretion.
- X. Each Contractor is responsible for the complete review of, and coordination with, the Trade Contract Descriptions for other Contractors. Where overlap occurs, include the cost of such work in your bid, and the Construction Manager will decide which Contractor will perform this work. Appropriate credit will be deducted from the other Contractor's Contract.
- Y. Each Contractor must provide a full-time superintendent on site throughout the duration of their work on site. This superintendent shall be authorized to make all decisions relative to the work on site, and shall be the primary contact for all correspondence. Part time or token representatives who are not so authorized will not be permitted. Failure to comply with this requirement will result in rejection of this Contractor's pay request. Any change of superintendent shall be pre-approved by the Construction Manager.

- Z. Time is of essence on this project. Each Trade Contractor shall phase, construct and complete their work within the requirements included in Specification Section 013216 and the subsequent development of and updating of the Banks Phase 3C Bid Package 2 Schedule by the Construction Manager.
- AA. Each Contractor shall complete the Resource Utilization and Inclusion Tracking Forms that are included in the Specifications. The forms shall be completed on a monthly basis and submitted with the monthly pay request. Completed resource utilization forms must be submitted with the pay request in order for the pay request to be processed.
- AB. Each Contractor will be required to attend several phasing meetings pertaining to Lean Construction. Contractor shall have the appropriate personnel (more than one) attend the reverse phase scheduling meeting. Each Trade Contractor shall participate in the implementation of the Lean Construction process throughout the duration of the Project.
- AC. Safety hard hats, safety eye protection, High Vis, and Gloves shall be worn by all employees on this job site. This includes all of this Contractor's Subcontractors and Suppliers.
- AD. This Contractor shall comply with all requirements of the Williams-Stiger Occupational Safety and Health Act of 1970 and subsequent amendments thereto. This Contractor shall furnish to the Construction Manager a copy of its Safety Program, including a copy of its Hazardous Material Program, prior to the commencement of work on site. No payment will be made until these documents are received.
- AE. Any barricade or safety device removed by this Contractor's employees shall be immediately re-erected by Contractor. Upon failure to do so, the Construction Manager may direct the re-erection of it and the cost will be paid by the Contractor.
- AF. All shop drawings and submittals must be submitted within one week from Notice to proceed, unless otherwise specified. No pay request will be processed until all required submittals have been received.
- AG. Each Contractor shall provide personnel for traffic control and traffic coordination during all deliveries of material and equipment required in their scope of work. The Contractor shall coordinate all such activities with the Construction Manager and the City of Cincinnati, Department of Transportation and Engineering.
- AH. All portions of existing site and all utilities not part of the Work which are damaged, moved or altered in any way during construction shall be replaced or repaired to the County's satisfaction at the Contractors expense.

- AI. Each Trade Contractor shall include in their Schedule of Values (G702) a line item for their Small Business Enterprise spending. Each SBE should be shown separately.
- AJ. Each Contractor shall attend the pre-award conference. This conference will be scheduled by the Construction Manager. All trade contractors shall be notified in writing of the date the conference will be held.
- AK. Each Contractor shall update their record / as-built drawings on a monthly basis, the updated as-built shall be submitted to the Construction Manager by the 20th of the month. If the Contractors as-builts are not updated and submitted, the Contractors pay request for that month will not be processed.
- AL. Each Trade Contractor shall make good faith efforts to meet and/or exceed the project workforce participation goals as outlined in Section 008260 page 15.
- AN. To facilitate the punch list process, each Trade Contractor must complete its punch list items within 3 business days (excluding weekends) of receipt (via fax, email, or distribution to the site leader) of each punch list item. Failure to complete the punch list will result in a back charge for the total cost, to have others complete the work as designated by the Construction Manager.
- AO. Trade Contractor to identify recycle and waste management opportunities when assessing their scope of work. These items will be reviewed at the preaward meeting.
- AP. The flow of traffic on City streets and public walkways must be maintained at all times. It shall be this Trade Contractor's responsibility to obtain all permits and provide all labor and material that are necessary for street and sidewalk lane closures. All work involved that impacts existing streets and/or sidewalks or impedes public access in any way shall be coordinated through the Construction Manager **prior to the date of the work.**

- AQ. The Construction Manager will be utilizing a web-based information management system to facilitate communications among project partners including but not limited to Owners, Architects, Engineers, Construction Manager, and Trade Contractors. The system being utilized is Autodesk document management software. All trade contractors must have an e-mail address and access to the internet. Autodesk will be utilized for the following functions:
 - Project Contact Directory- this will be maintained by the Construction Manager
 - Requests for Information Management
 - Meeting Minutes Distribution
 - Posting of Official Notices and/or Communications
 - Submittal Management
 - Contract Document Management
 - Contract Drawings in PDF
 - Site Photographs
 - Punchlist Management
 - Field Work Order Management

The Construction Manager will issue user names and passwords to each Trade Contractor and will provide training and technical assistants to the user groups. Use of this system is mandatory. There will be no costs passed on to the users for access to the system or license fees. Users will be responsible for the costs associated with access to the internet.

AR. All Contractors shall use platform type ladders where ladders are necessary on this project. Other ladder types will not be allowed on site.

3. A. CONTRACT DESCRIPTION TC-03: Concrete Garage Structure

The Scope of Work in this Contract TC-03 includes all labor, material, tools, equipment, services, and supervision necessary to complete all work specified herein, in accordance with the Contract Documents, as described below to a complete functional safe and operating state.

Included is the Work as indicated in this Contract Description TC-03 the Drawings, the General Conditions and Division 1 of the General Requirements. This scope of work includes, but is not necessarily limited to, the following Specification Sections:

Bidding Requirements, Contract Forms and Conditions of the Contract

The following items represent specific inclusions in this Contract TC-03: Concrete Garage Structure. They are provided as a guide to aid in the assignment of work and in no way should be construed as being all-inclusive.

This Contract shall include:

- All work in this trade category is to be performed in accordance with the Specifications and with the recommendations of the Geotechnical Exploration report included in the documents as appendix B.
- 2. General Building Permit is provided by the Construction Manager. Any other required permits or licenses are the responsibility of this Trade Contractor for this work scope.
- 3. Contractor performing work must have all licenses and certifications as required by the specifications and/or authorities having jurisdiction.
- 4. Geotechnical monitoring and testing services are provided by others. This Trade Contractor shall coordinate and assist in the inspection and testing of all work on a daily basis.
- 5. Prior TC-01 Contractor Provided removal of the existing asphalt parking surface and gravel, Existing surface to be removed as work progresses to maintain a solid working surface. Review existing site condition prior to bid date.
- 6. Provide Mass Fill of structural fill per the documents. Fill material to be reviewed and approved by third party testing agency. Borrow site to be pre-approved.
- 7. Provide final grading of structural fill.
- 8. Protection of erosion during structural fill to be included to prevent soils from leaving site.
- 9. Street, sidewalk, and podium cleaning to be included for mud, debris, etc leaving the site caused by this contractor.

- 10. Provide locations for settling plates. Settling plates to be monitored as required by Third party testing agency. Settling to occur prior to site concrete work.
- 11. This Contractor shall include all excavation and backfill as needed for foundations (including grade beams) from the existing conditions. All borrow material or engineered fill shall meet the requirements of the specifications.
- 12. Demo of Sidewalks, curb cut, and other concrete located in the Right of Way to be by prior TC-02. Put back to be by TC-02 in Right Of Way. Demo of Concrete not in the ROW is by TC-01.
- 13. This contractor is responsible for the Concrete structure complete including Podium, grade beams located outside of the SOG footprint, battered walls, park site walls and granite back up walls, and other foundations within the park shall be included as part of this trade contract. Reinforcing steel shall be provided as part of this work scope. Pile Caps, Grade beams under the SOG, Columns, Basement Wall, and SOG were included in TC-01 Scope of Work.
- 14. Include sub surface concrete walk ways located under the granite pavers.
- 15. All concrete to receive waterproofing to include rubbing out and patching of pin holes, voids, etc as per waterproofing manufacturer requirements.
- 16. This contractor is responsible for providing all sealants, sealers and admixtures as required.
- 17. Cold Weather conditions to be accounted for as required.
- 18. Coordination with miscellaneous metals contractor shall be included for anchor bolts, embedded plates and other items imbedded in the concrete work. This contractor shall receive, inventory and install miscellaneous metal anchors, plates and sleeves as required for a complete, correct installation. Material shall be furnished and delivered by others. This contractor shall receive and set in place items which are to be cast into concrete structure. Layout shall be coordinated with the future miscellaneous metals contractor. This contractor shall be responsible for remedial work required if the anchors or plates are moved during concrete placement.
- 19. Provide and maintain temporary protection and plates to maintain safe access across site related to this work. All holes, trenches, etc are to be protected. A ramp (Earthen or built) is to be provided for access into all excavations
- 20. This contractor shall provide temporary safety railing around protective floor cover over openings in the concrete slabs as required to meet OSHA standards. This includes covers over the sleeve openings. Temporary Podium Slab edges railing to be included.

- 21. Slab tolerance shall be monitored by this contractor during and after each concrete placement. As-built information for each horizontal slab placement shall be provided the day after placement.
- 22. Spoil removal for this work scope is the responsibility of this Trade Contractor. All materials are to be removed from site and legally disposed as required for this scope of work.
- 23. Temporary water and temporary power required for this work scope shall be the responsibility of this Trade Contractor. Temporary power stations to be installed by TC-04.
- 24. Dewatering and/or mucking as required to complete this work scope shall be the responsibility of this Trade Contractor. All open holes/excavations shall be kept clean and free from water as required by the contract documents. This Trade Contractor shall provide barricades or other measures to protect the public and other workers on site from a fall hazard into excavations/holes.
- 25. This Trade Contractor shall include all reinforcing steel as required for a complete, correct installation. All deliveries, hoisting and rigging into place are to be provided by this Trade Contractor as required.
- 26. This Trade Contractor shall be responsible for dust control as required for this work scope.
- 27. Traffic control for this work scope is the responsibility of this Trade Contractor.
- 28. Only the washing of the chute will be permitted on site. Wash out of the concrete truck to be done at the batch plant. This contractor is responsible for clean-up of all dunnage from deliveries and hauling off-site within a timely manner.
- 29. Provide all layout and engineering from control points and benchmarks provided on survey drawings.
- 30. Coordination between TC-03 and TC-04 to be included. Granite shops are in progress and the structure will need to align with the Granite Shops. Asbuilts to be provided for Granite installers including slab edges, walls, etc to assure proper granite fitment.
- 31. This Trade Contractor shall employ a utilities location service to locate all utilities for location and elevation prior to commencement of any work on Site. Underground utilities that are to remain shall be permanently located, maintained and protected with signage and barricades until completion of Contract Time.
- 32. This Trade Contractor shall include any necessary permits required for temporary road shutdowns if required to perform this work scope.
- 33. All hoisting associated with this Trade Contract is to be included in this work scope.
- 34. Reference Section 017419 for removal of all debris.
- 35. The temporary plywood protection shown at the existing garage will be provided and maintained by others.
- 36. This contractor to include demo of the existing railings. This includes

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- the concrete curb located on the existing stairs at the 515 level. Railings to be turned over to the Construction Manager in a protected manner. Railings are to be maintained until a safe condition is met.
- 37. This Contractor shall account for the potential of Class C soils when performing this scope of work. This shall include the forming of pile caps as required. OSHA/Messer safety standards shall be maintained when constructing gradebeams in regards to the sloping of excavations and employee entry.
- 38. Include allowance of 2,000lbs of rebar including labor to be installed at the CM direction.
- 39. This Trade Contractor shall include a \$ 50,000 allowance to account for potential design changes initiated by the Owner.

B. CONTRACT DESCRIPTION TC-04: Park Finishes

The Scope of Work in this Contract TC-04 includes all labor, material, tools, equipment, services, and supervision necessary to complete all work specified herein, in accordance with the Contract Documents, as described below to a complete functional safe and operating state.

Included is the Work as indicated in this Contract Description TC-04 the Drawings, the General Conditions and Division 1 of the General Requirements. This scope of work includes, but is not necessarily limited to, the following Specification Sections:

Bidding Requirements, Contract Forms and Conditions of the Contract

General Requirements

Section 024100 Demolition
Section 321216 Asphalt Paving
Section 321723 Pavement Markings

The following items represent specific inclusions in this Contract TC-04: Park Finishes. They are provided as a guide to aid in the assignment of work and in no way should be construed as being all-inclusive.

This Contract shall include:

- 1. All work associated with Lot 28 parks scope. Park scope is typically defined as any work above structural concrete deck
- 2. General Building Permit is provided by the Construction Manager. Any other required permits or licenses are the responsibility of this Trade Contractor for this work scope.
- 3. Geotechnical monitoring and testing services are provided by others. This Trade Contractor shall coordinate and assist in the inspection and testing of all work on a daily basis.

- 4. Temporary Toilets, dumpsters, and site fencing to be by TC-02. Temporary fall fencing, plates, covers, etc to be included as required for this scope of work.
- 5. Concrete Topping slabs and sub structure concrete to be by TC-03
- 6. The Concrete structural podium and site concrete by TC-03.
- 7. Waterproofing and expansion joints to be included. Subsurface and surface expansion materials to be included.
- 8. Contractor to furnish and install a complete waterproofing system per the documents. Waterproofing to be installed as structural decks are completed. Coordination with TC-03 scope to be included. Drainage board and root barrier to be installed with any means required to prevent movement until soils, gravel, topping slabs, granite, etc are placed on top.
- 9. Waterproofing to be inspected by a third party provided by the owner.
- 10. Waterproofing penetrations to be included. Additional detailing as required for railings, bollards, structures, etc.
- 11. Repair of existing waterproofing to be included as required per the documents.
- 12. Site signage to be included.
- 13. This Contractor shall include all excavation and backfill as needed. All borrow material or engineered fill shall meet the requirements of the specifications.
- 14. This contractor is responsible for providing all sealants, sealers and admixtures as required for the Parks scope of work.
- 15. Provide all preparation, priming and painting on ceilings, metals, doors/frames, conduits and masonry as shown in the plans. Include any Masonry water repellant.
- 16. Protect all surfaces not to be painted remove over-spray from these items as required.
- 17. Provide a second trip to each area to touch-up and paint MEP items not previously installed. Include homerun conduits to be installed within existing garages.
- 18. Furnish and install all permanent fire extinguishers and cabinets.
- 19. A thorough cleaning with the use of a fire hose having the necessary pressure is to be provided for as a form of final cleaning and acceptance, also required prior to striping.
- 20. Provide all parking stall, striping, blocks including directional arrows and HC markings as shown on the plans.
- 21. Stripe garage per plans.
- 22. Include all required bollards including stainless steel. Removal of existing by TC-02. Reinstallation to be included by TC-04.
- 23. Provide and install all required sleeves for scope of work associated with this Trade Contract.
- 24. This contractor is to include coordination with all trades for sleeves. This contract to include installation of all sleeves required for TC-04. Include coring for all locations missed. This contractor to be responsible for reinforcing details located at sleeved opening per

- the documents. Each Trade Contract is to be responsible for their own sleeve installation. This contractor is responsible for maintaining sleeve locations and orientation before and during concrete pours, granite installation, etc.
- 25. This Contractor shall provide a complete electrical scope as shown within the documents for all park level and garage level including but not limited to conduit, wire, light fixtures, light poles, lighting controls, panels, and all associated shut downs.
- 26. This Contractor shall furnish and install power to all equipment/fixtures. Hook up all equipment/fixtures at the machine and/or disconnect panel is to be provided for. Provide all fuses and disconnects required per code to make equipment operational.
- 27. Furnish and install all conduit and wiring for lighting
- 28. Furnish and install concrete curbs and pads for equipment as needed and/or as required by code.
- 29. This Trade Contractor shall include all off hours work required for the specific tie-ins and or shutdowns for this Bid Package.
- 30. This Trade Contractor will be responsible for fire stopping and sealing of penetrations through fire rated and non-rated construction. This Trade Contractor to submit UL drawings on how they plan to handle each different type of penetration through rated partitions. These details are to be strictly adhered to in the field and each penetration is to be labeled with the UL number.
- 31. Trade Contractors responsibility to coordinate all work and provide all conduit, anchor bolts etc. as required for light pole to function as designed. Pole bases to be by TC-04.
- 32. City Light Pole Rework as shown on L100 to be included. Demo, rework, pull boxes, conduit, wiring, etc to be included per DOTE requirements. Poles to be removed and safely stored during construction. Storage to be located in Lot B gravel area.
- 33. Contractor to provide and install light poles located in Lot 28.
- 34. Provide CO Monitoring system extension per the drawings.
- 35. Provide a pull string for all empty conduits that are to be installed.
- 36. Contractor to provide lighting submittals, schedule, and delivery dates within 2 week of contract.
- 37. This contractor shall provide a complete plumbing scope installation. To include but not limited to domestic/irrigation water line from Lot 27, booster pumps, back flows, irrigation connection, risers, under drains, slot drains etc. Drain bodies shown cast into structural podium/tree pits to be included. Coordination and installation with TC-03 to be included. TC-01 will provide the underground scope of work with a stub up for connection. Final connection or adjustment by TC-04.
- 38. Include complete Fire suppression extension from Lot 27 dry system.
- 39. Provide and maintain temporary protection and plates to maintain safe access across site. Protection of work as required to assure quality.

- 40. Spoil/trash removal for this work scope is the responsibility of this Trade Contractor. All materials are to be removed from site and legally disposed. Dumpsters provided by TC-02.
- 41. Temporary power shall be the responsibility of this Trade Contractor. Provide temporary power stations at ground and park level. Include two power post containing 8 receptacles with enough power to adequately supply them.
- 42. Railing scope to be by others. Include coordination between waterproofing, granite contractor and railing installation.
- 43. Provide Stone scope of work minus horizontal unit pavers.

 Horizontal unit pavers to be provided by and installed by others.

 Pavers and all Stone Shop drawings to be completed by previously TC-10 contractor. This Contractor to include coordination with the unit paving contractor.
- 44. Furnish and install complete granite/Stone scope per the construction documents. To include but not limited to: granite coping, stair treads, seat walls, cladding, decorative features, etc.
- 45. Granite/Stone to match existing Smale Park standard color, texture, and quarry. Samples to be provided and approved prior to material release.
- 46. Granite installation to be sequenced with waterproofing and railing installation..
- 47. Granite pavers thickness as shown on the drawings.
- 48. Mortar, setting beds, polymeric sand, and other installation materials to be included.
- 49. Material and installation to be delivered and installed in phases/sequences as the project progresses.
- 50. On site storage is limited. Limited lay down areas for granite to be provided within Lot E fenced area. Additional areas maybe available but are not guaranteed.
- 51. Remove existing granite per the construction documents, store, clean, and reinstall as shown.
- 52. Include stone cladding at perimeter walls.
- 53. Include all engineering for granite installation. **Shop drawings by others.** This includes clips, fasteners, methods, etc.
- 54. Provide all required mounting hardware, angles, ledges, etc.
- 55. Include all metal frames, misc metals, framing, CMU etc as required to install the granite/stone. This is to include the frame and associated installation work located along Elm St. Concrete back up by TC-03.
- 56. Include all CMU walls and back up including dowels, grouting, head joints, grouting, head angles, caulk joints, etc. Water Repellant to be included on CMU exposed to view.
- 57. Furnish and install complete landscaping and irrigation system.
- 58. Provide complete irrigation system including integration with existing systems. Rework Zoning as required.
- 59. Include irrigation system at applicable tree pits and plantings.

- 60. Irrigation system including but not limited to controller, piping, valves, boxes, zoning, controller, wiring, conduit, sleeves, heads, sprayers, and hose down quick disconnects. Irrigation connection to be connected to existing system.
- 61. Soil, trees, plants, shrubs, etc to be included.
- 62. Tree Pit and planter Under drains, corner drains, aeration, etc to be included.
- 63. Tagging of species to be regionally source and approved with architect and owner present.
- 64. Planting materials to be transplanted in appropriate seasons to maintain proper warranties.
- 65. Mulch and sod to be included where applicable.
- 66. Include tie downs, restraints, edging, and other installation systems as noted on construction documents.
- 67. Dewatering as required to complete this work scope shall be the responsibility of this Trade Contractor. All open holes/excavations shall be kept clean and free from water as required by the contract documents. This Trade Contractor shall provide barricades or other measures to protect the public and other workers on site from a fall hazard into holes.
- 68. All deliveries, hoisting and rigging into place are to be provided by this Trade Contractor as required.
- 69. This Trade Contractor shall be responsible for dust control as required for this work scope.
- 70. Traffic control for this work scope is the responsibility of this Trade Contractor.
- 71. Provide all layout and engineering from control points and benchmarks provided on survey drawings.
- 72. This Trade Contractor shall include any necessary permits required for temporary road shutdowns if required to perform this work scope.
- 73. Reference Section 017419 for removal of all debris.
- 74. The temporary plywood protection shown at the existing garage will be provided and maintained by others.
- 75. This Contractor shall provide all hangers and inserts as required for a complete, correct installation.
- 76. Contractor to include Site furnishings relocation, new furnishings, and installation per manufacturer requirement/details.
- 77. A thorough cleaning having the necessary equipment and materials is to be provided for as a form of final cleaning and acceptance, as required prior to turn over including stone and stainless features.
- 78. This Trade Contractor shall include all off hours work required for the specific tie-ins
- 79. Provide all applicable warranties, maintenance, etc per the construction documents.
- 80. This Trade Contractor shall include a \$ 100,000 allowance to account for potential design changes initiated by the Owner.

End of Section

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DIVISION 7 – THERMAL AND MOISTURE PRETECTION SECTION 071300

SHEET MEMBRANE WATERPROOFING

PART 1 GENERAL

1.1 SUMMARY

A. Section Includes

- 1. All labor, material, equipment, special tools, and services required to install the sheet waterproofing system required for the project as indicated on the Drawings and in the Specifications, including but not limited to the following:
 - a. Preparation and cleaning of substrates.
 - b. Crack and other detailing work.
 - c. Waterproofing system including primer or liquid applied surface conditioner, sheet membrane waterproofing, and drainage mat.

B. Related Sections

- 1. Section 030100: Concrete Repairs.
- 2. Section 071400: Fluid Applied Waterproofing.

1.2 REFERENCES

- A. American Society for Testing and Materials (ASTM):
 - 1. ASTM D-4491: Standard Test Method for Water Permeability of Geotextiles by Permittivity.
 - 2. ASTM D 4632: Standard Test Method for Grab Breaking Load and Elongation of Geotextiles.
 - 3. ASTM D 4751: Standard Test Method for Determining Apparent Opening Size of a Geotextile.
 - 4. ASTM D 4833: Standard Test Method for Index Puncture Resistance of Geotextiles, Geomembranes and Related Products.

1.3 DEFINITIONS

A. The term "manufacturer's recommendations," or variations thereon shall mean "manufacturer's recommendations which are found in publications available to and commonly used by the general architectural and consulting professions.

1.4 SUBMITTALS

- A. Literature for manufactured products, including manufacturer's specifications, test data, installation instructions and applicator's manual.
- B. Letter of applicator approval from the manufacturer per Paragraph 1.5.B.

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- C. Letters of experience per Paragraph 1.5.C.
- D. Letter from manufacturer stating their system as specified is suitable for use in this project per Paragraph 3.4.A.
- E. Material Safety Data Sheets on all materials.
- F. Upon completion of the work and before final payment provide fully executed warranties.

1.5 QUALITY ASSURANCE

A. Applicable Codes:

- 1. The Contractor shall comply with all Federal, State and Municipal laws, codes, ordinances and regulations applicable to the Work in this Contract and also with all requirements of the National Fire Protection Association, the National Electric Code, and the Occupational Safety and Health Administration (OSHA). If the above laws, codes or ordinances conflict with this Specification, then the laws, codes or ordinances shall govern, except in such cases where the Specification exceeds them in quality of materials or labor, then the Specifications shall be followed.
- 2. If the above laws, codes or ordinances conflict with the Specification, then the laws, codes or ordinances shall govern, excerpt in such cases where the Specification exceeds them in quality of materials or labor, then the Specifications shall be followed.
- B. The membrane system applicator shall be approved by the manufacturer prior to the start of work.
- C. Membrane applicator's lead personnel (field superintendent and foreman) in charge of the work shall each have the following experience:
 - 1. Three (3) verifiable years of experience supervising the application of the membrane system being provided on this project.
 - 2. Successfully installed three (3) membrane projects of similar size, type and using the same membrane system being provided on this project.
- D. Membrane applicator's lead personnel shall be present for all field operation pertaining to this waterproofing system installation.
- E. The Owner reserves the right to request different lead personnel if, in the Owner's opinion, those assigned to the project are not qualified by way of experience or ability to perform the Work. Comply with the Owner's request at no additional cost.
- F. Substrate Compatibility:
 - 1. The manufacturer and contractor shall:
 - d. Jointly review and inspect the substrate materials to which the new waterproofing membrane is intended to be applied.

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- e. Perform tests as necessary to ensure compatibility and verify the absence of materials - visible and invisible - detrimental to the application or performance of the waterproofing membrane.
- f. Review materials specified elsewhere in the Construction Documents to which the waterproofing membrane is intended to be applied.
- g. The hot applied fluid applied membrane to be compatible with sheet membrane waterproofing. If different manufacturers are used, a letter from both manufacturers noting the products are compatible is required
- 2. If inspections, tests or review of materials and substrate reveal conflicts of compatibility with the intended waterproofing membrane provide written evidence of the compatibility conflict to the Owner prior to ordering of materials.
- By beginning the waterproofing system (including substrate preparation), the Contractor accepts the responsibility for ensuring the performance of the waterproofing system.
- 4. If the Contractor fails to submit proof of incompatible materials, and if failure of the waterproofing system is a result of chemical or physical incompatibilities with existing or specified products or materials, the Contractor is responsible for all costs related to correcting the deficient work and for all direct and indirect costs to the Owner.

G. Testing:

- 1. The Owner may perform tests to ensure compliance with the Contract Documents and manufacturer's requirements.
- 2. If tests reveal noncompliance, correct deficiencies in a manner approved by the Owner and the manufacturer at no additional cost.
- 3. Except as otherwise specified, the Owner will pay the cost of the tests, including repair and patching of test areas.
- 4. Where tests reveal deficiencies in the membrane materials or installation, the costs of the tests, and repair and patching of the test areas shall be borne by the Contractor.
- H. Air compressors shall be equipped with functional oil and water separators.

1.6 PRODUCT DELIVERY, STORAGE AND HANDLING

- A. Deliver materials to job site in sealed, undamaged containers. Identify each container with the material's name, lot number and date of manufacture.
- B. Store membrane materials in a place specifically assigned for that purpose and which is well ventilated, lighted and not subject to direct sunlight.
- C. Heat or cool the storage area to maintain temperatures within the range recommended by the membrane manufacturer.

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- D. Keep membrane materials sealed in original containers when not in use.
- E. Keep storage area neat and clean.
- F. Do not overload or otherwise distress the structure.
- G. Handle membrane system materials in strict accordance with safety and weather limitations required by product literature or as modified by applicable rules and regulations of Local, State and Federal authorities having jurisdiction.
- H. When using toxic or flammable solvents, take necessary precautions as recommended by the manufacturer. The handling and use of toxic or flammable solvents, including adequate ventilation and personal protective equipment, shall conform to the requirements of the applicable safety regulatory agencies.

1.7 JOB CONDITIONS – WEIGHT RESTRICTIONS AND MOVEMENT

- A. The Contractor shall use equipment for membrane installation on structured concrete slab areas with the following weight restrictions:
 - 1. The maximum wheel load shall not exceed 2,000 lbs.
 - 2. The maximum distributed load shall not exceed 90 psf.
 - 3. Wheel base of loaded equipment shall not exceed 5 feet.
 - 4. Equipment positioning, movement and orientation is subject to Engineer and Owner review.

1.8 WARRANTY

- A. The completed installation shall be warranted by the manufacturer against defects of materials, and by the Contractor for defects in workmanship for a period of ten (10) years, beginning with the date of substantial completion for the Project.
- B. The warranties shall not require the signature of the Owner.

PART 2 PRODUCTS

2.1 MEMBRANE MATERIALS

- A. Sheet applied waterproofing membrane, approved manufacturers:
 - 1. Blueskin WP200 by Henry Company.
- B. Primer: As recommended and approved by the manufacturer.
 - 1. Aquatac Primer.
- C. Surface Treatment: As recommended and approved by the manufacturer.
- D. Drainage Sheet/Protection Layer: As recommended and approved by the manufacturers.
 - 1. Henry DB 520.

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- E. Filter Fabric, approved manufacturers:
 - 1. Mirafi 180N by TenCate Geosynthetics Americas.
 - 2. Alternative Woven drainage fabric with the following characteristics:
 - h. Grab Strength per ASTM D4632: 205 lbs.
 - i. CBR Puncture Strength per ASTM D6241: 500 lbs.
 - j. Equivalent Opening Size per ASTM D4751: 80 U.S. Sieve.
 - k. Water Flow Rate per ASTM D4491: 95 gal/min/SF.
- F. Adhesives and Sealants:
 - 1. Henry 925 BES Sealant.
 - 2. Polybitume 570-05 Sealant Compound.
- G. Termination Bar: One inch wide by one-eighth inch thick stainless steel bar, predrilled at six inches on center to receive fasteners.
- H. Anchors: 1/4" diameter stainless steel Metal Hit Anchor by Hilti Corp.
- I. Sheet Metal Flashing:
 - 1. 26 ga. stainless steel.
 - 2. Size as indicated on Drawings.

PART 3 EXECUTION

3.1 PREPARATION

- A. Surface Preparation:
 - Perform final surface preparation and cleaning procedures in accordance with this Section unless the waterproofing system manufacturer has more stringent requirements. Apply membrane only to clean, dry prepared surfaces.
 - Existing surfaces scheduled to receive membrane shall be clean having all dirt, debris, concrete, water and saw cutting slurry, protection sheet and existing insulation removed from the surface.
 - 3. Do not use acids or water blasting in surface preparation work.

B. Protection:

- 1. Do not allow construction equipment or other trades on prepared and cleaned substrate.
- 2. Do not store materials or equipment on prepared and cleaned substrate.
- 3. Do not allow construction traffic personnel to traverse across prepared and cleaned substrate.

3.2 DETAIL APPLICATION

A. Before final surface preparation, examine exposed substrates intended for adhered liquid flashing for cracks and joints. Detail all such cracks and joints after surface preparation in accordance with manufacturer's recommendations.

3.1 MEMBRANE INSTALLATION

- A. Provide a total sheet membrane system which the manufacturer agrees in writing is suitable for this project. This Section specifies the minimum system installation specifics required for the work.
 - 1. Apply sheet membrane or liquid flashing materials in accordance with the manufacturer's instructions.
 - 2. Do not apply waterproofing in wet weather or on damp concrete surfaces.
 - 3. Follow manufacturer's minimum temperature recommendations for installation.
 - 4. Install waterproofing on walls before installing on roof slab.
 - 5. If a portion must be left partially complete, finish exposed edges of outside strip with a trowel bead of mastic.

B. Application

- 1. Roll waterproofing sheet into primed surfaces to a smooth finish without wrinkles or air spaces, with a side lap and end lap of not less than 2-1/2 inches.
- 2. Apply waterproofing in double thickness over any joints.

3. Termination:

- a. Top of wall: Roll down firmly top edge of waterproofing on vertical surface and finish with a trowel bead of mastic per manufacturer's standard details.
- b. Base of wall: Install ¾ inch, continuous sealant cove at base of vertical surface. Continue membrane across horizontal surface of footing. Terminate on vertical surface of footing per manufacturer's standard details. Seal terminations with mastic.
- 4. Lap and adhere horizontal waterproofing onto vertical waterproofing minimum 12 inches.
- 5. Inspect waterproofing prior to application of protection board. Patch any holes, tears, or misaligned seams with waterproofing.
- 6. Apply protection board over waterproofing as work progresses.

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3.2 DRAINAGE BOARD:

- A. Provide drainage board/ root barrier on all surfaces, including vertical surfaces, as indicated.
- B. Begin installation at low point of deck area and proceed to high point. Panels shall be butted tightly.
- C. Overlap drainage fabric in shingle fashion between abutting panels. Minimum overlap of fabric onto adjoining panel shall be 2".
- D. Seal fabric overlap to abutting panel fabric with mastic as approved by the drainage board manufacturer. Install a minimum 1/4" wide continuous bead of mastic between overlap areas.
- E. Where drainage board terminates at walls or other projections, wrap filter fabric over exposed edge and terminate on underside of board. Extend filter fabric a minimum of 1-1/2 inches onto underside of board.
- F. Temporarily weight drainage board to maintain in place until next phase of work. Size and type of weight provided shall not damage previously complete waterproofing work or drainage board.
- G. Cover drainage board promptly with next phase of work. Do not allow drainage board to be exposed for more than seven days. If drainage board is scheduled for exposure beyond seven days, install a supplemental layer of filter fabric to protect against excessive dirt and debris buildup as well as UV exposure. Remove and discard filter fabric prior to the installation of permanent overburden materials.
- H. On vertical wall surfaces, terminate drain board at bottom of walls:
 - 1. Wrap filter fabric over exposed edge of drainage board per Item 3.4, E above.
 - 2. At two sided formed foundation wall, terminate drainage board at bottom of perimeter drain tile.

3.3 FIELD QUALITY CONTROL

A. Manufacturer's Field Service

- A technically competent employee of the waterproofing membrane manufacturer (the technician), not associated with the Contractor or the installation crew shall be on site before the first installation of the membrane system. Provide resume of experience and credentials for Approval to Owner.
- The technician shall remain on site for the length of time necessary to observe the preparation and installation of 20% of waterproofing system, including the drainage mat.
- 3. Do not begin application of the waterproofing membrane system until the technician has approved the preparation, cleanliness, and surface texture of the substrate.


The Banks – Lot 28 BP #2 – Park & Garage Addendum #2 January 13, 2022 THP No. 98090.40


4. The technician shall review all Contractor application techniques and procedures and shall advise the Contractor when, where and as required to obtain specification compliance.

3.4 CLEAN-UP

- A. During the progress of the work, remove from the project all discarded materials and debris.
- B. Clean all surfaces affected by work of this Section and repair all damage caused to adjacent construction or property, at no cost to the Owner.
- C. Leave adjacent premises clean and free of construction dirt and debris that resulted as part of the construction process.
- D. Remove empty containers from the facility at the end of each working day.
- E. Place soiled cloths that constitute fire hazards in suitable metal safety containers or remove them from the site at the end of each working day. Take special care in storage or disposal of flammable materials. Comply with health and fire regulations.


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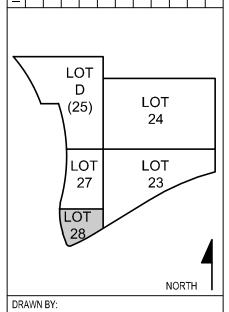


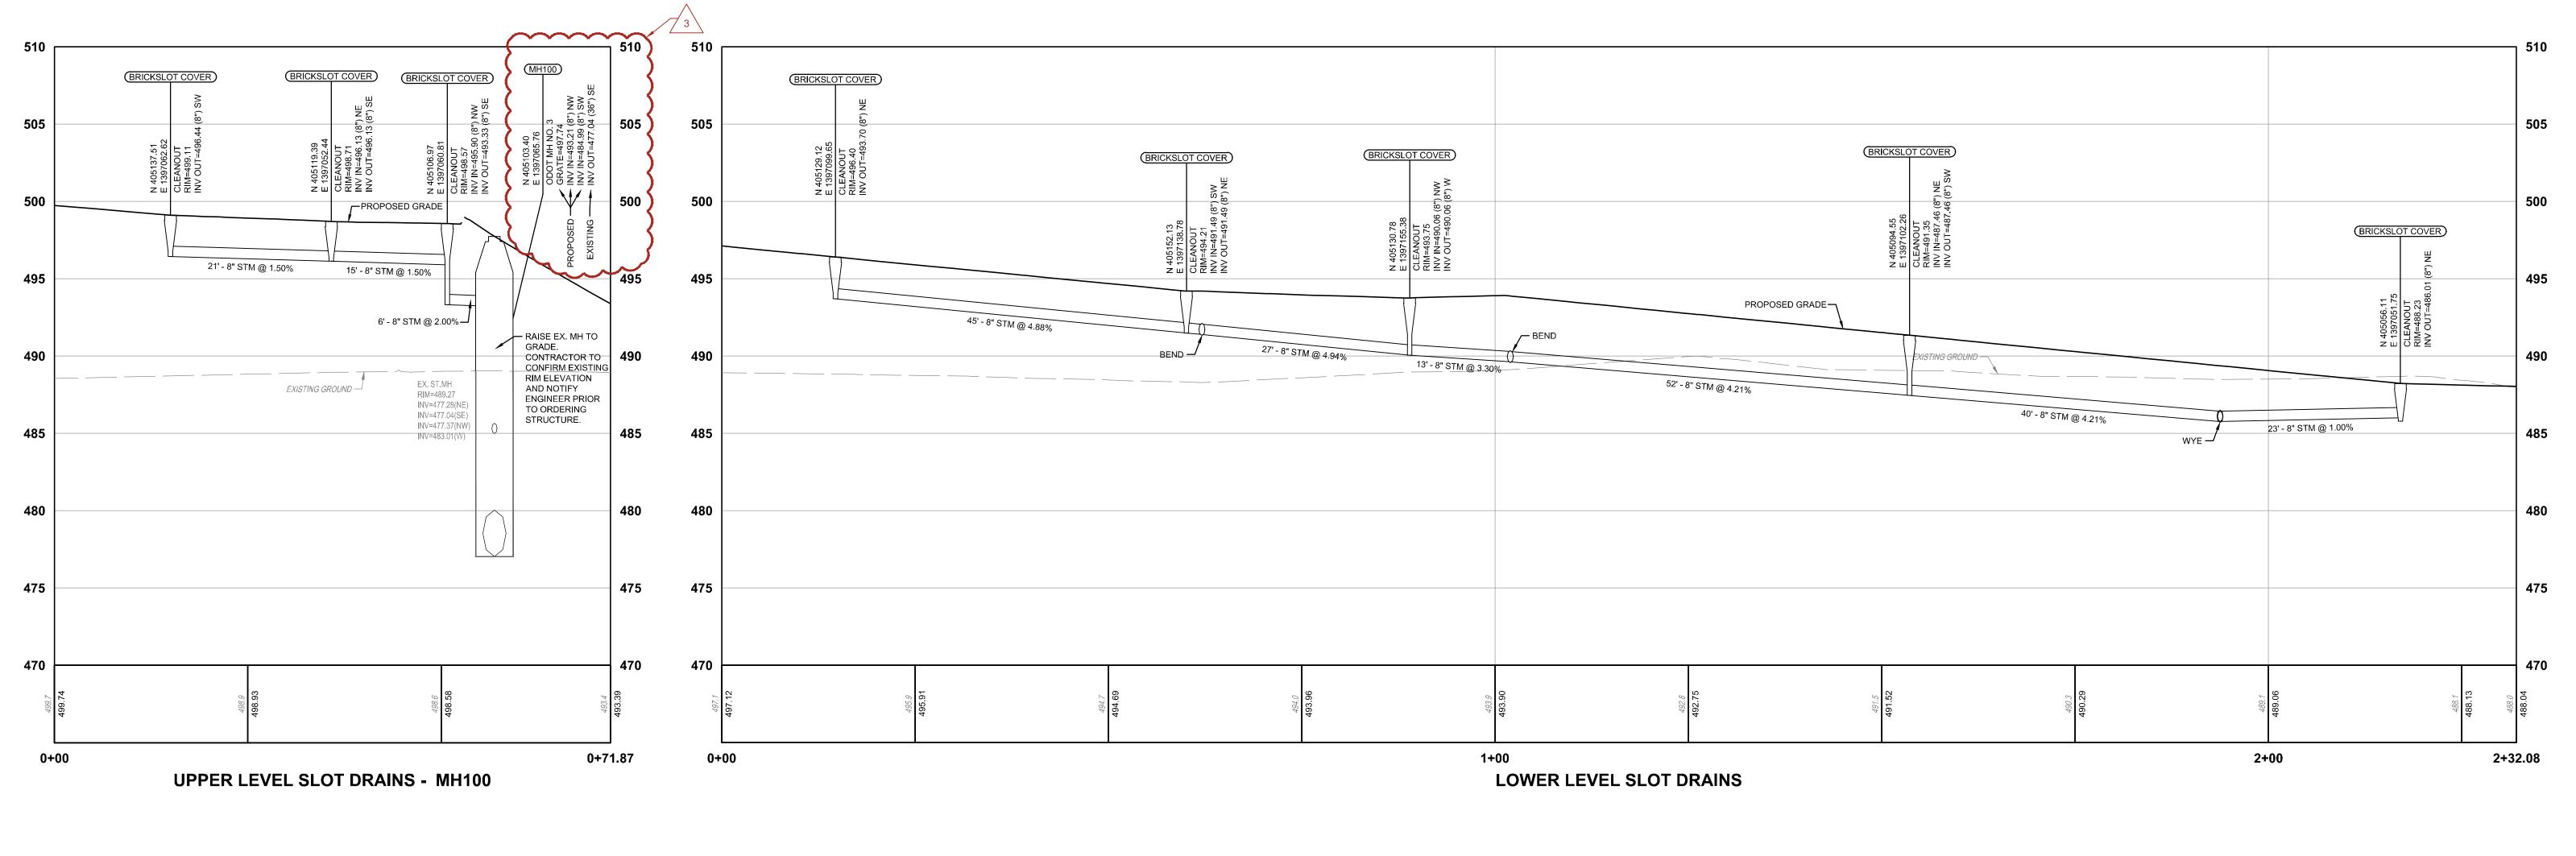

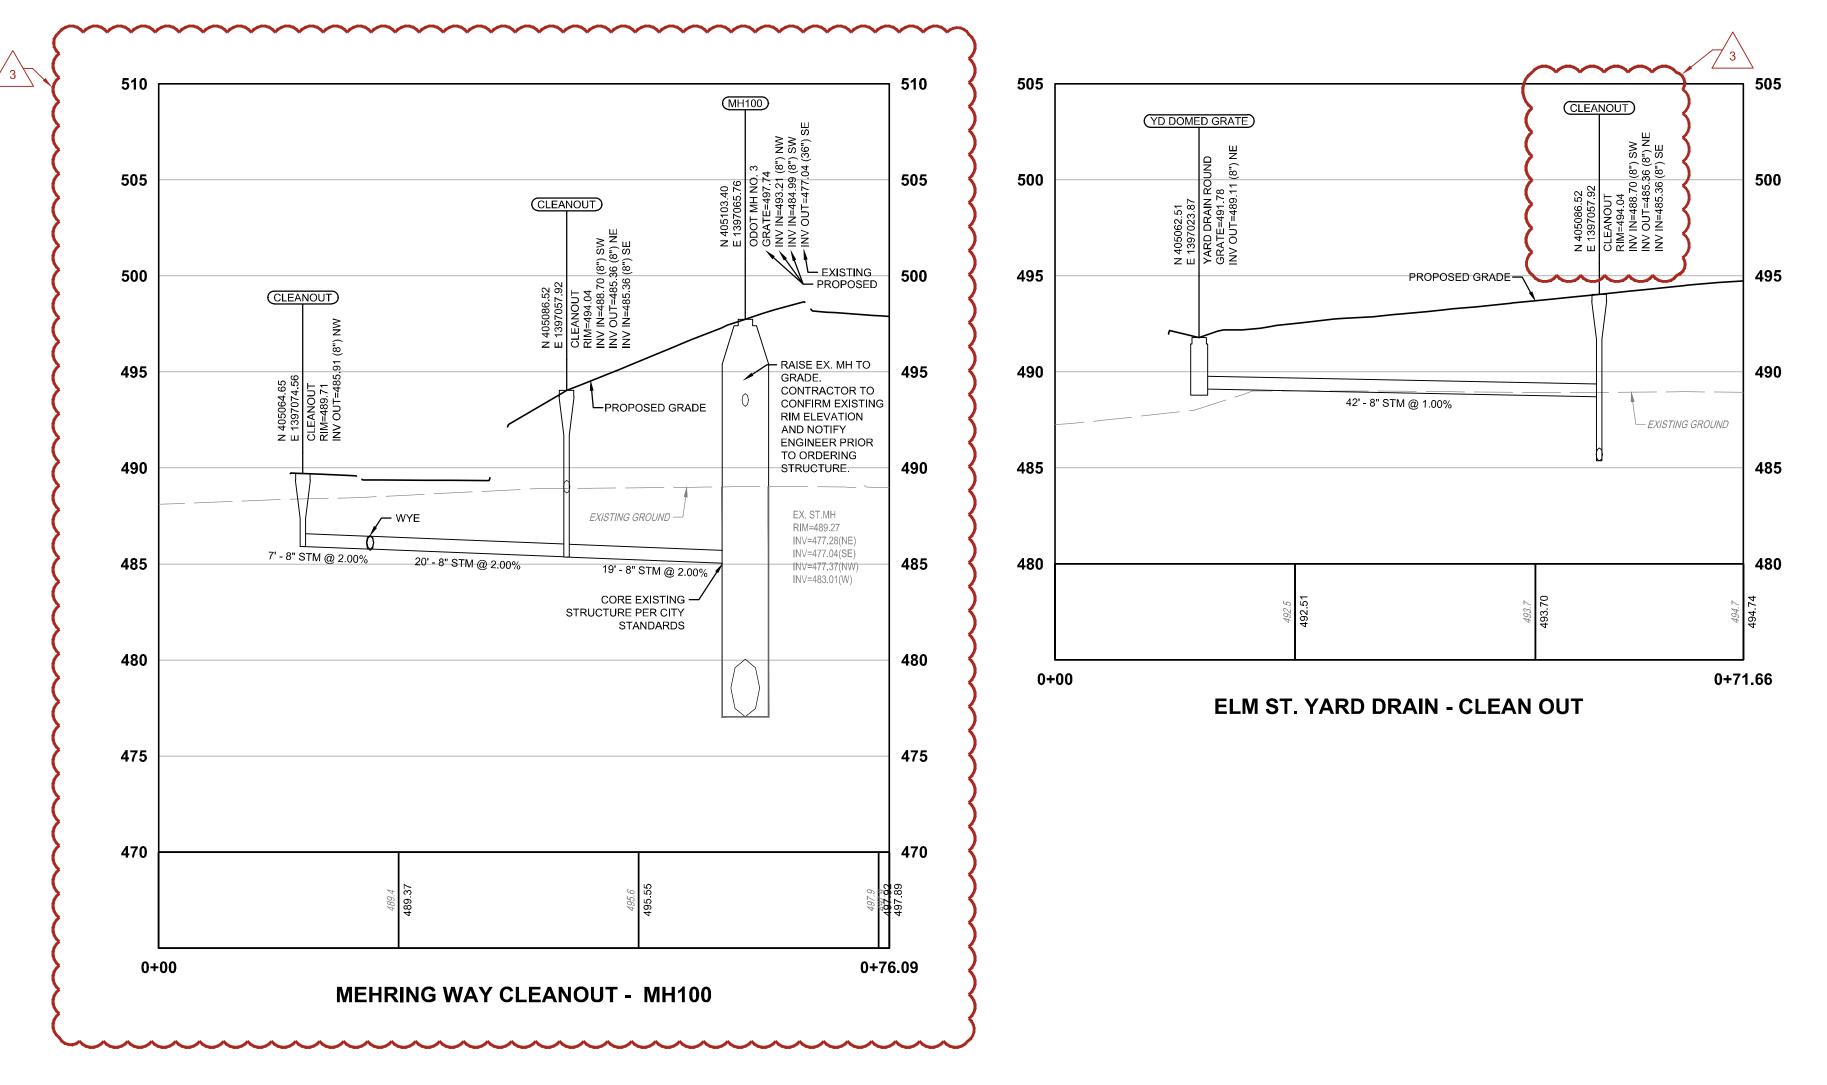





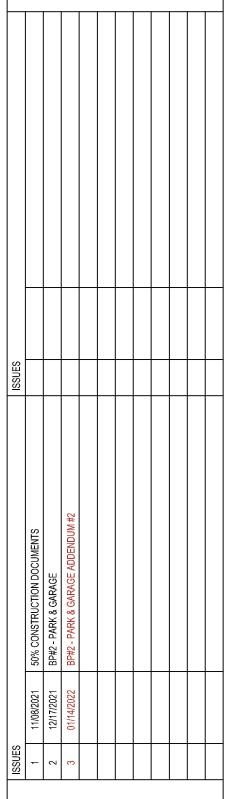


LOT 28 GARAGE AND PARK

STORM PROFILES

 V 0
 2.5
 5
 10

 H 0
 5
 10
 20
 C102.1

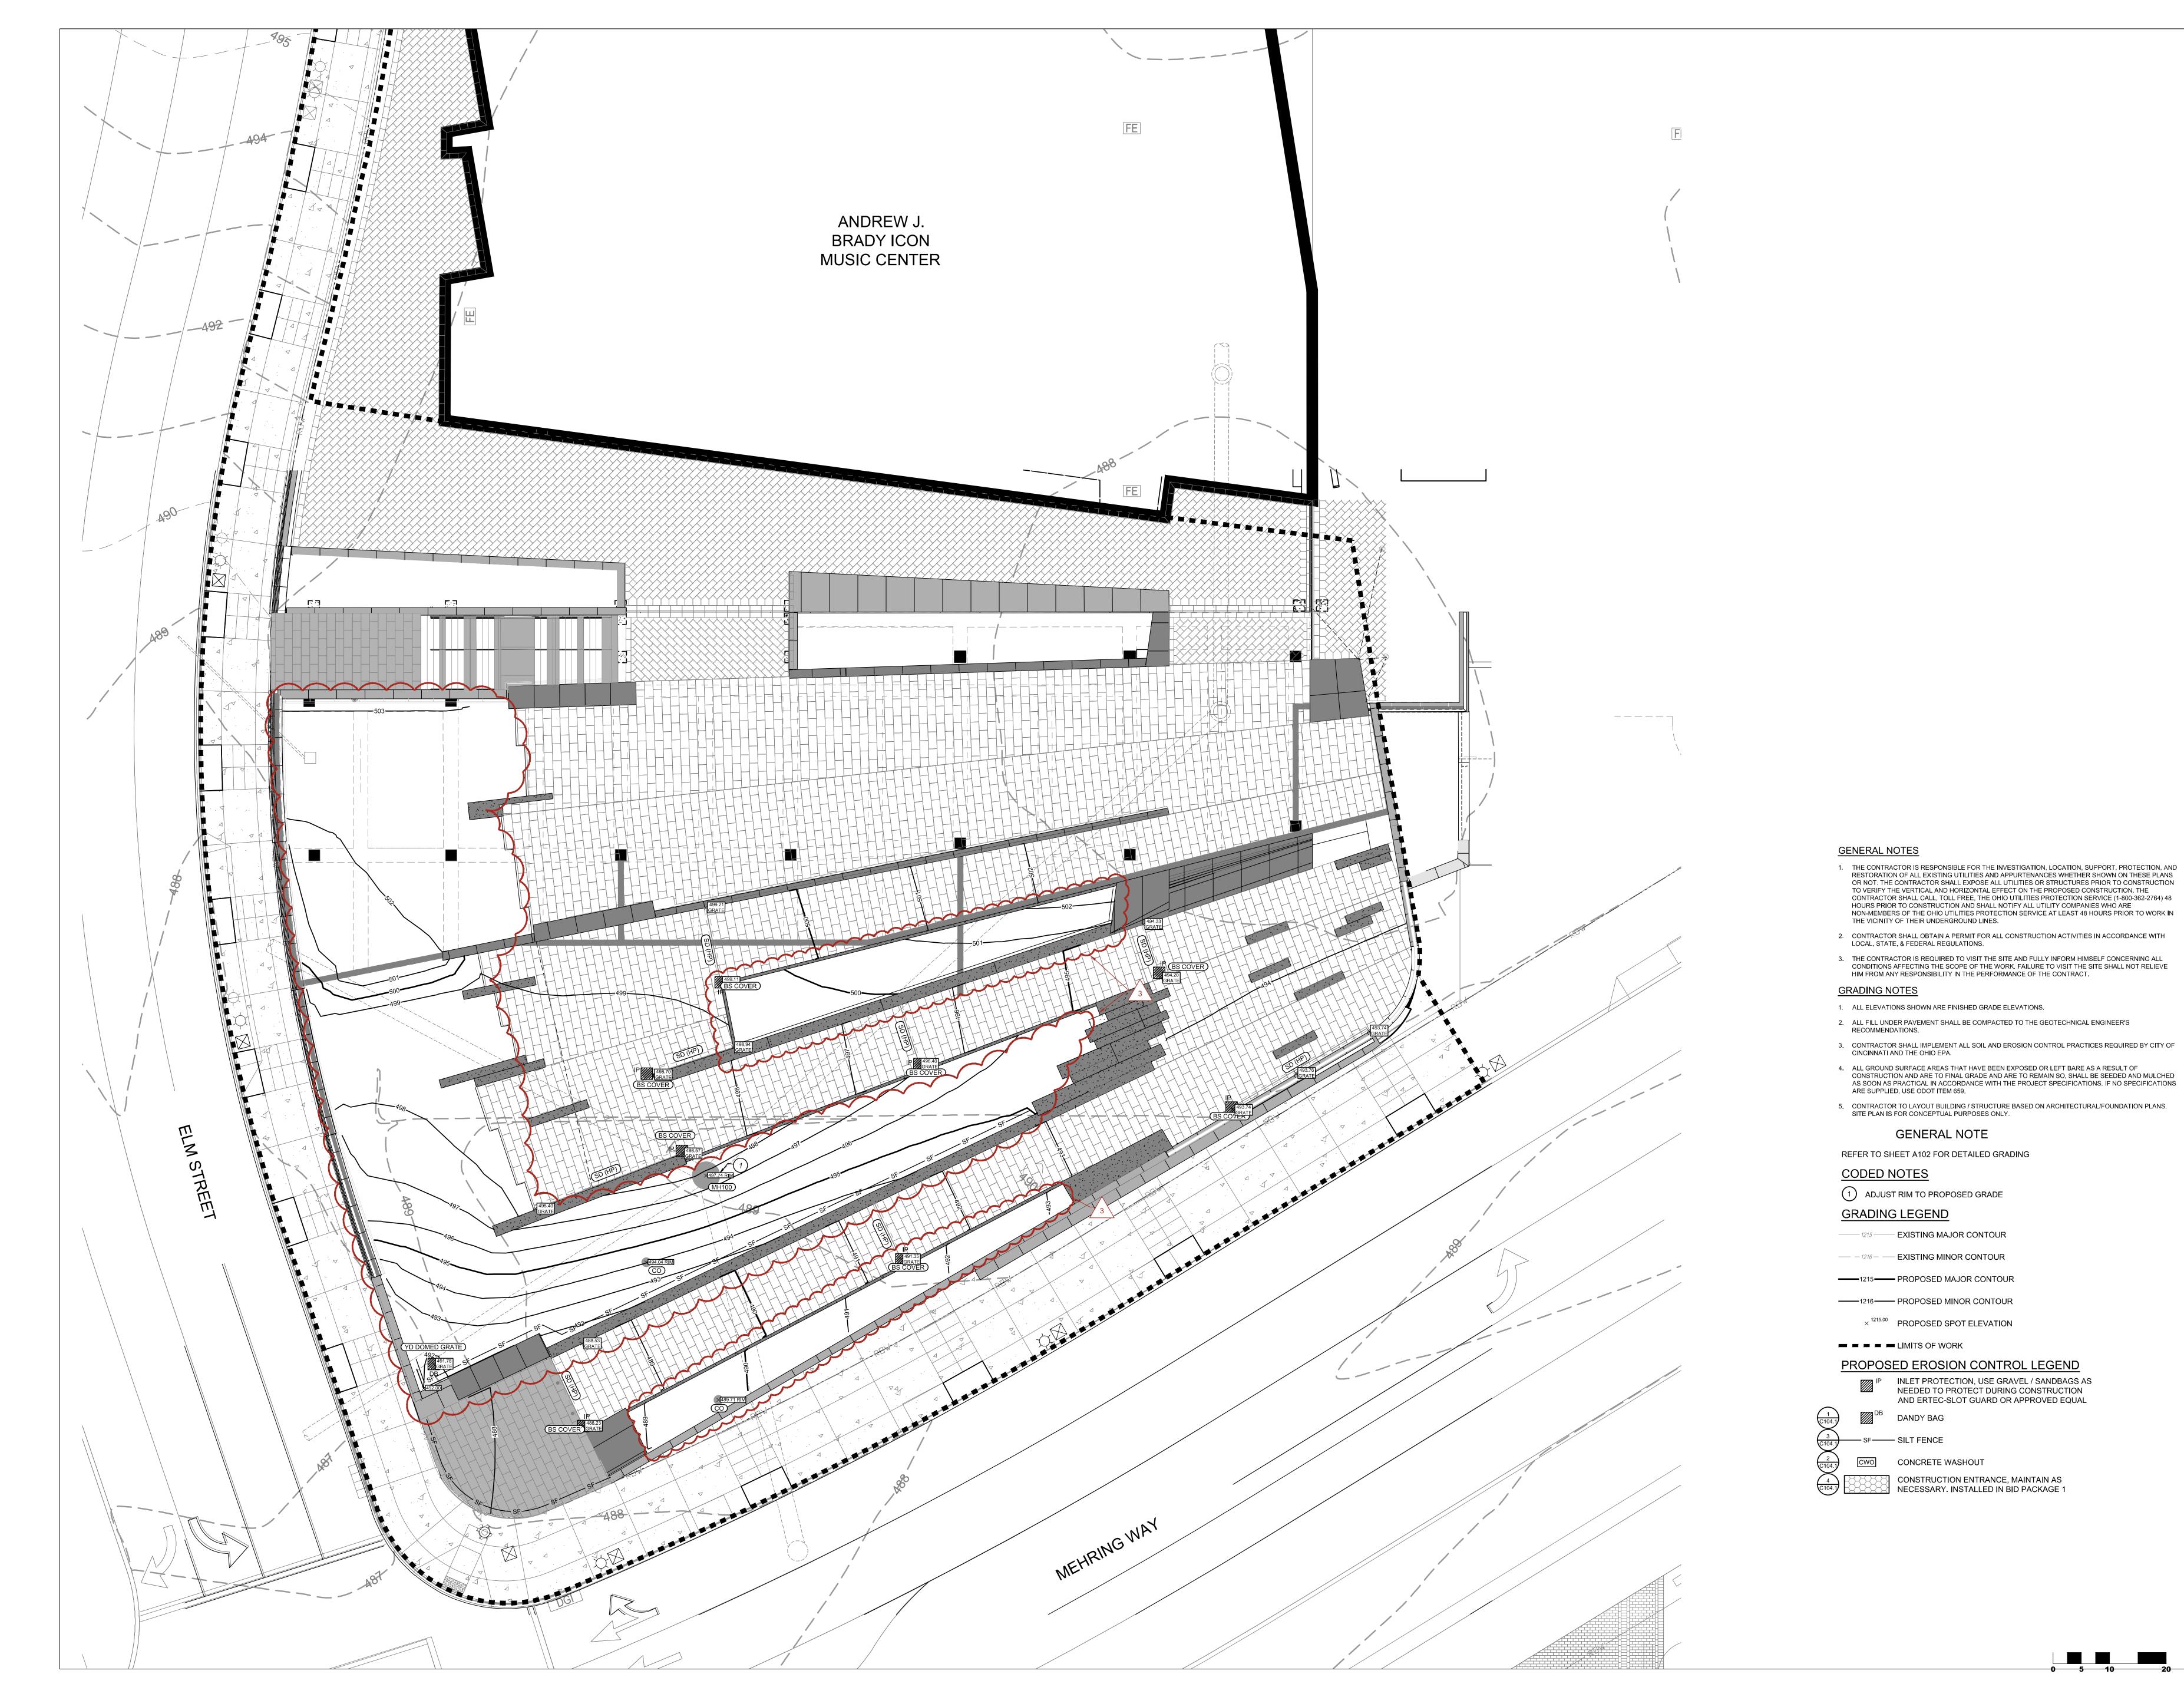



THP Limited, Inc.
Consulting Engineers
100 East Eighth Street
Cincinnati, Ohio 45202
Phone: (513) 241-3222
Fax: (513) 241-2981

1/1/2021 BP#2 - PARK & GARAGE ADDENDUM #2

1/4/2022 BP#2 - PARK & GARAGE ADDENDUM #2

| 1/4/2022 | BP#2 - PARK & GARAGE ADDENDUM #2

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BY:

M.K.

ER:

M.K.

NEER:

M.K.

CKED BY:


S.K.

LOT 28 GARAGE AND PARK

RAWING TITLE

GRADING PLAN


98090.34 12/17/2021 **C103**

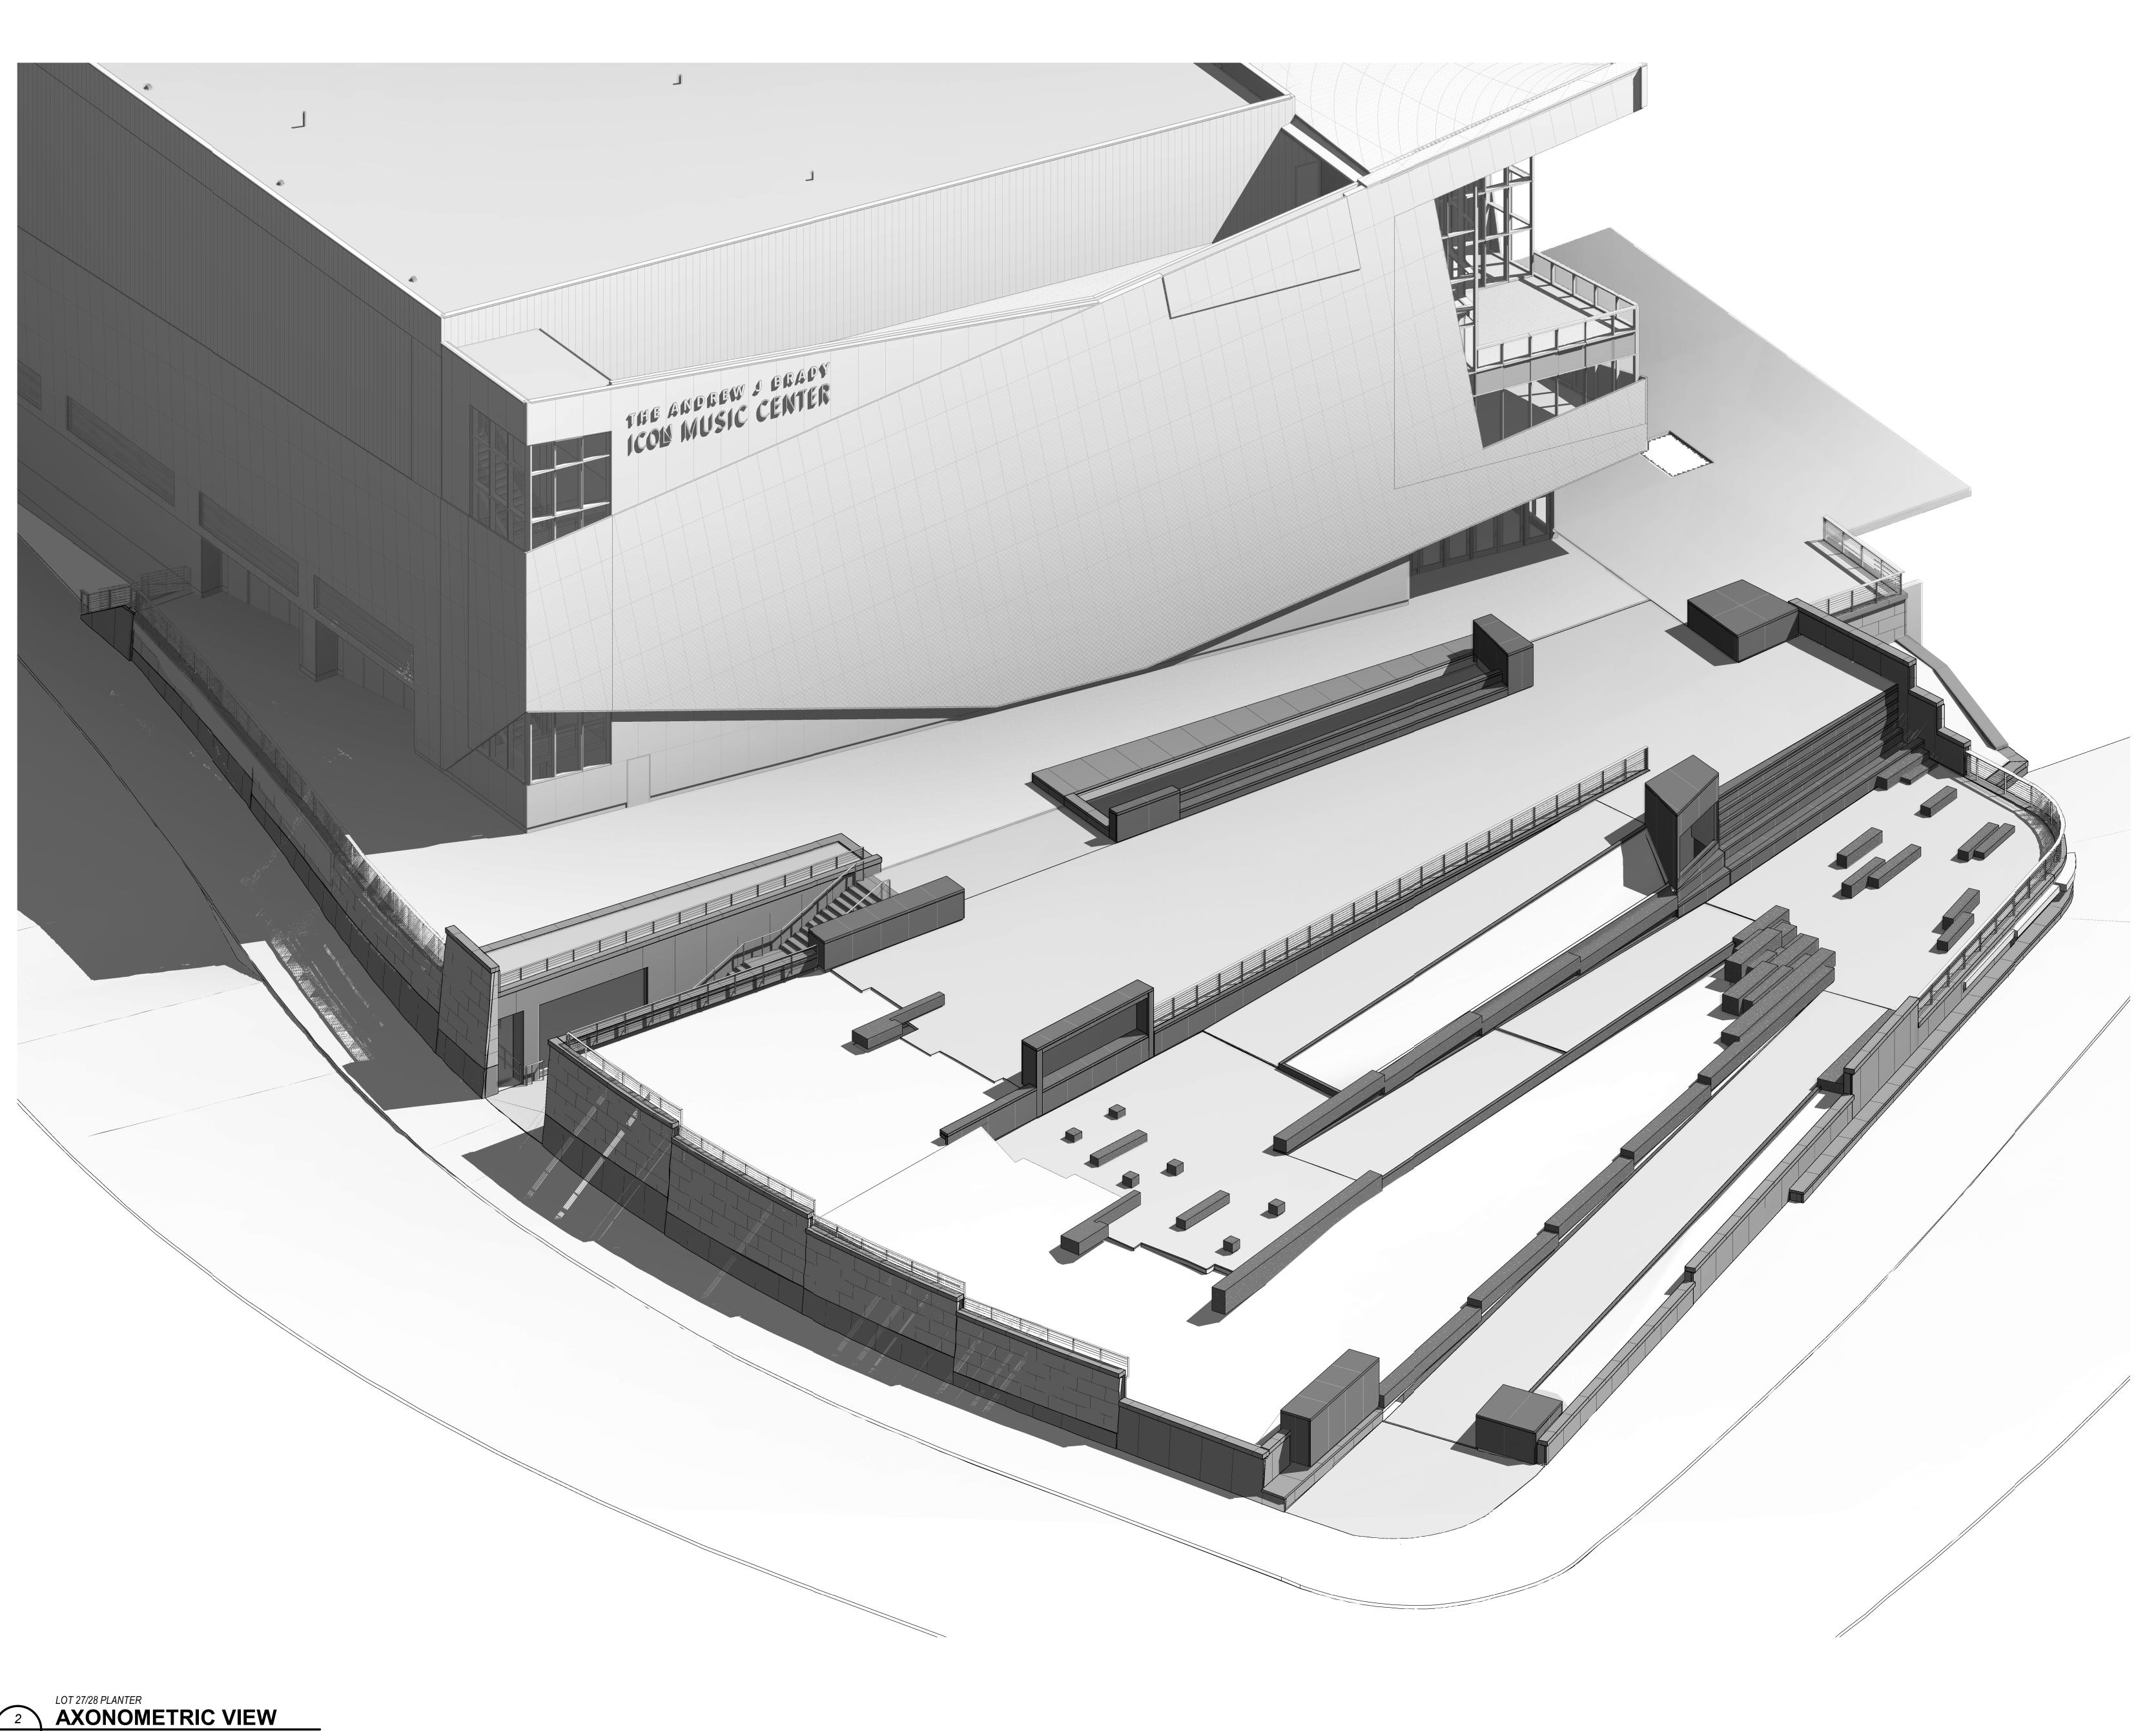




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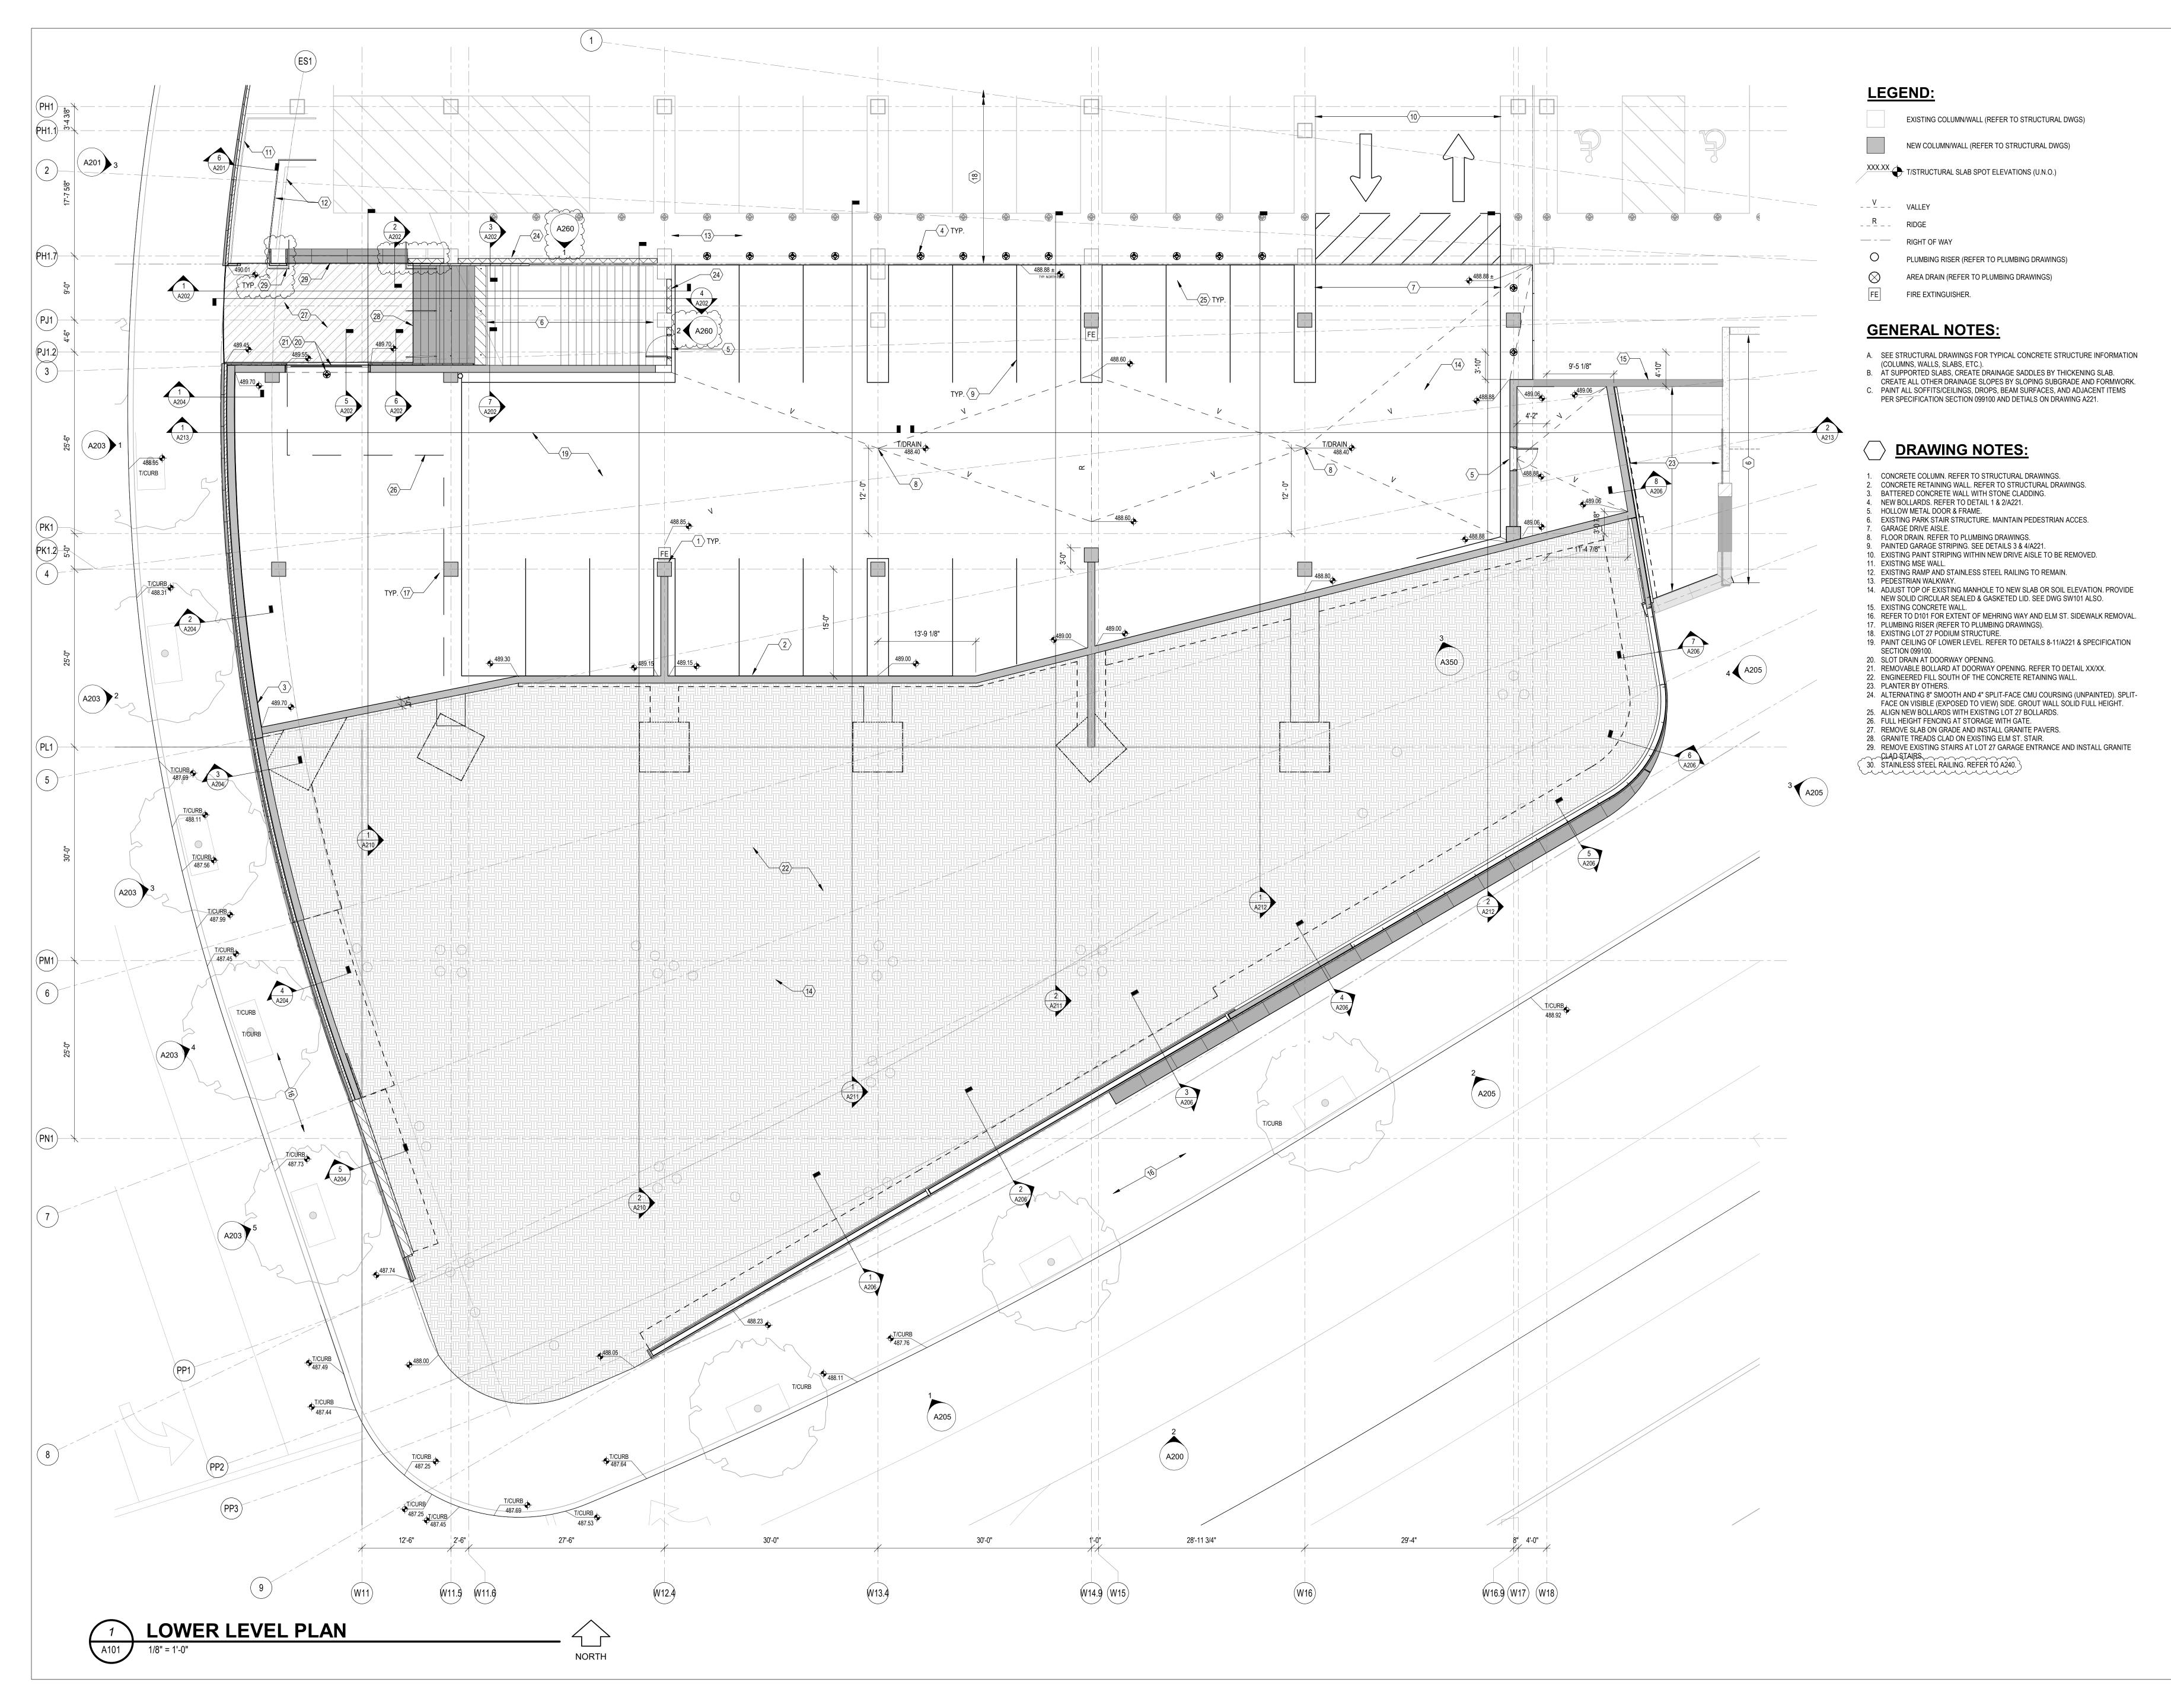
PROJECT ARCHITECT

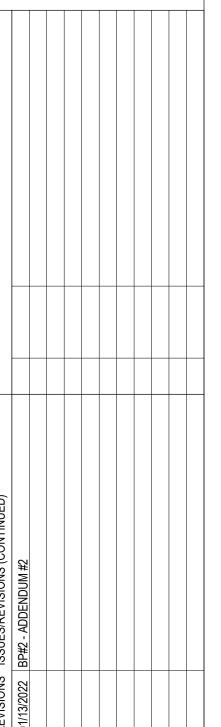

DRAWING TITLE

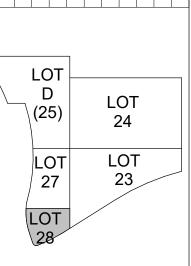AXONOMETRIC VIEW

JOB NUMBER THP 98090.40 DRAWING NUMBER







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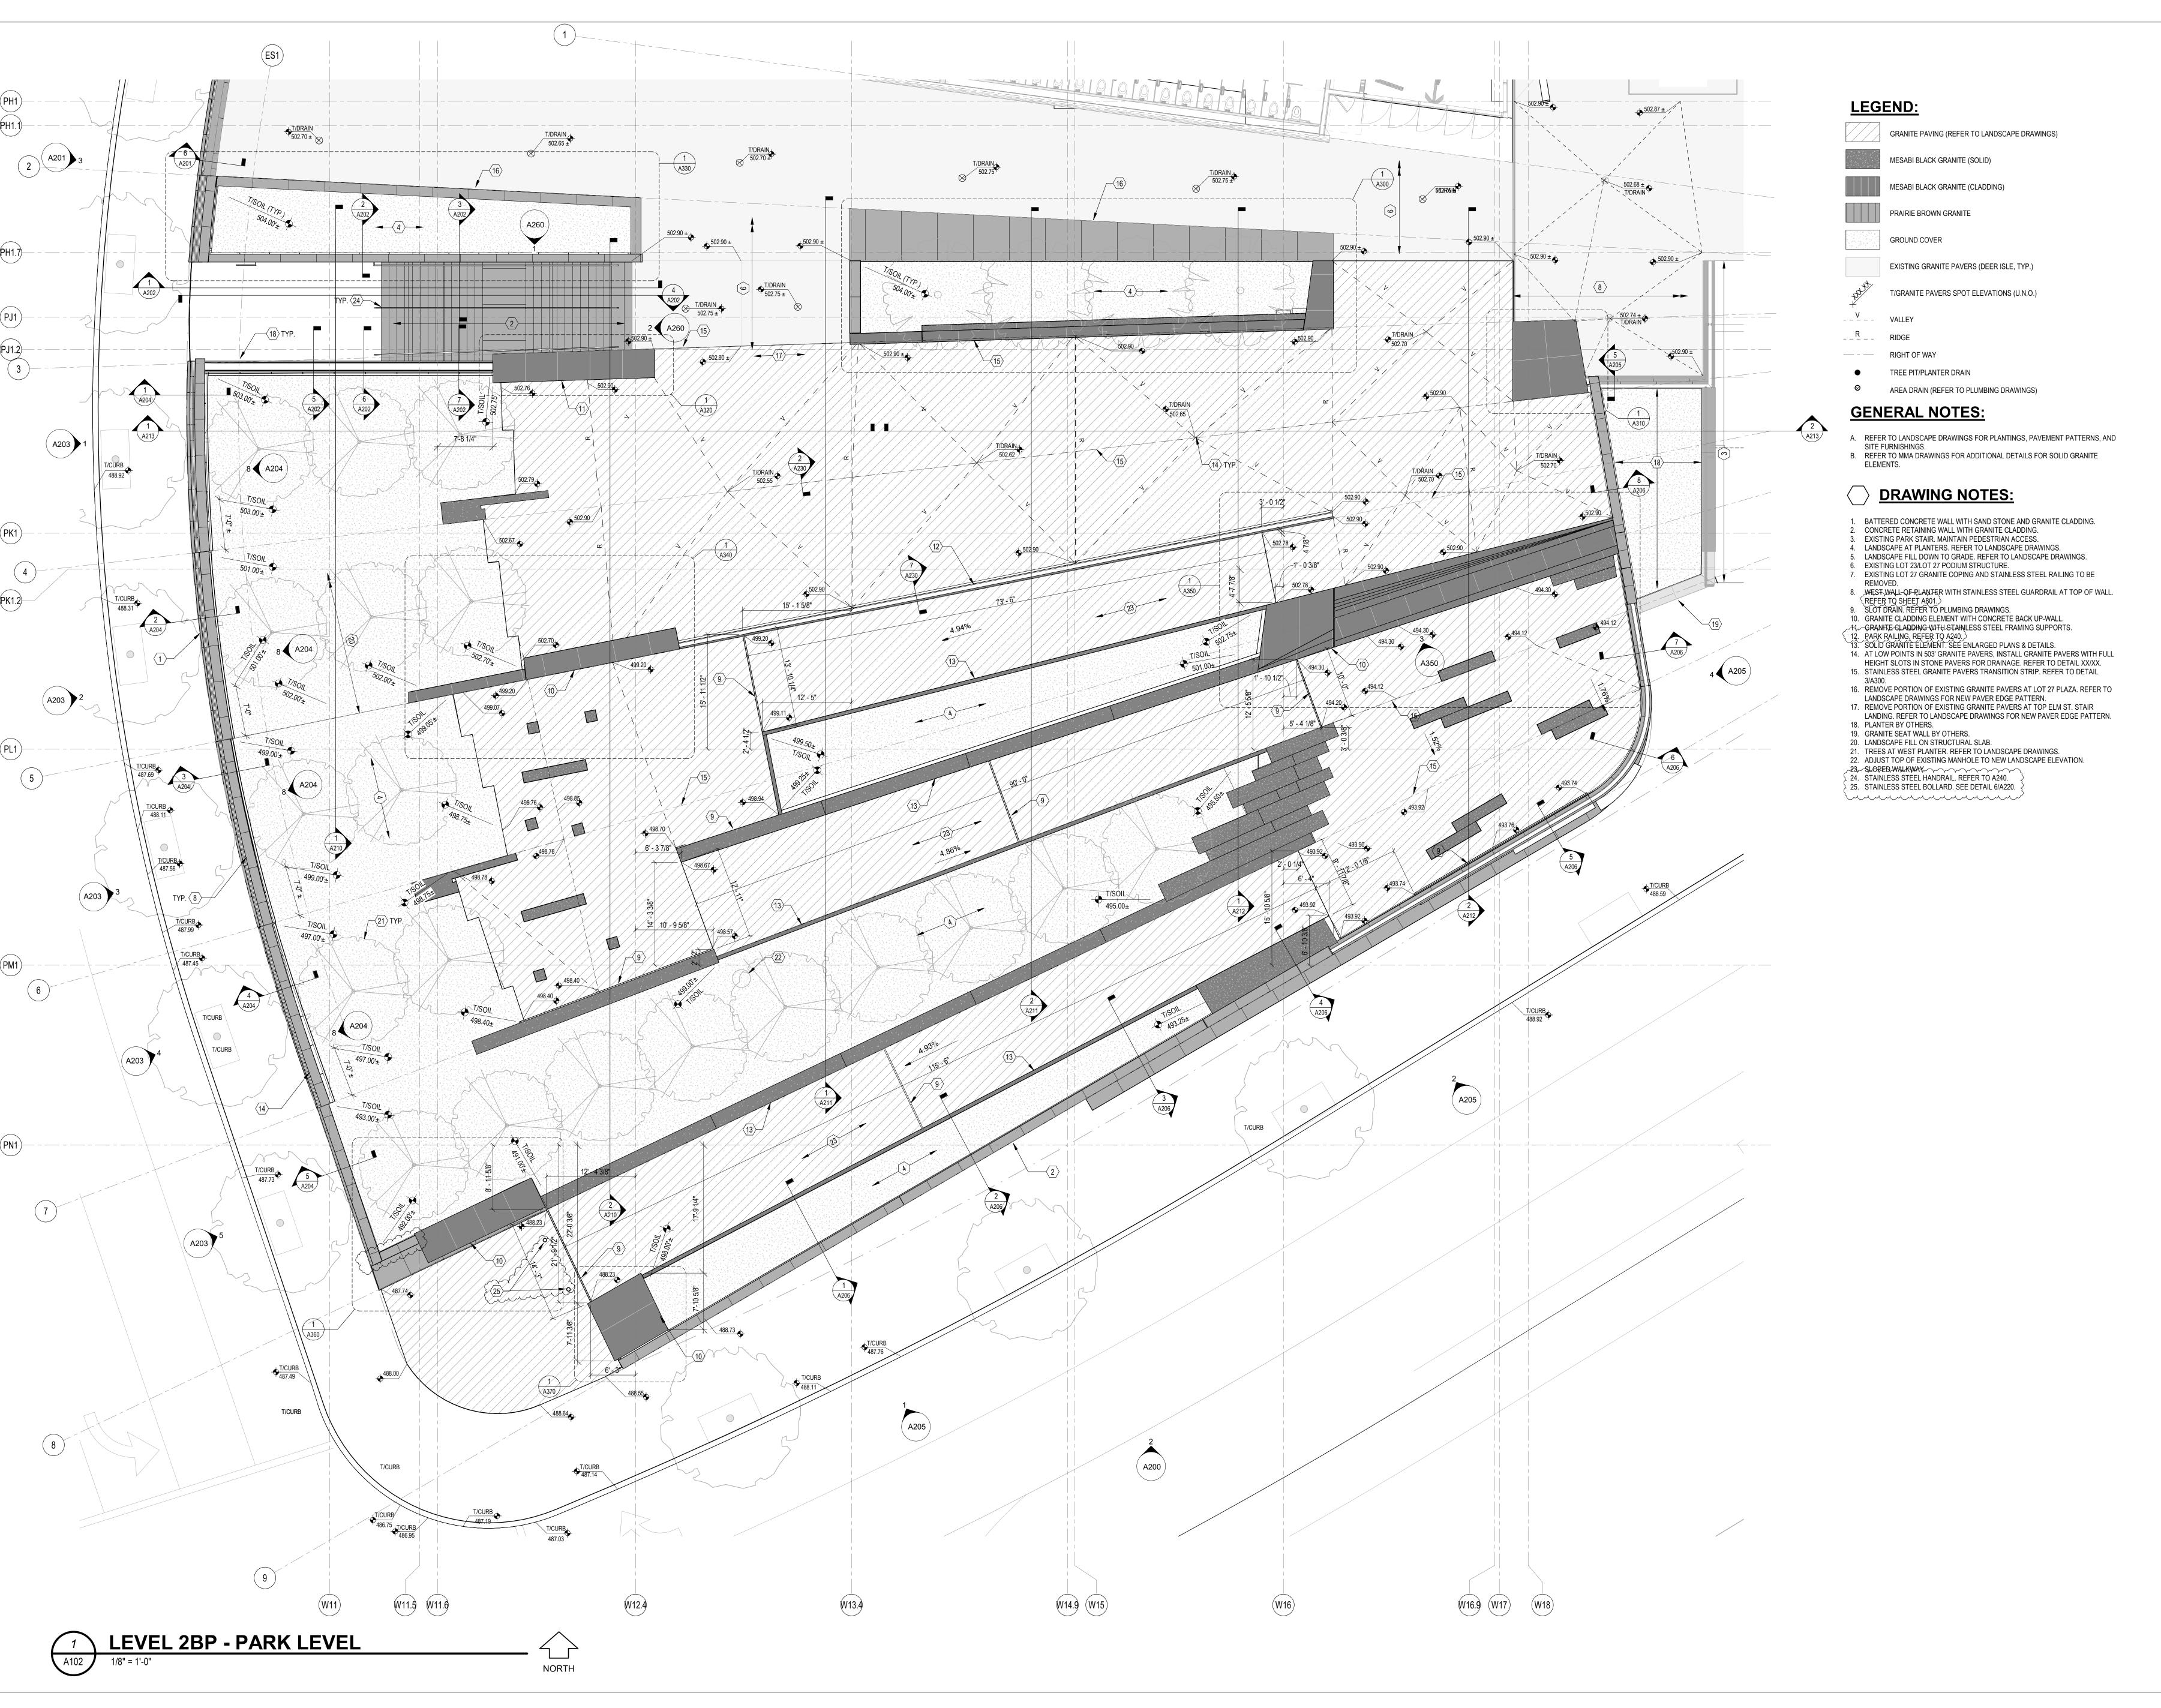
PROJECT ARCHITECT J.M.H.



DRAWING TITLE

LOWER LEVEL PLAN

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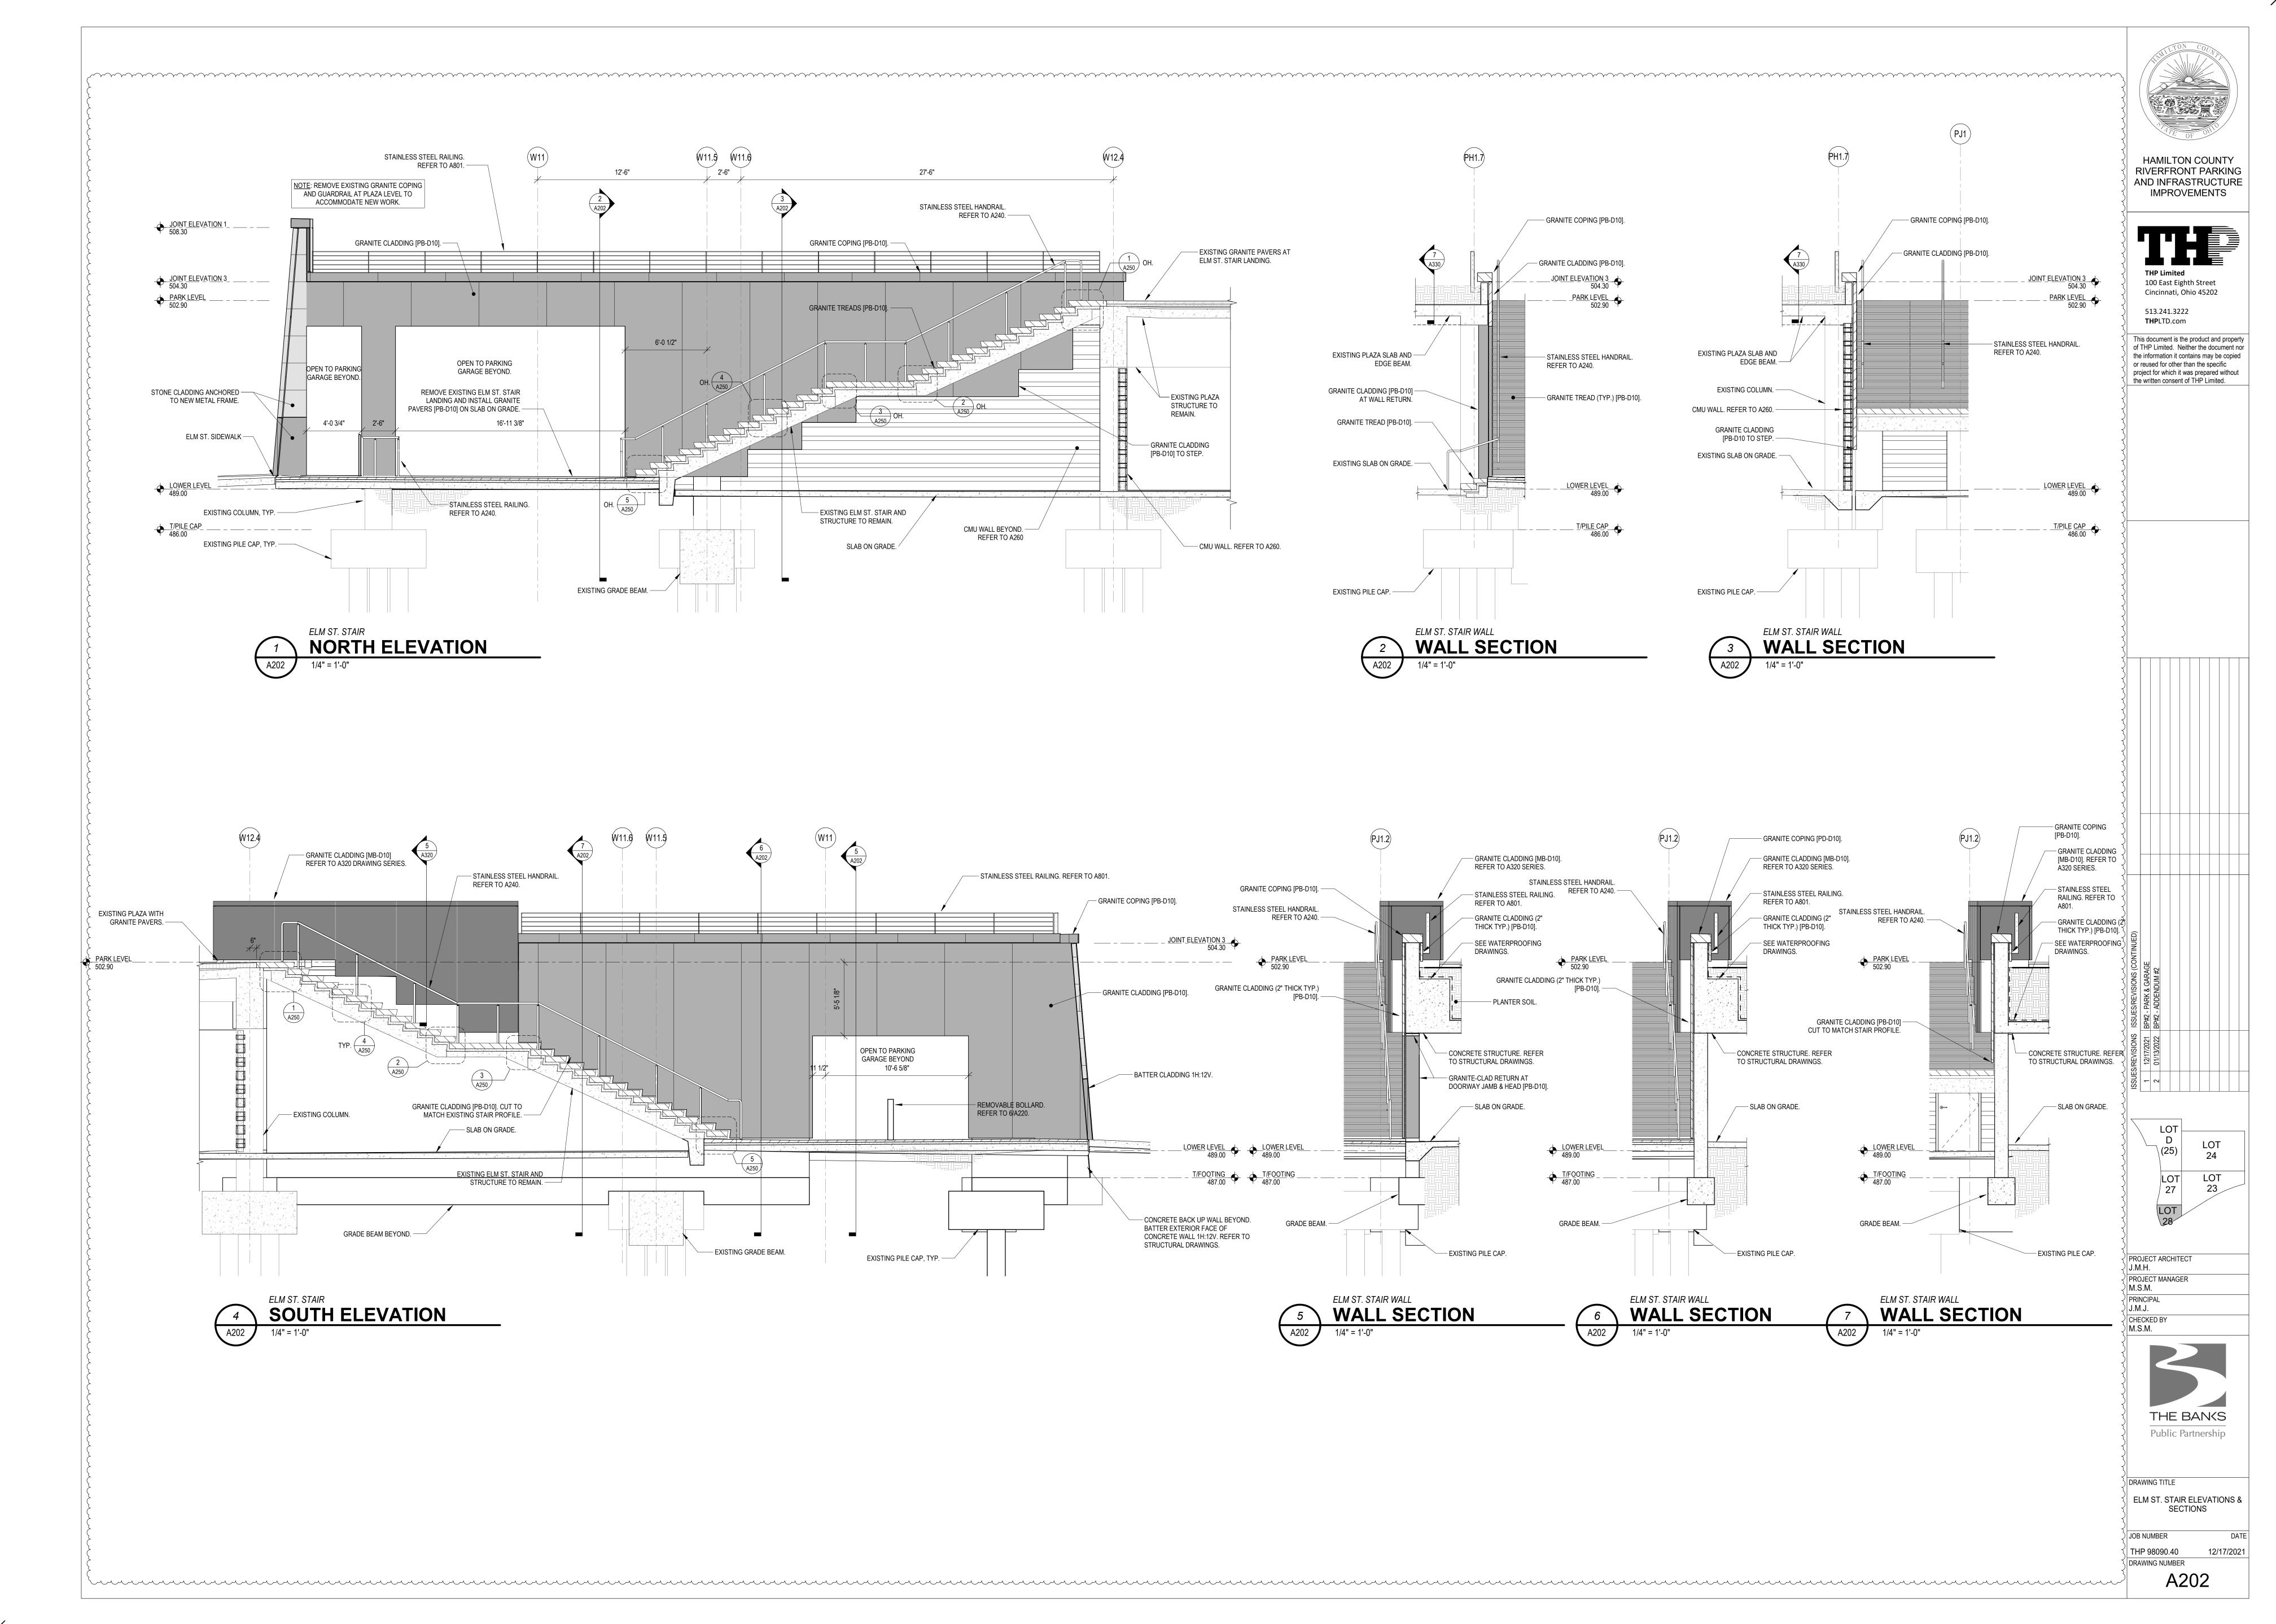
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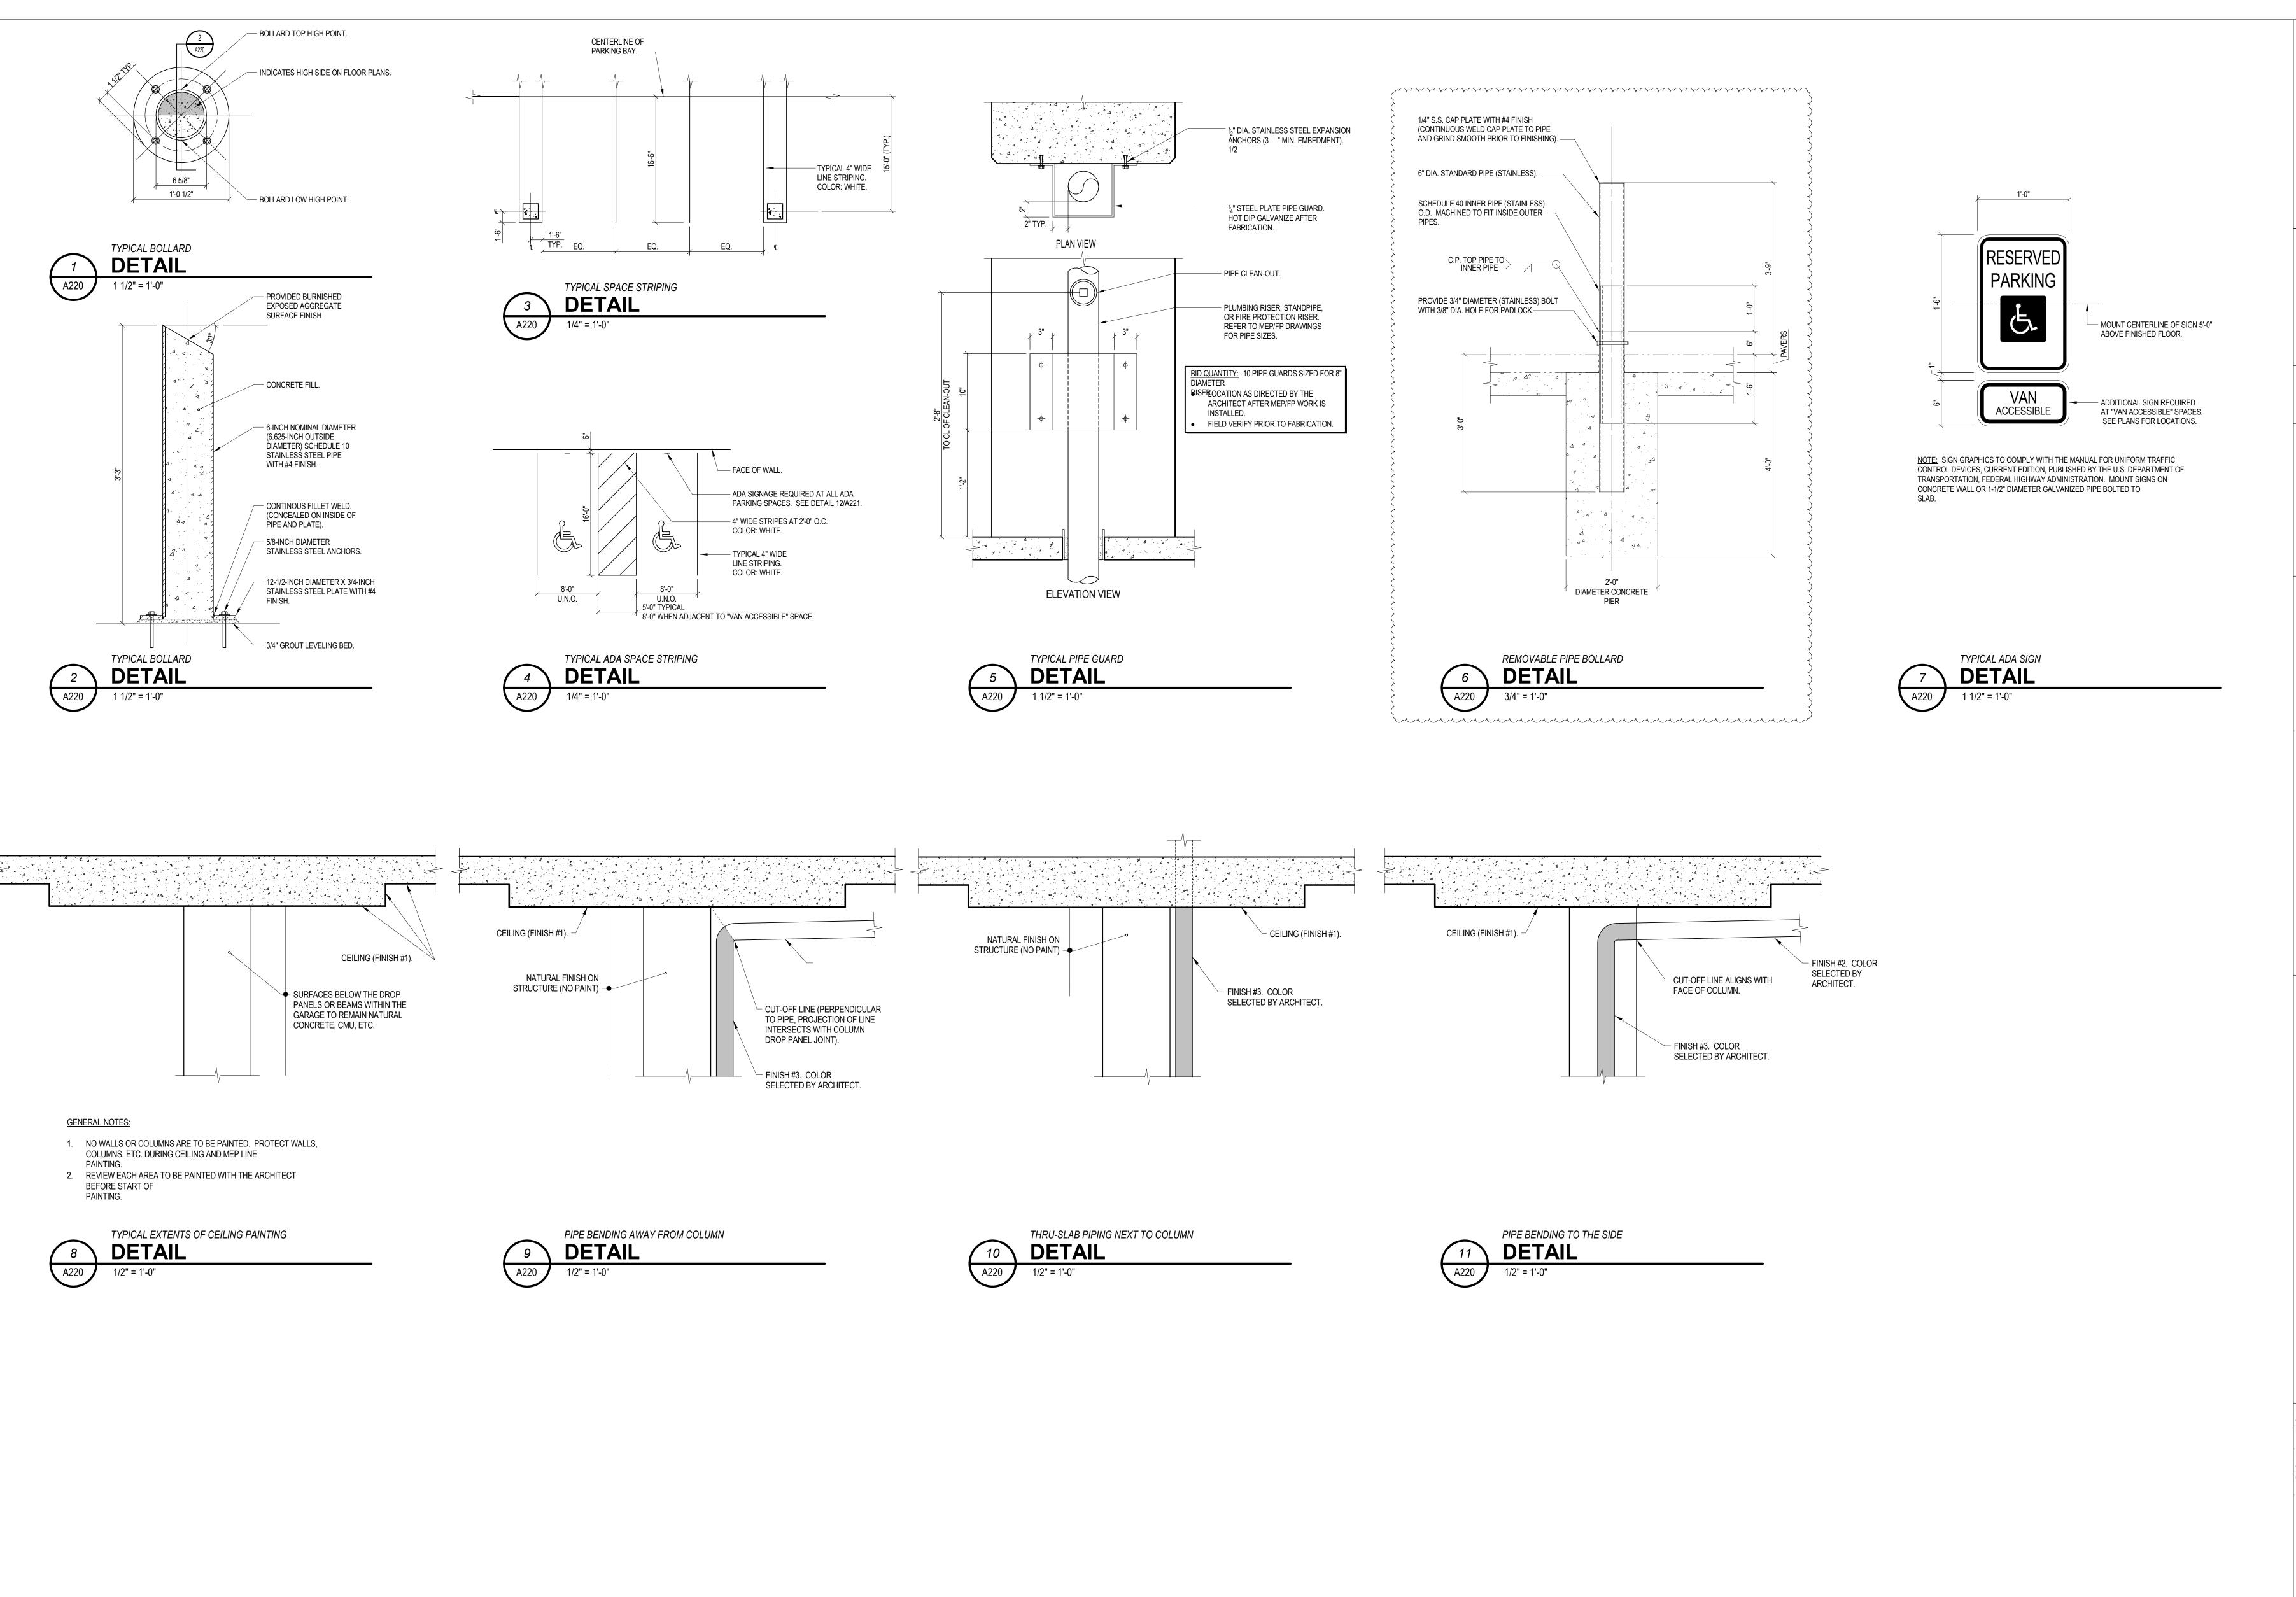
PROJECT ARCHITECT J.M.H.



PARK LEVEL FLOOR PLAN LAYOUT, GRADING, AND COMPONENTS

JOB NUMBER THP 98090.40 DRAWING NUMBER A102





TON COUNTY

HAMILTON COUNTY RIVERFRONT PARKING AND INFRASTRUCTURE IMPROVEMENTS

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ONS (CONTINUED)
JARAGE
JIM #2

LOT D LOT 24

LOT LOT 27

LOT 23

LOT 28

PROJECT ARCHITECT
J.M.H.

PROJECT MANAGER
M.S.M.

PRINCIPAL
J.M.J.

CHECKED BY




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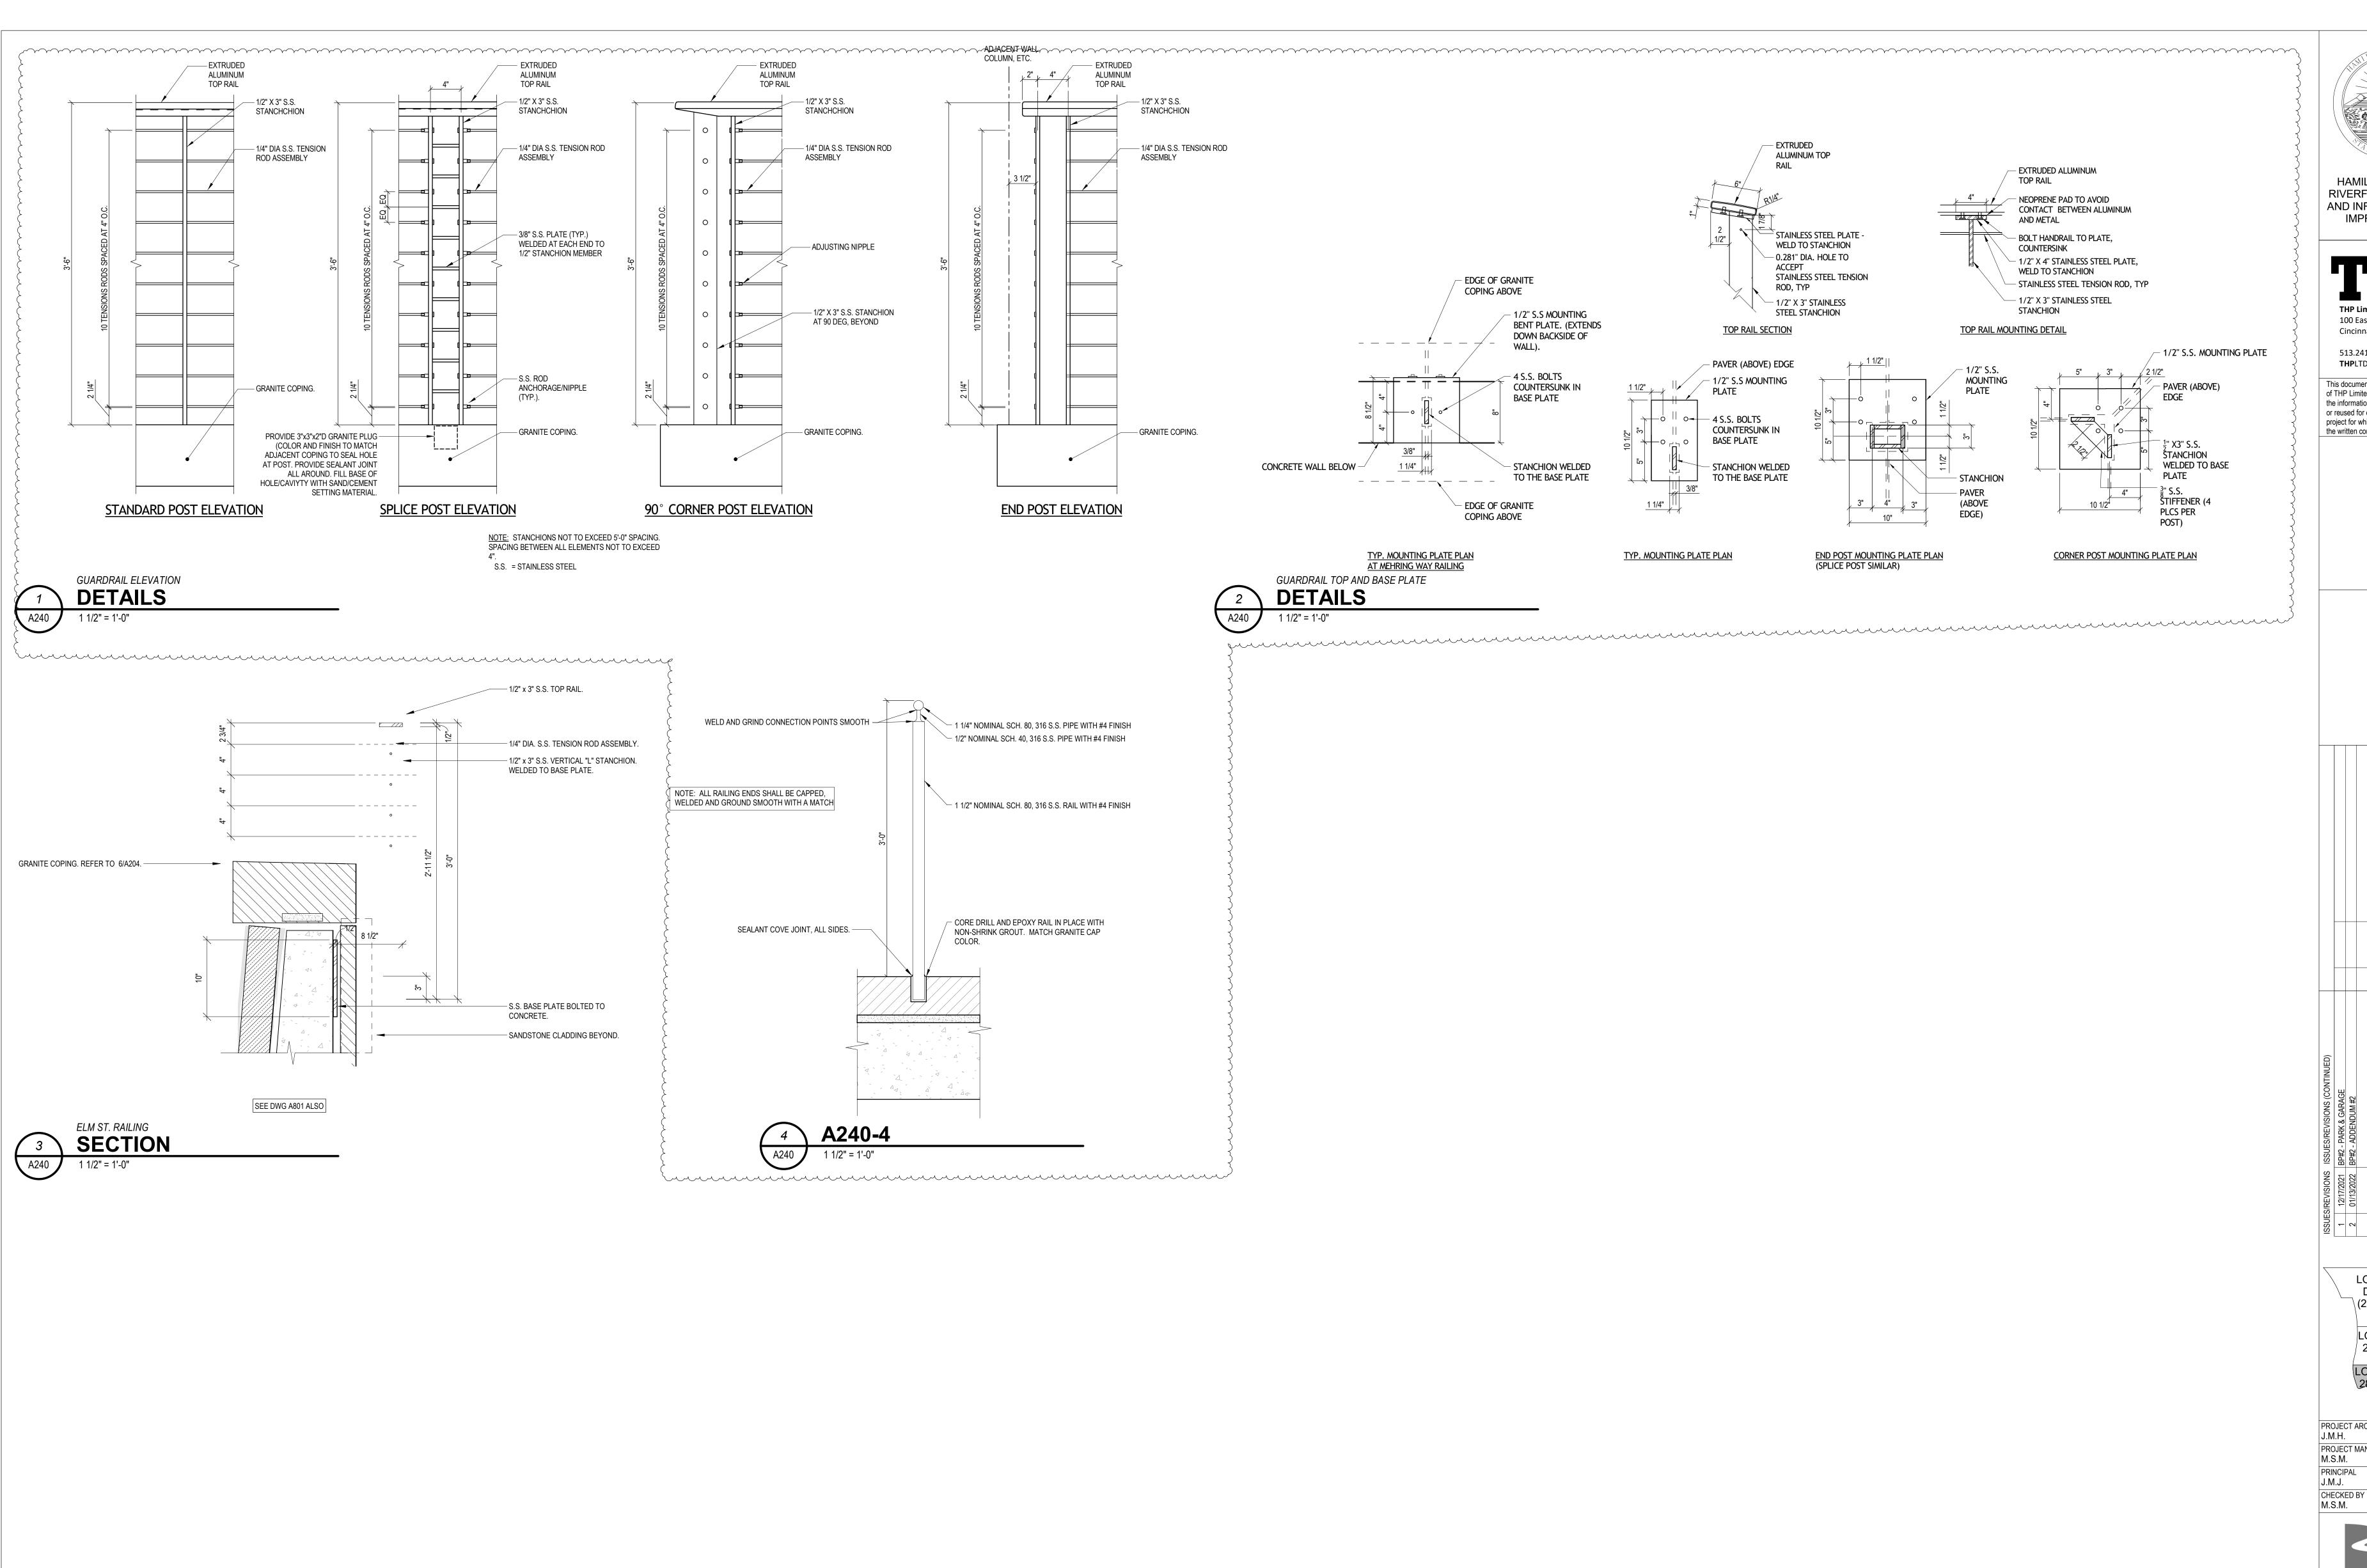
ARCHITECTURAL DETAILS

JOB NUMBER DAT

THP 98090.40 12/17/2020

DRAWING NUMBER




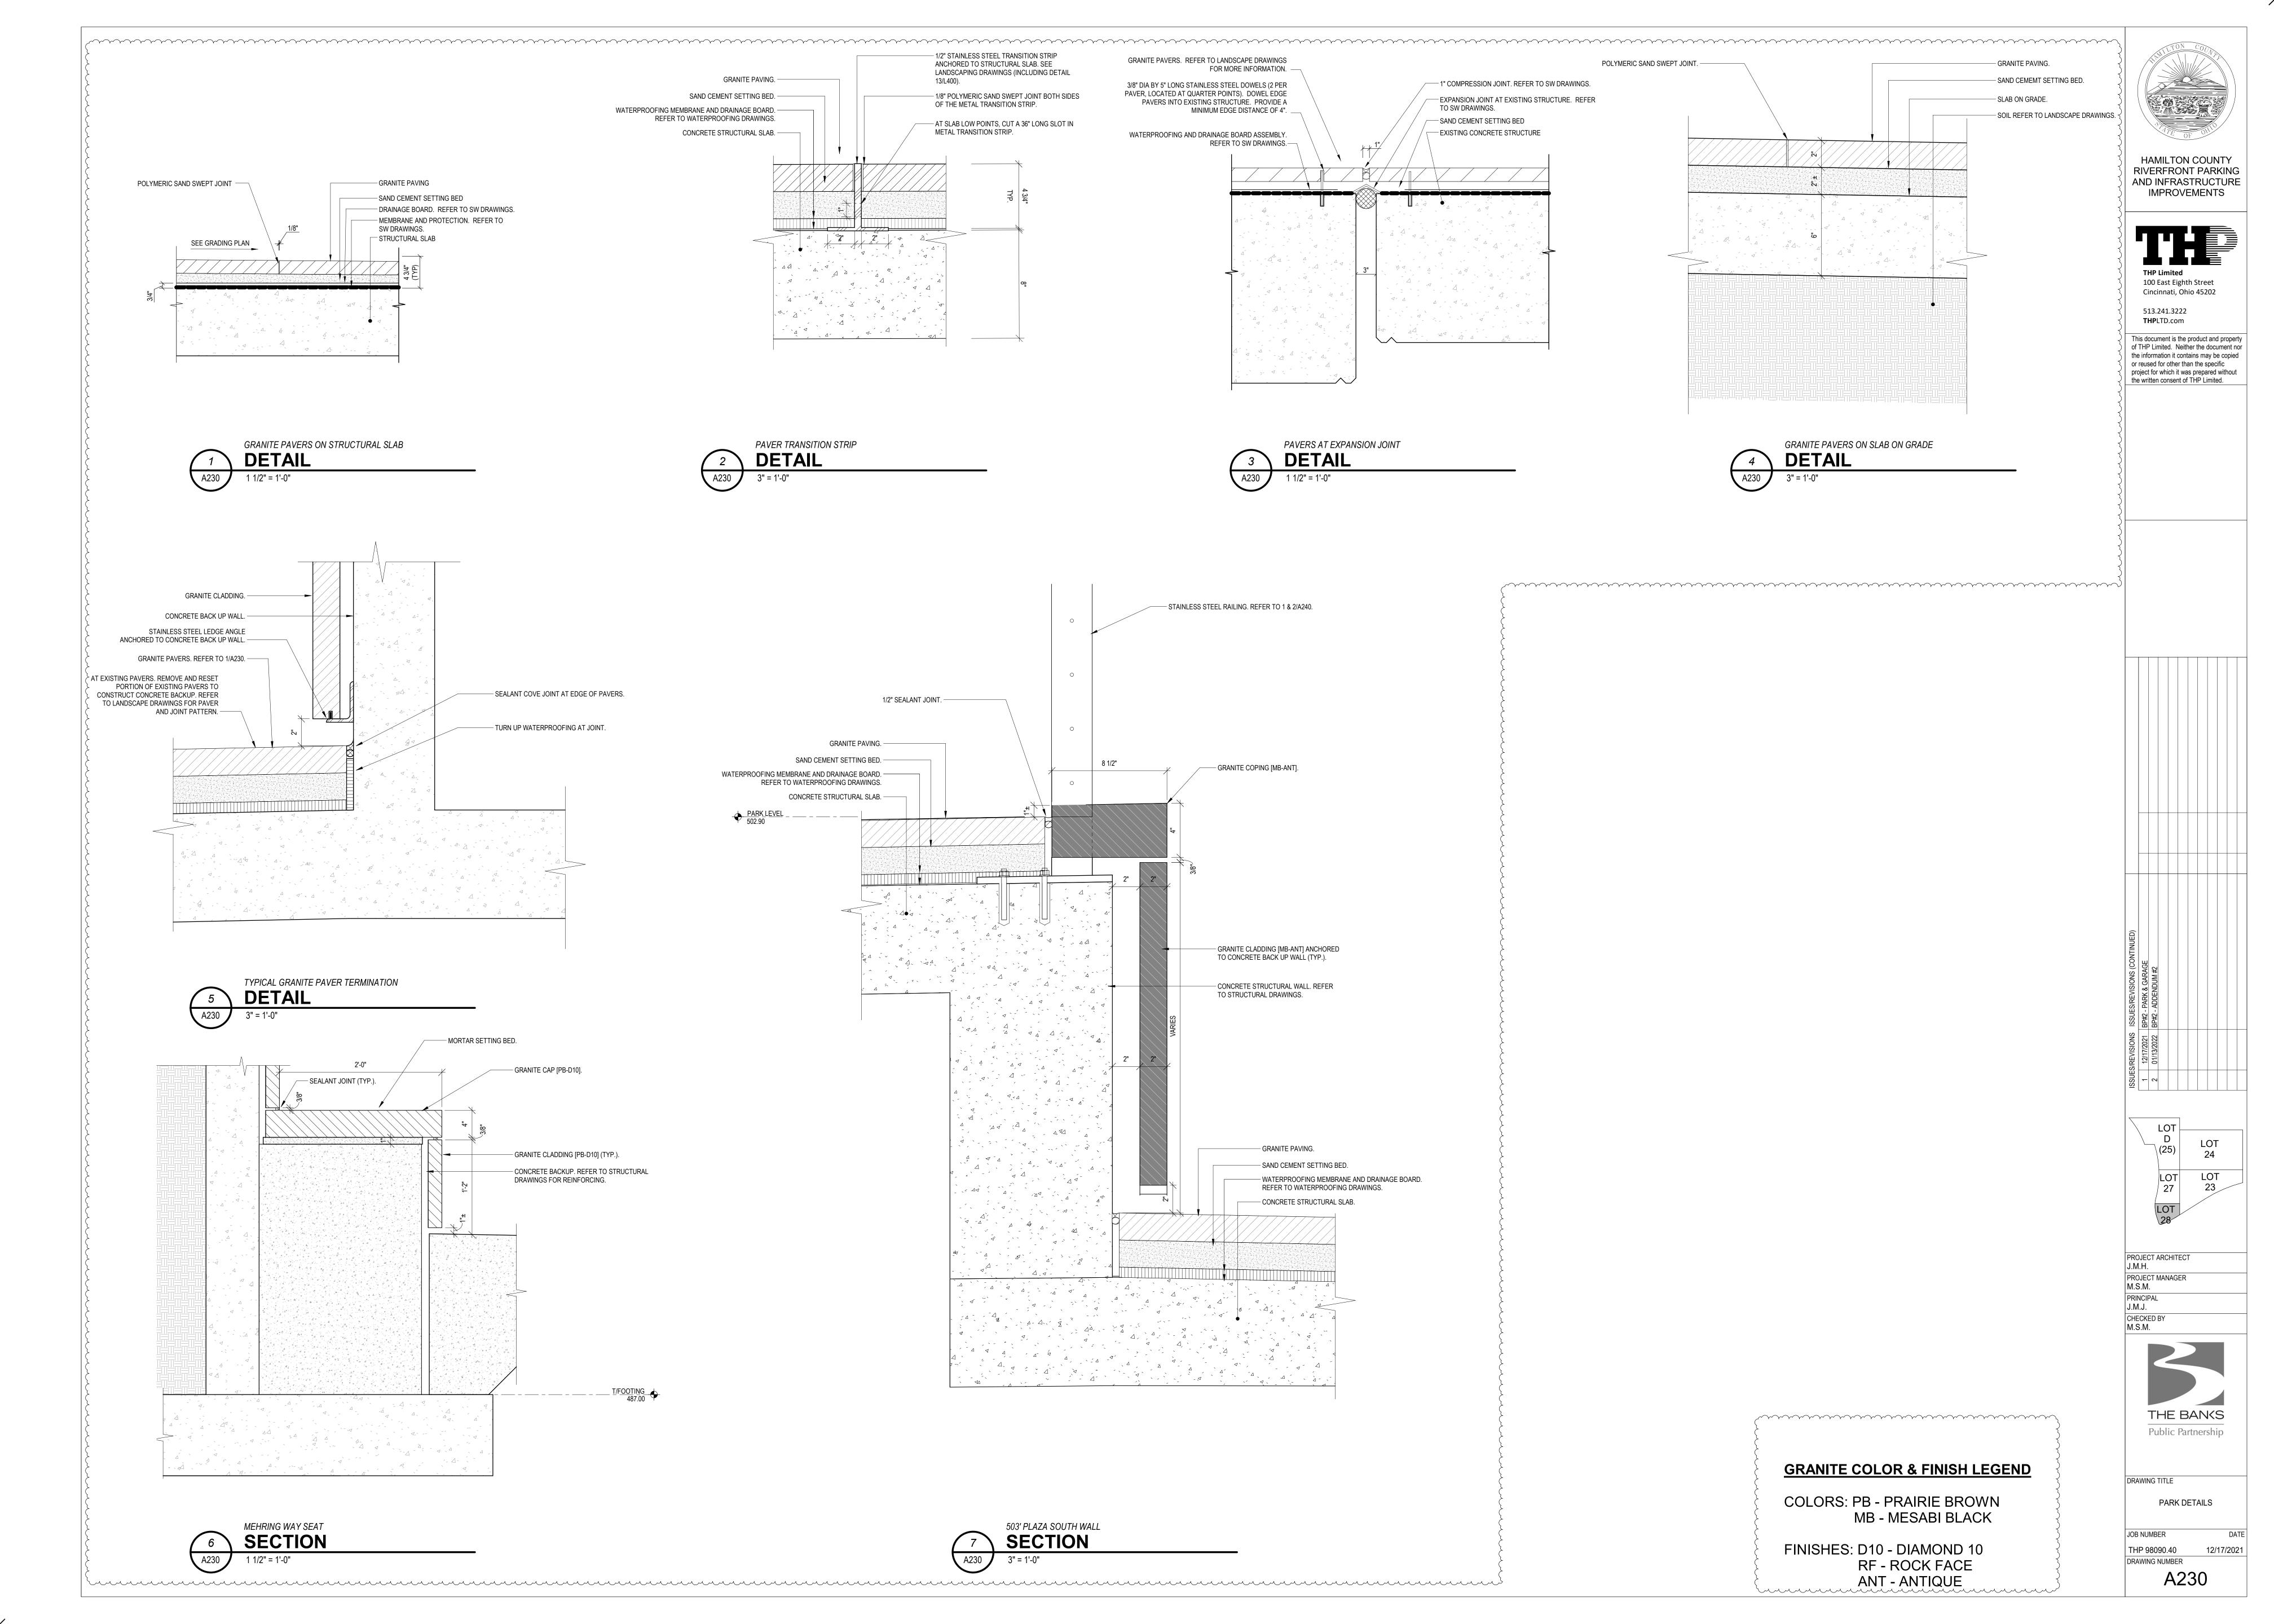

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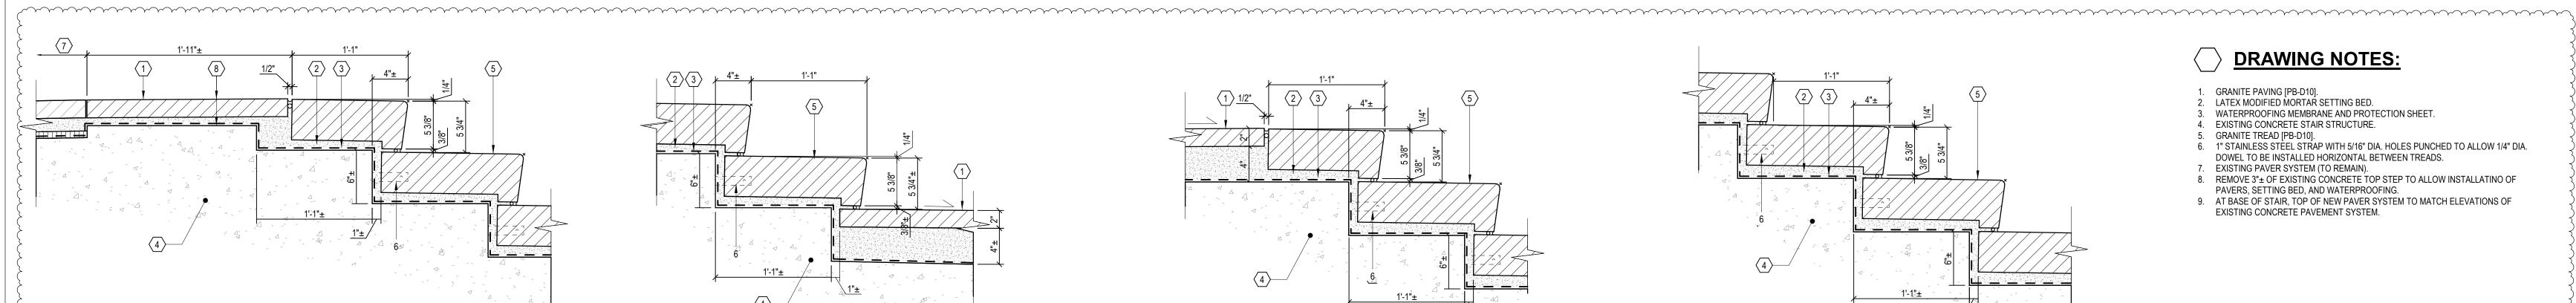
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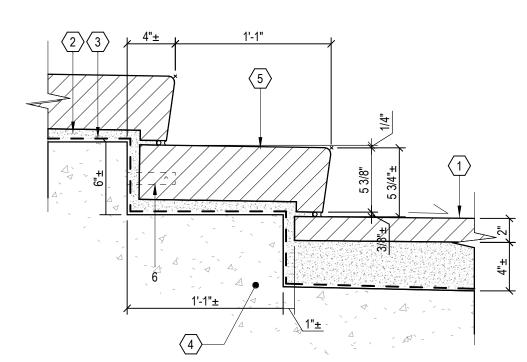


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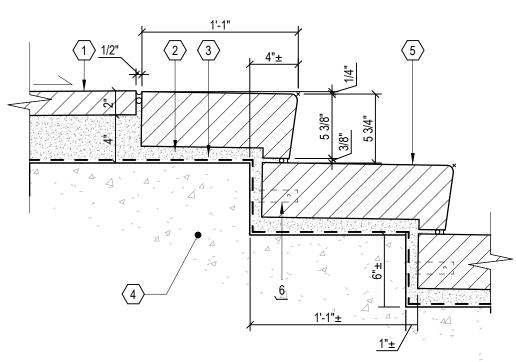
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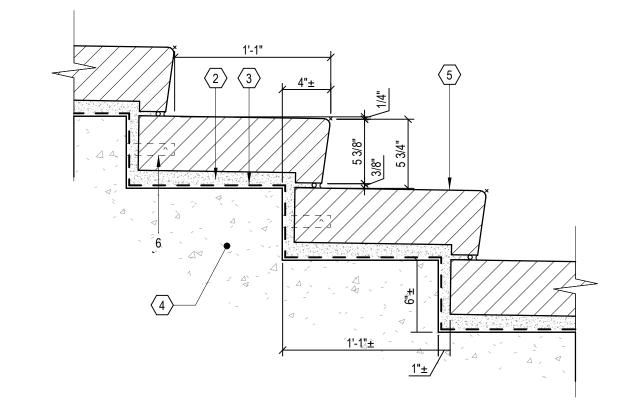
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TOP OF ELM STREET STAIR LANDING



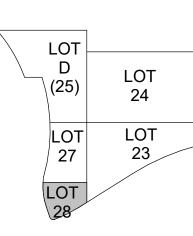

ELM STREET STAIR TREAD

DETAIL

mander and the commence and the commence

DRAWING NOTES:

EXISTING CONCRETE PAVEMENT SYSTEM.

 GRANITE PAVING [PB-D10].
 LATEX MODIFIED MORTAR SETTING BED. 3. WATERPROOFING MEMBRANE AND PROTECTION SHEET. 4. EXISTING CONCRETE STAIR STRUCTURE. GRANITE TREAD [PB-D10].
 1" STAINLESS STEEL STRAP WITH 5/16" DIA. HOLES PUNCHED TO ALLOW 1/4" DIA. DOWEL TO BE INSTALLED HORIZONTAL BETWEEN TREADS.

7. EXISTING PAVER SYSTEM (TO REMAIN). 8. REMOVE 3"± OF EXISTING CONCRETE TOP STEP TO ALLOW INSTALLATINO OF PAVERS, SETTING BED, AND WATERPROOFING. 9. AT BASE OF STAIR, TOP OF NEW PAVER SYSTEM TO MATCH ELEVATIONS OF



HAMILTON COUNTY RIVERFRONT PARKING

AND INFRASTRUCTURE

IMPROVEMENTS

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CHECKED BY M.S.M. THE BANKS

Public Partnership

DRAWING TITLE ELM STREET STAIR DETAILS

GRANITE COLOR & FINISH LEGEND

MB - MESABI BLACK

RF - ROCK FACE


ANT - ANTIQUE


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FINISHES: D10 - DIAMOND 10


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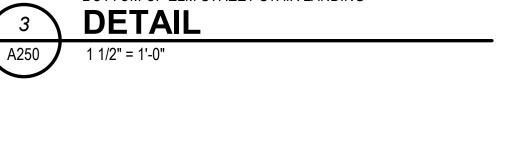








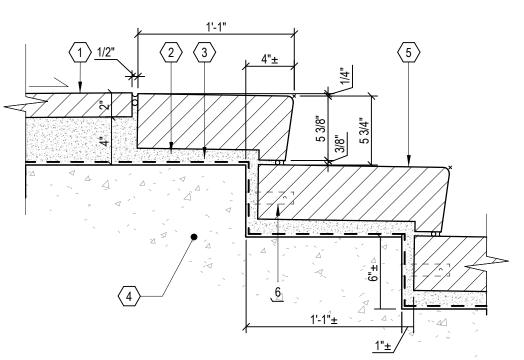


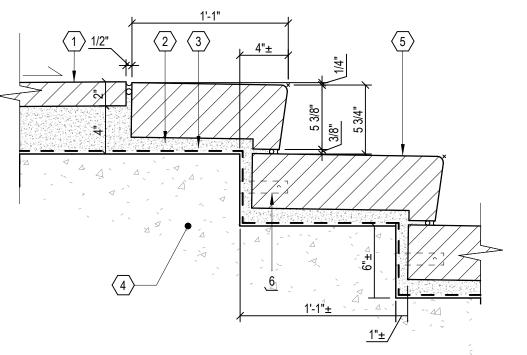

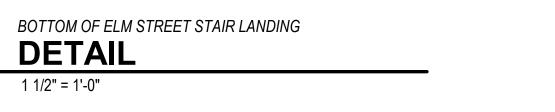

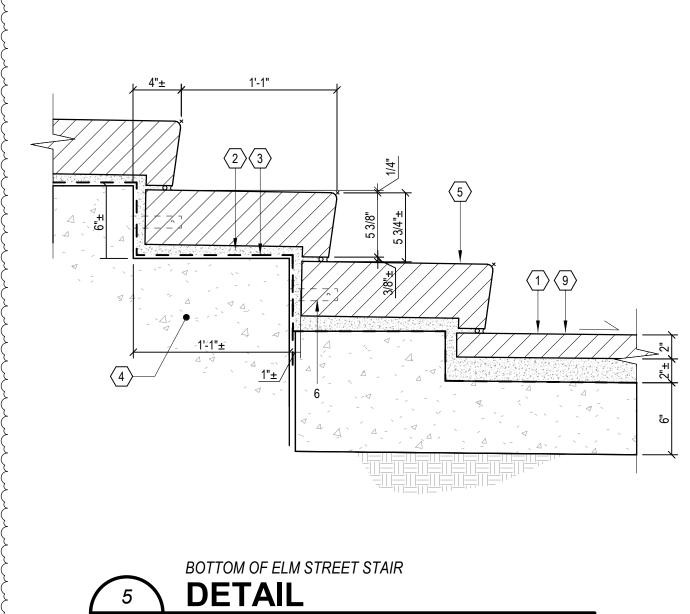

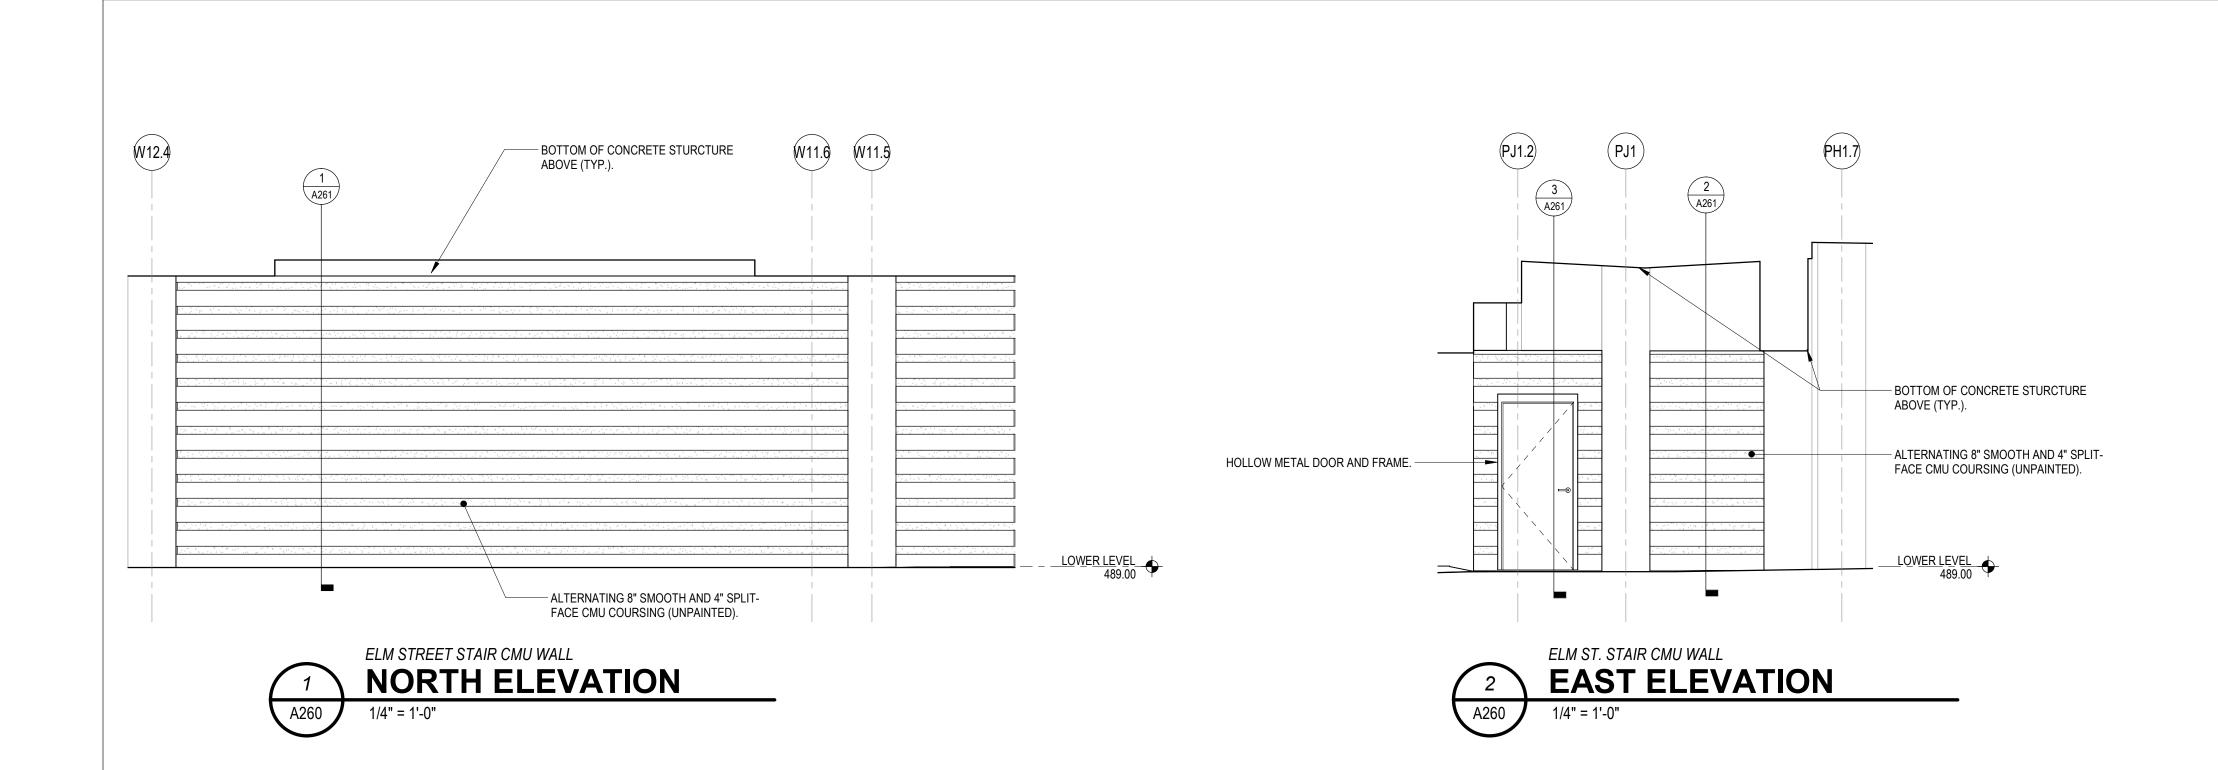


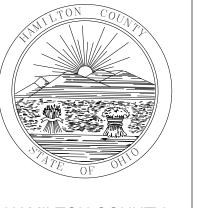




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PROJECT MAN

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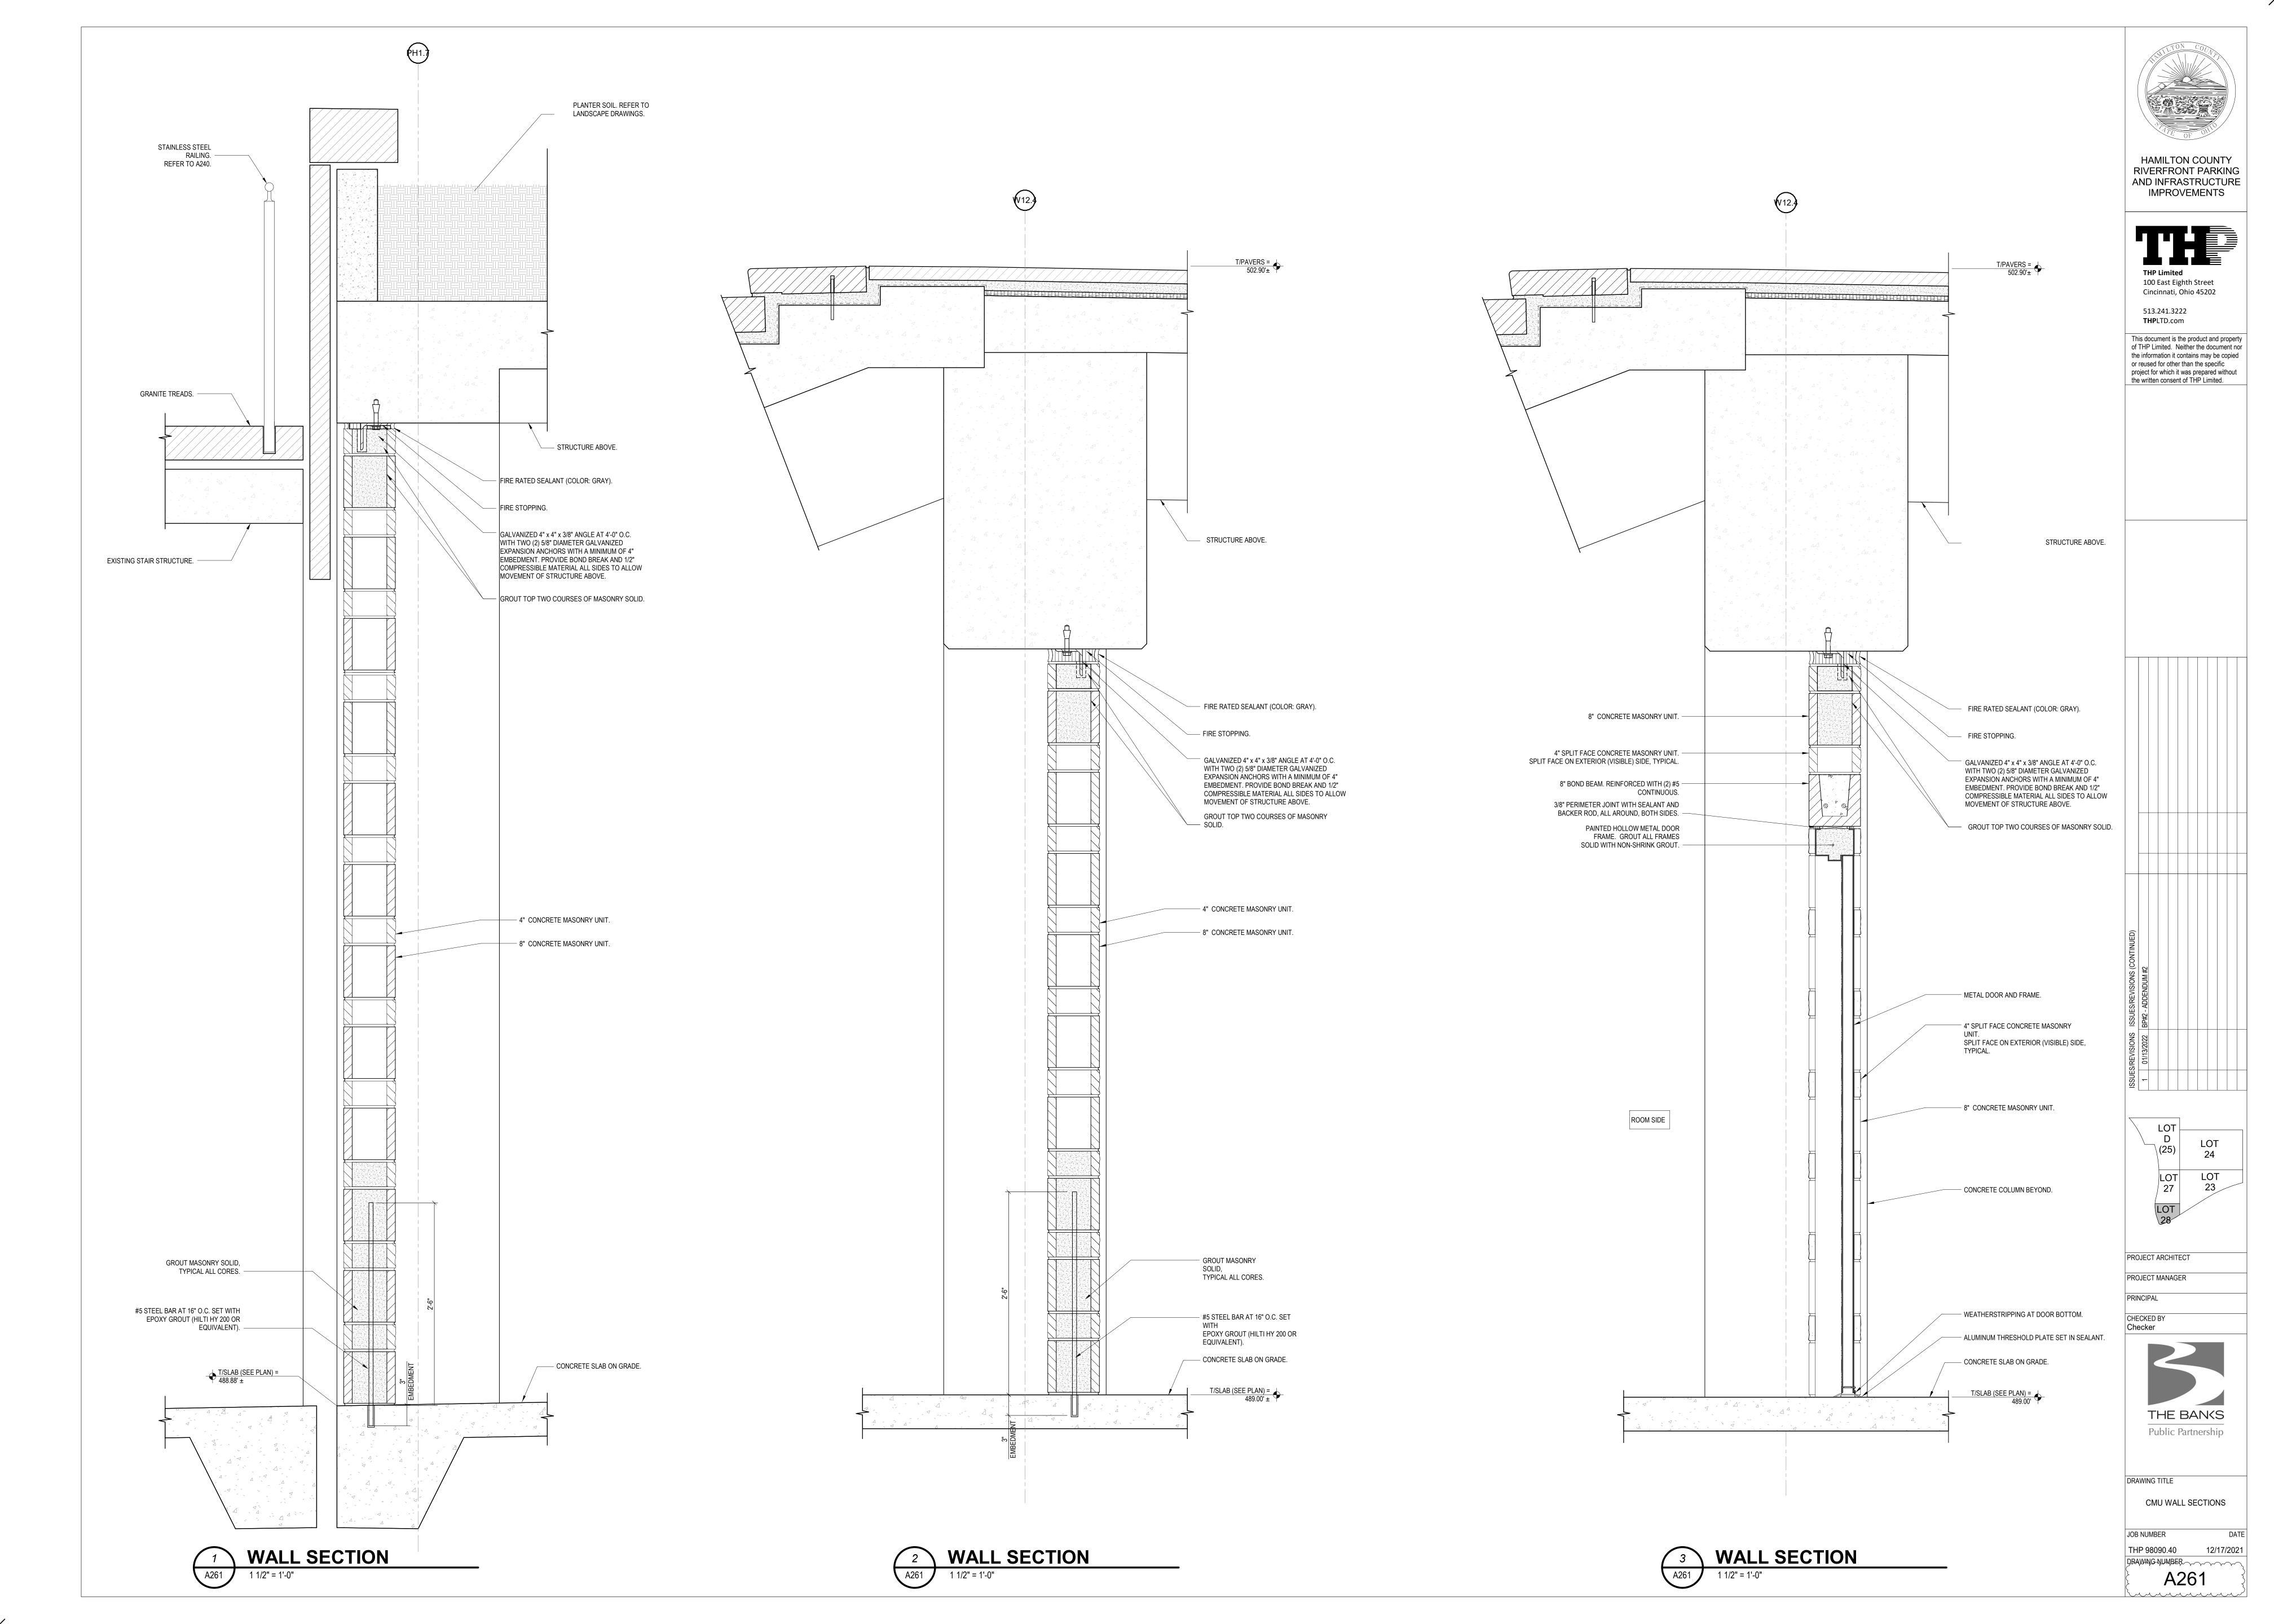
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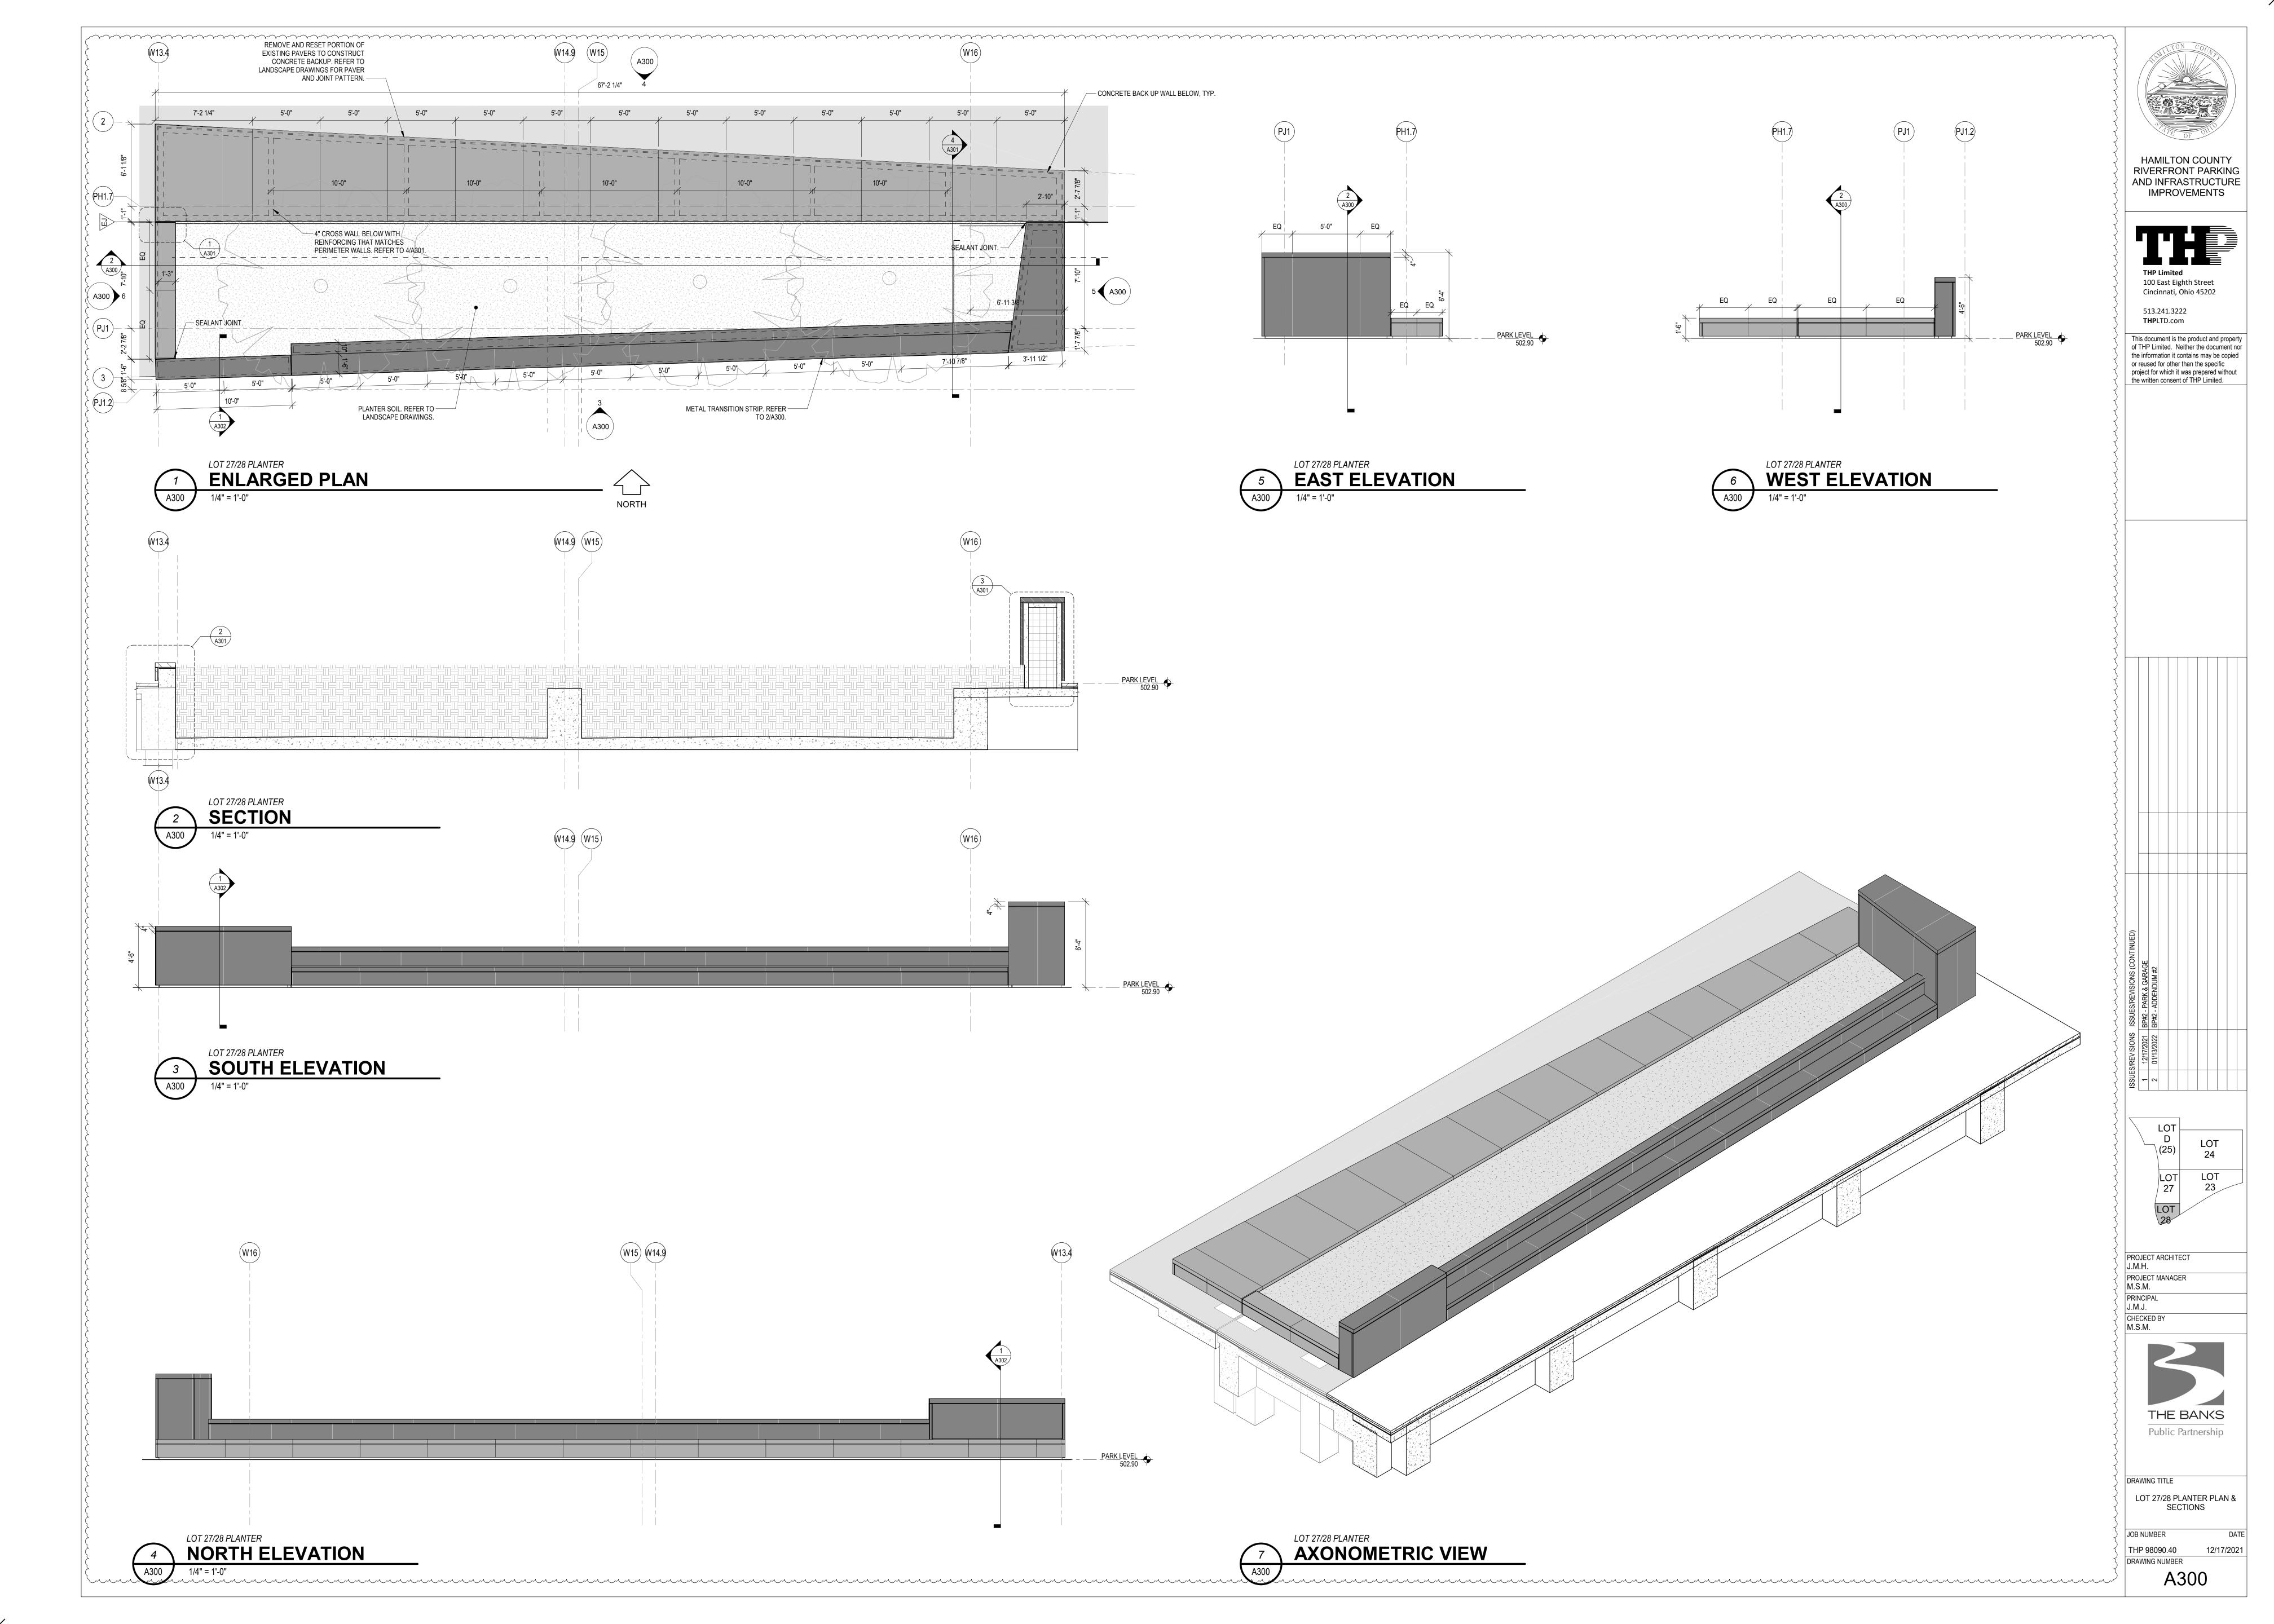
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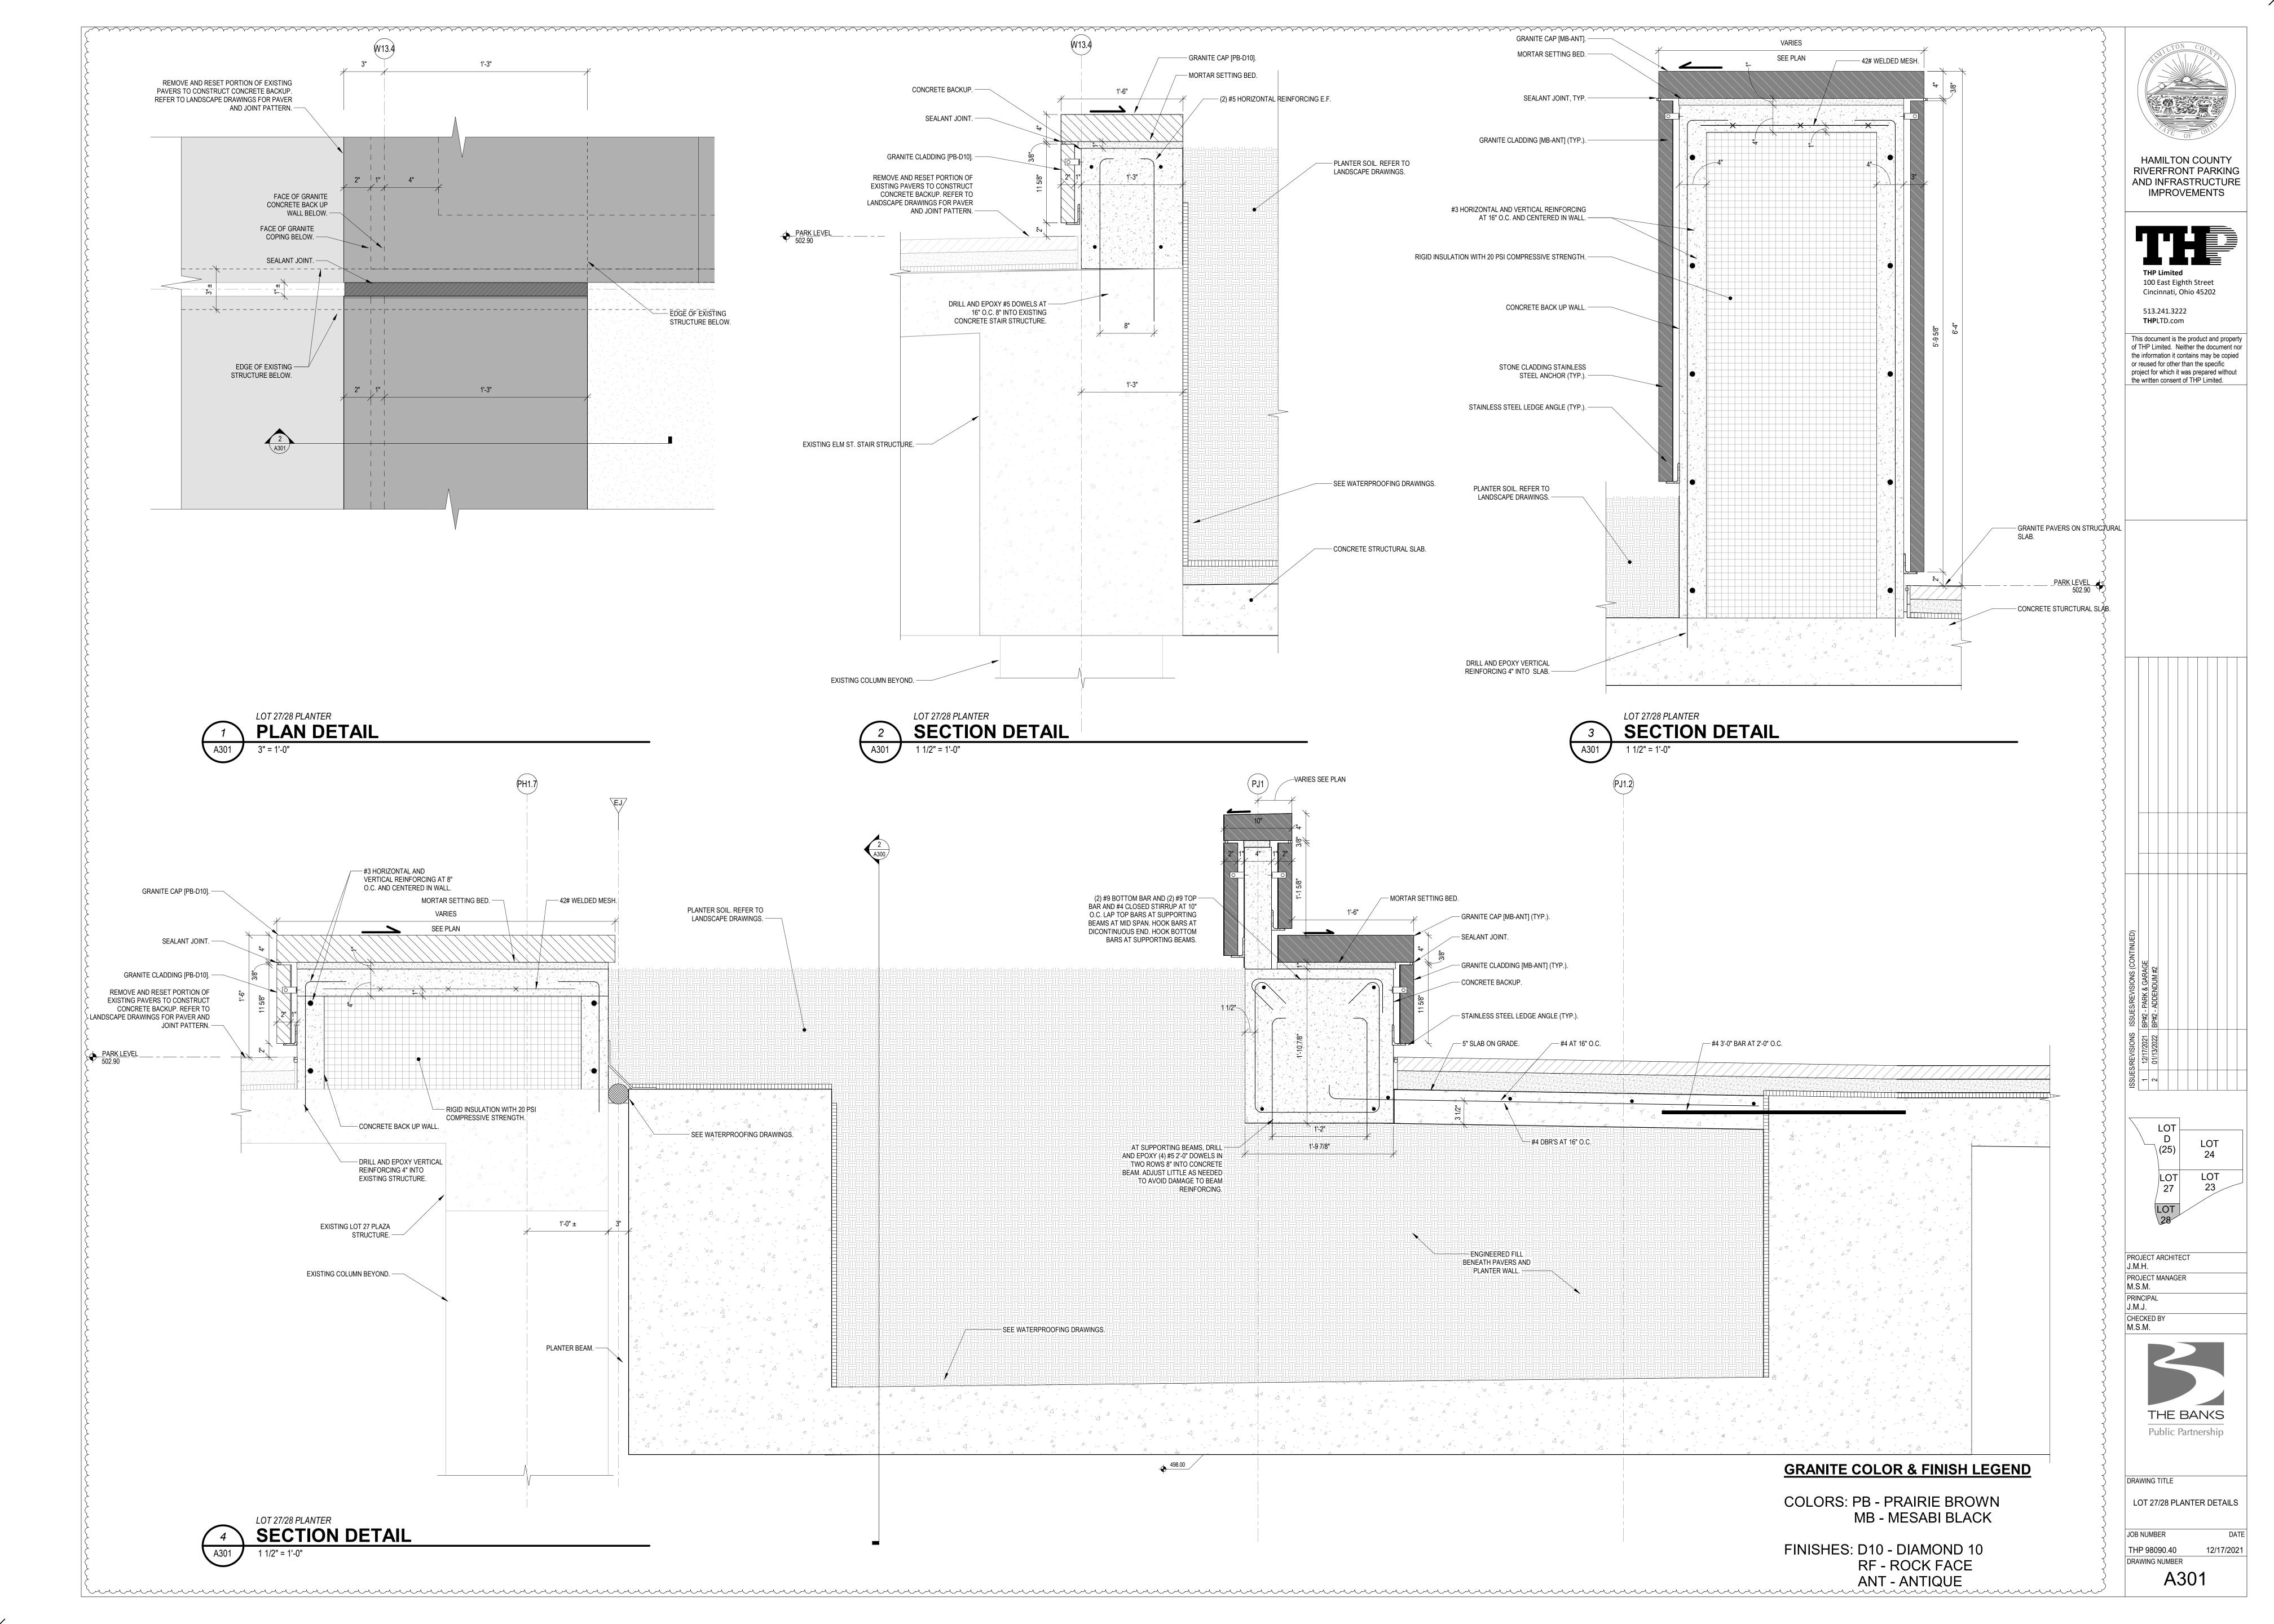
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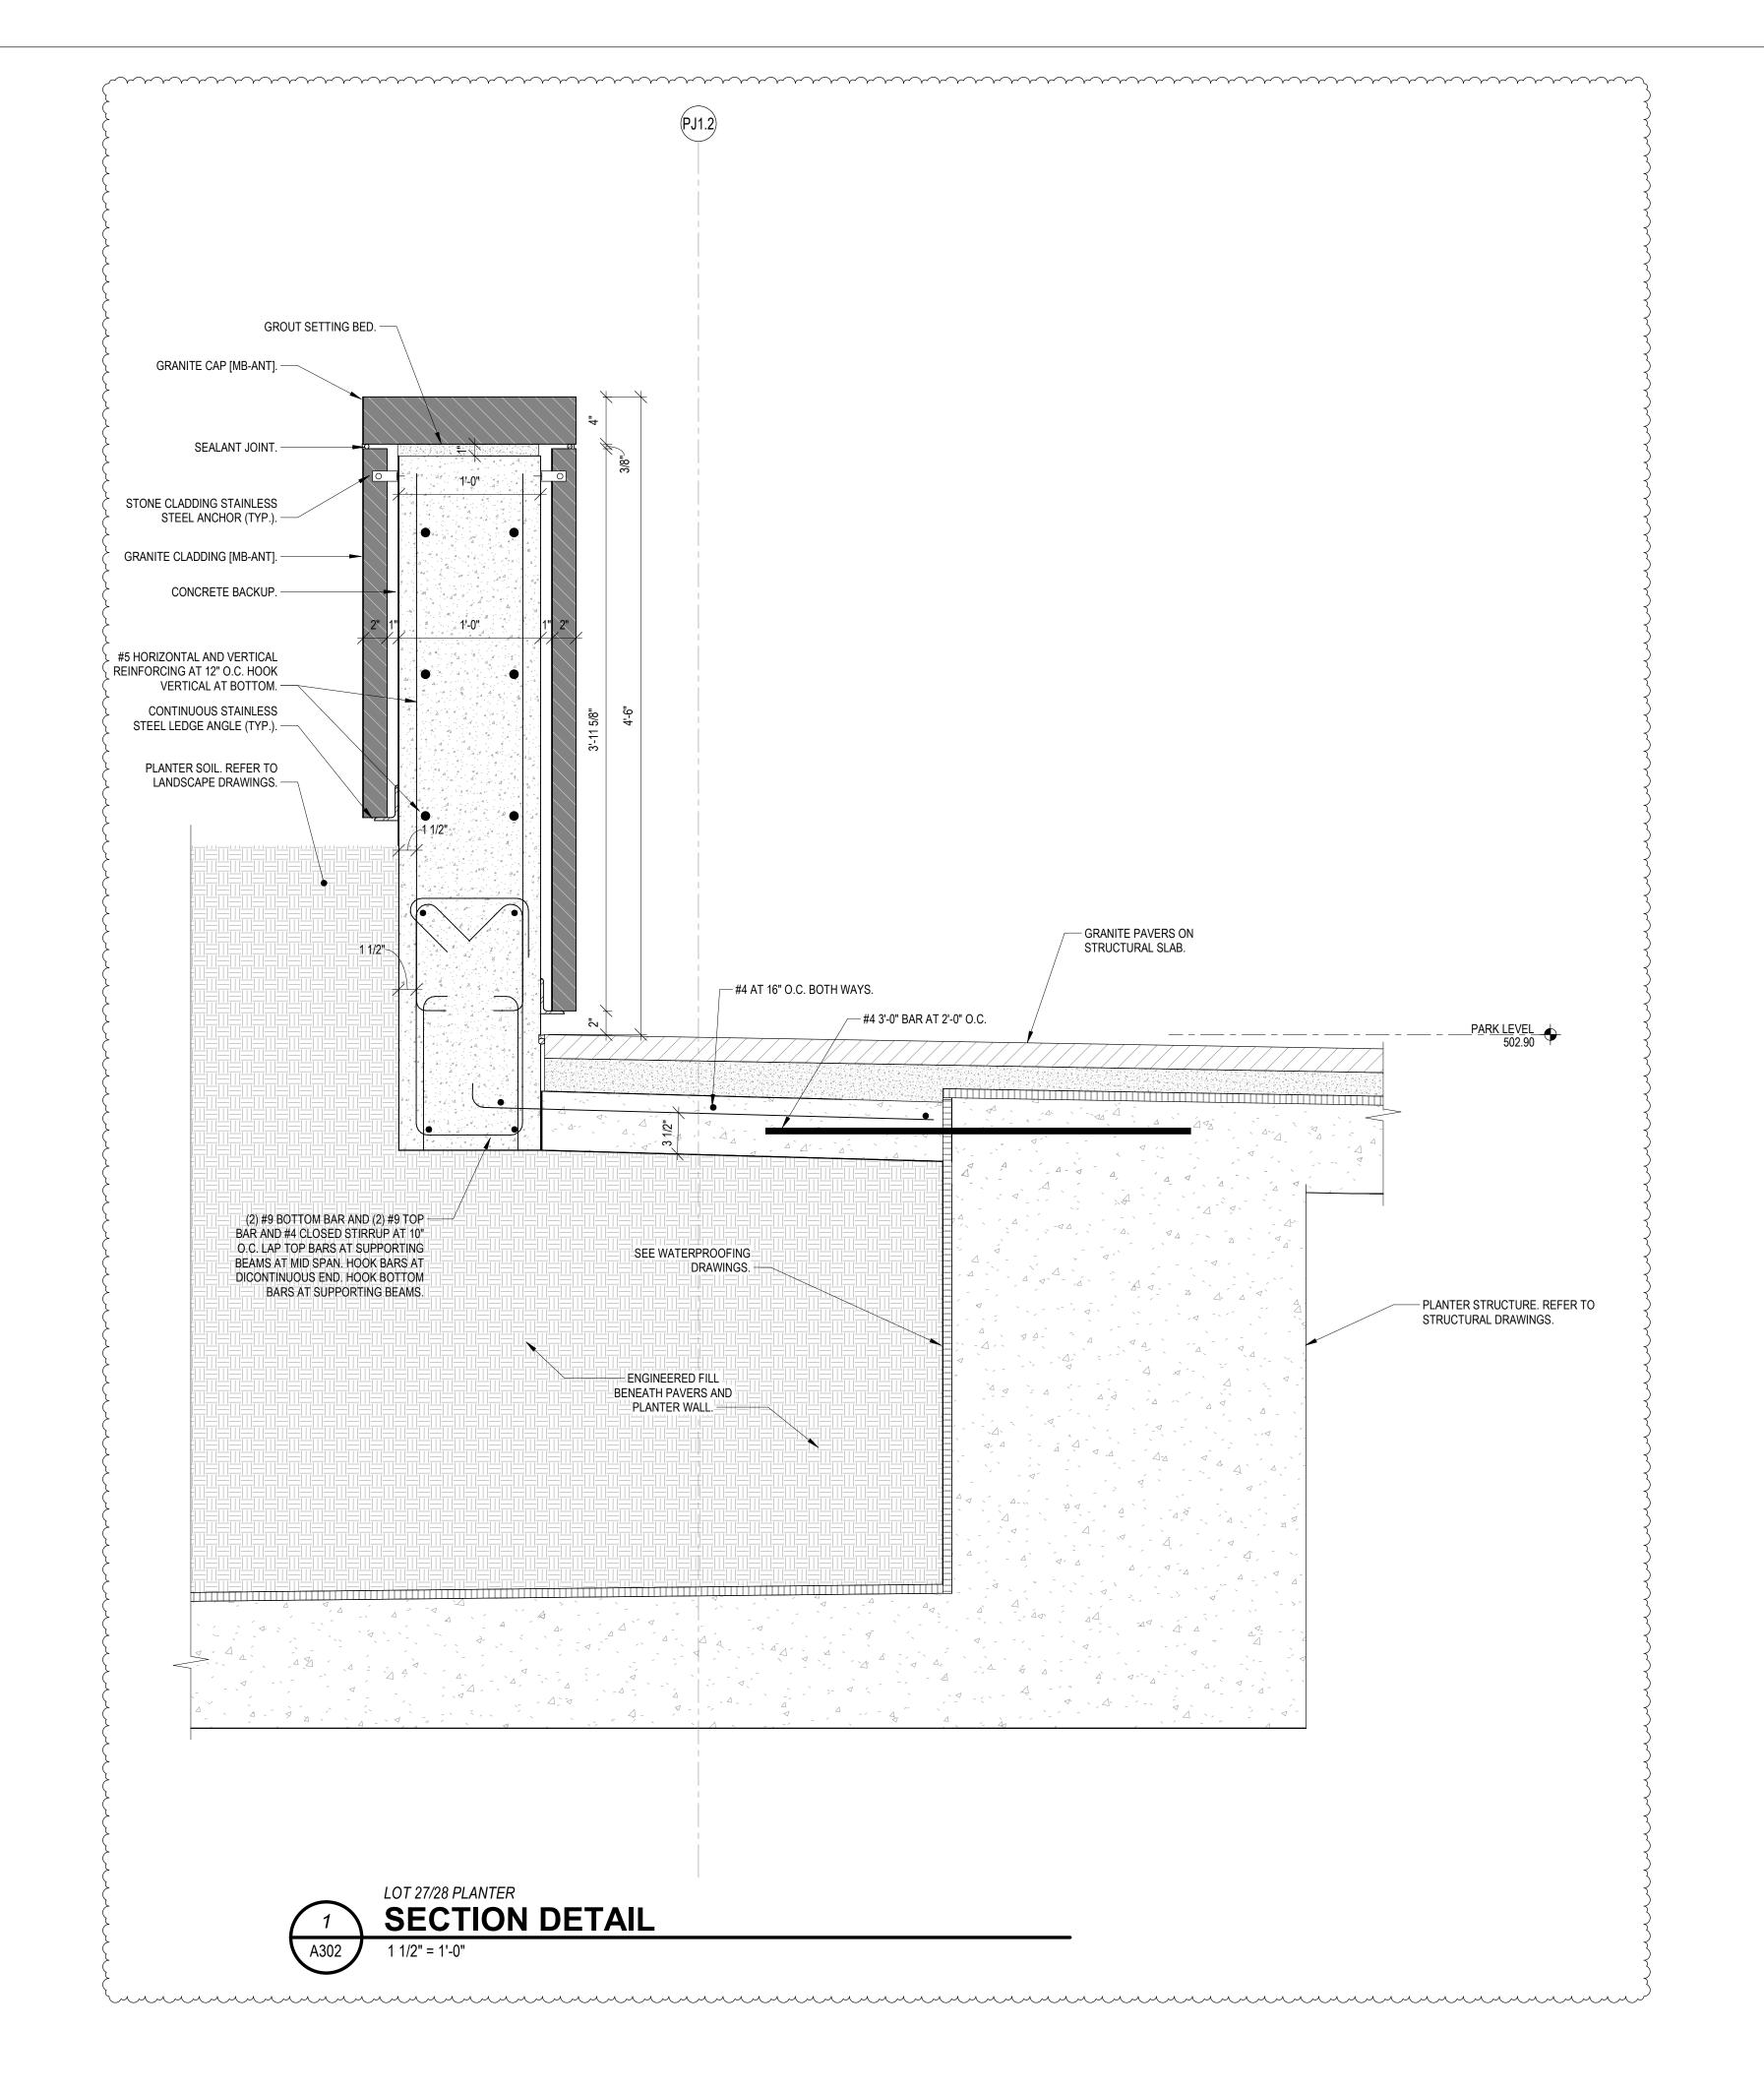
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A260

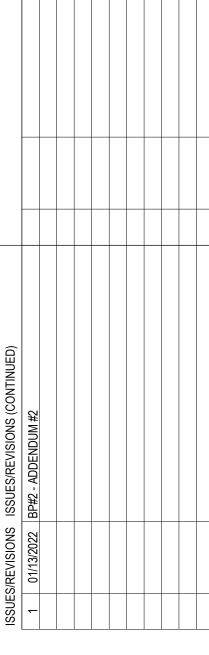

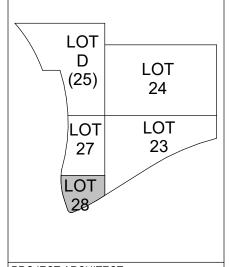










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LOT D (25)	LOT 24
LOT 27	LOT 23
LOT 28	

PROJECT ARCHITECT
J.M.H.
PROJECT MANAGER
M.S.M.
PRINCIPAL
J.M.J.
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M.S.M.

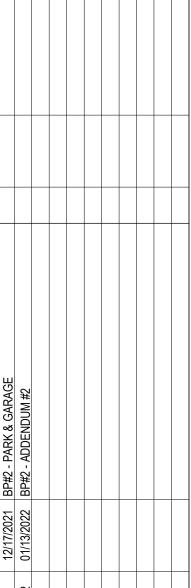

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DRAWING TITLE

LOT 27/28 PLANTER DETAILS


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THP 98090.40 12/17/2020
DRAWING NUMBER

A302

GRANITE COLOR & FINISH LEGEND

COLORS: PB - PRAIRIE BROWN MB - MESABI BLACK

FINISHES: D10 - DIAMOND 10 RF - ROCK FACE ANT - ANTIQUE

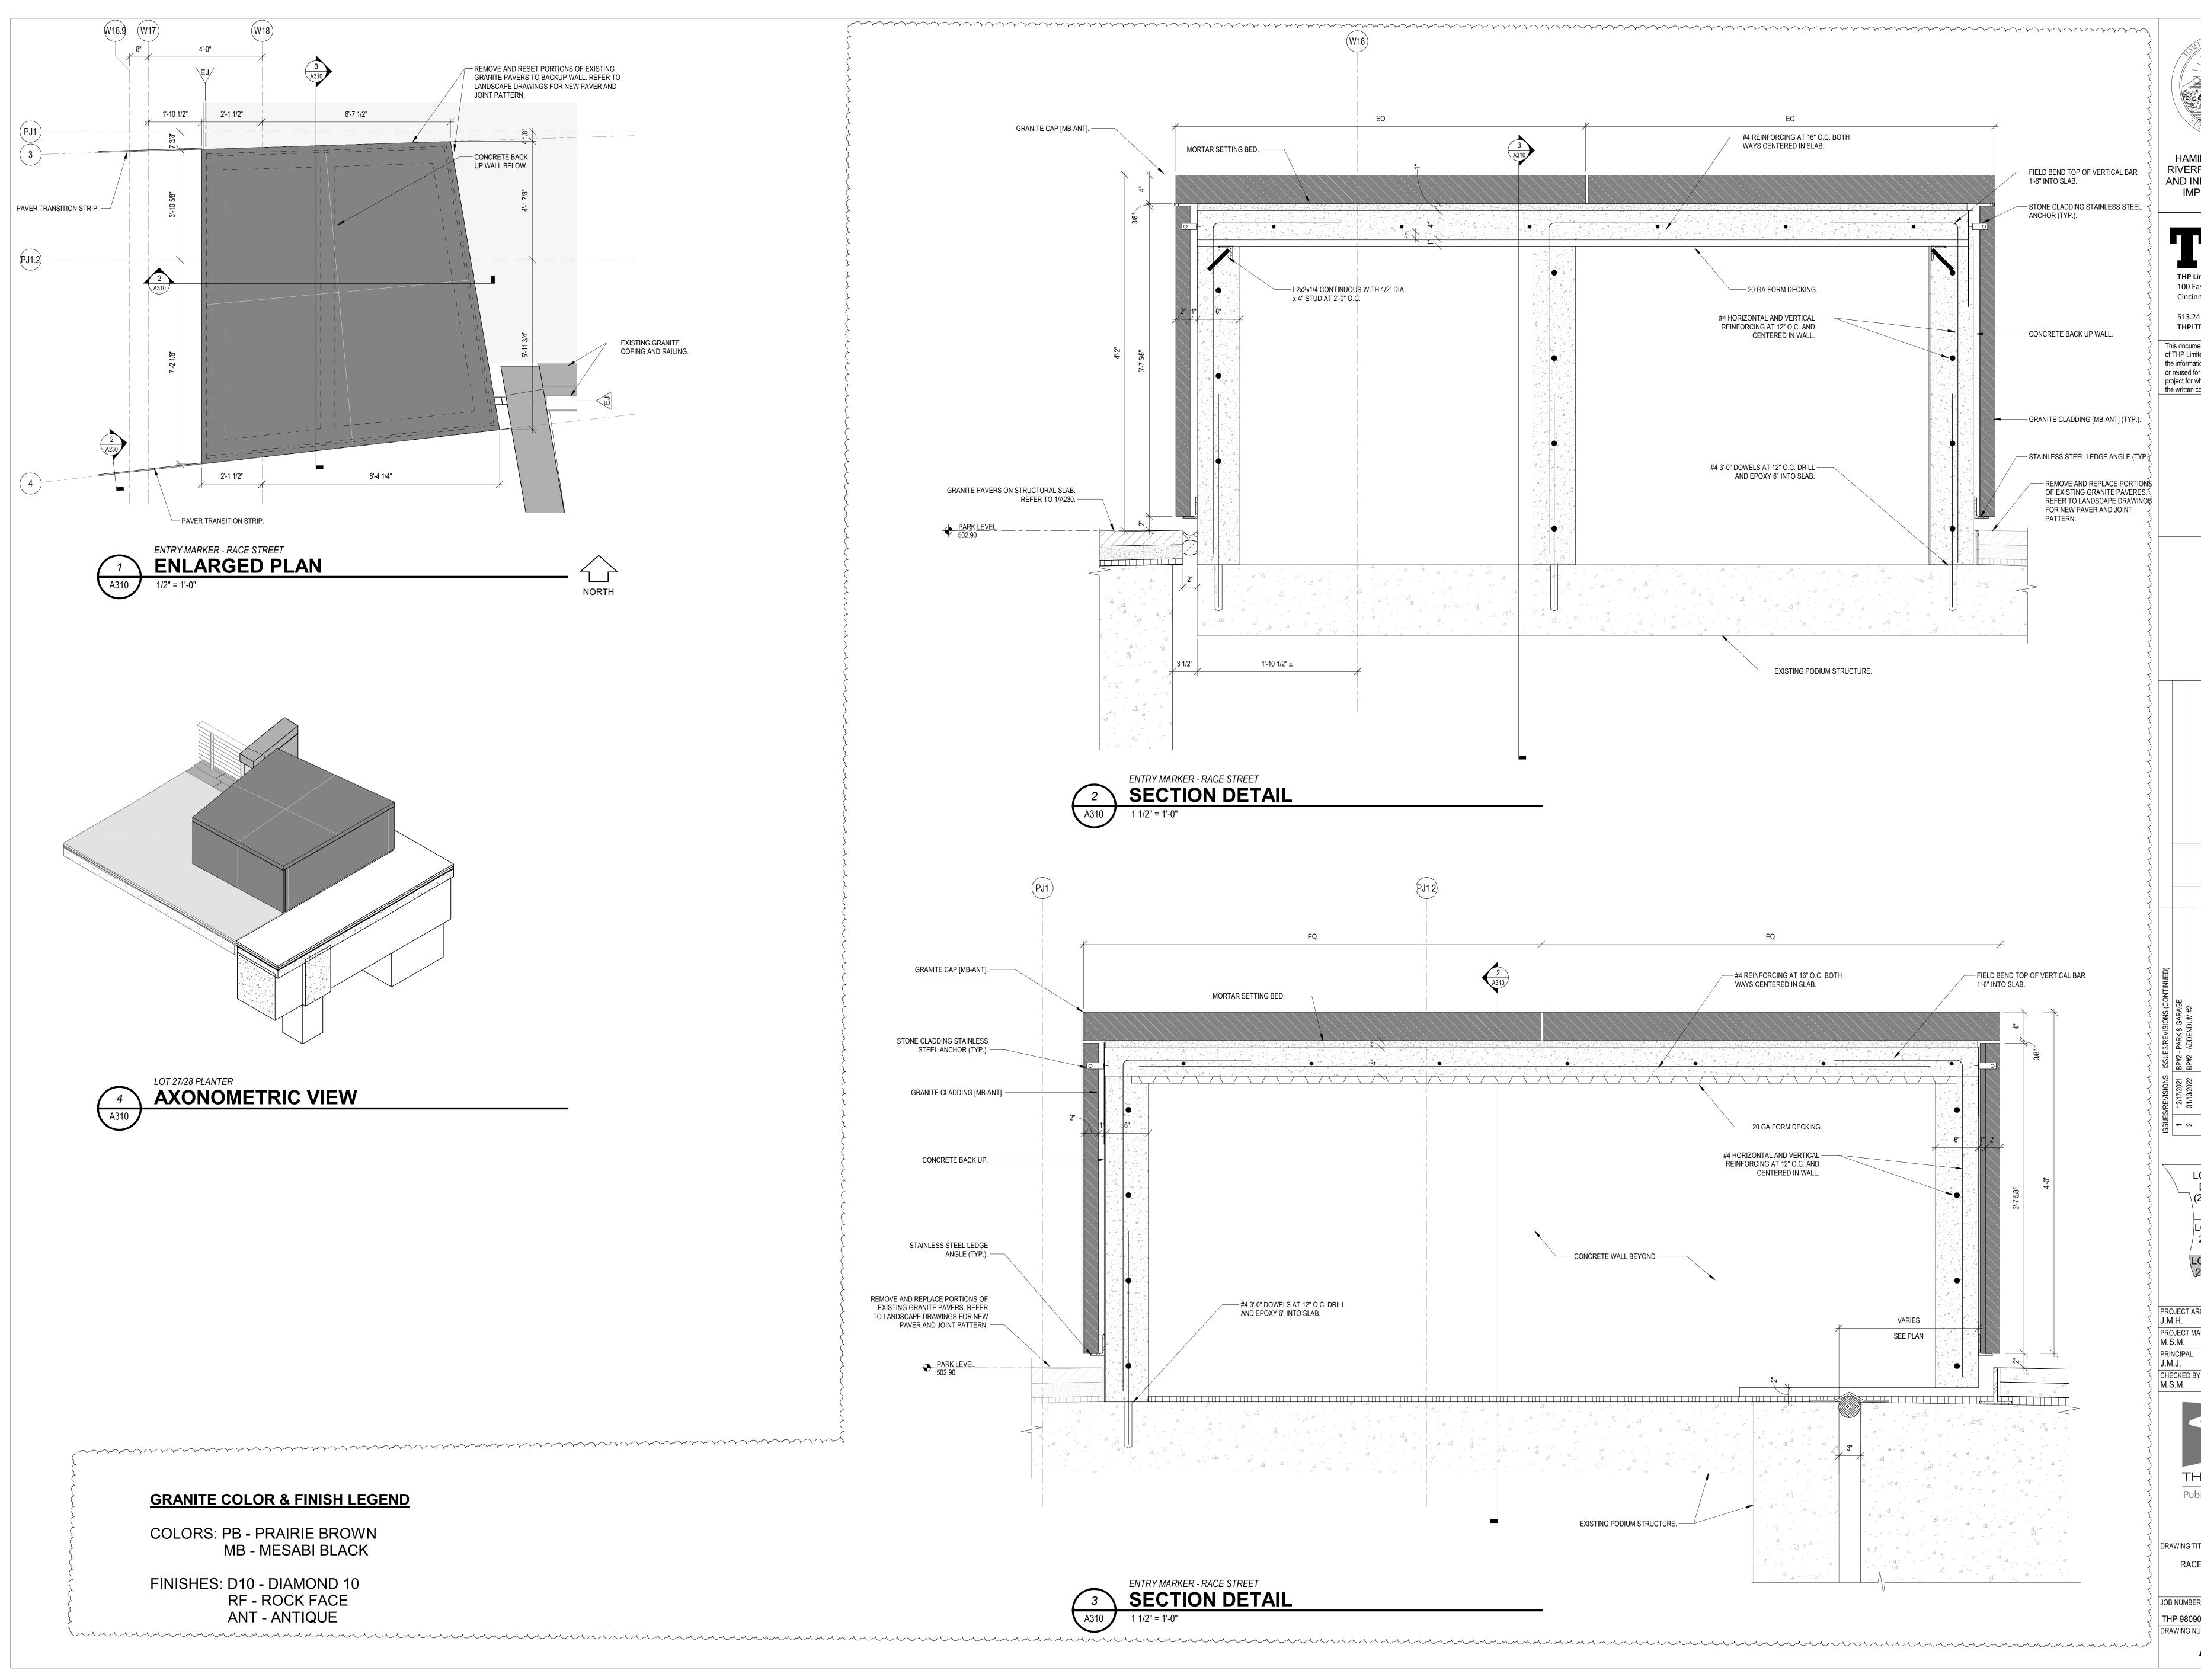



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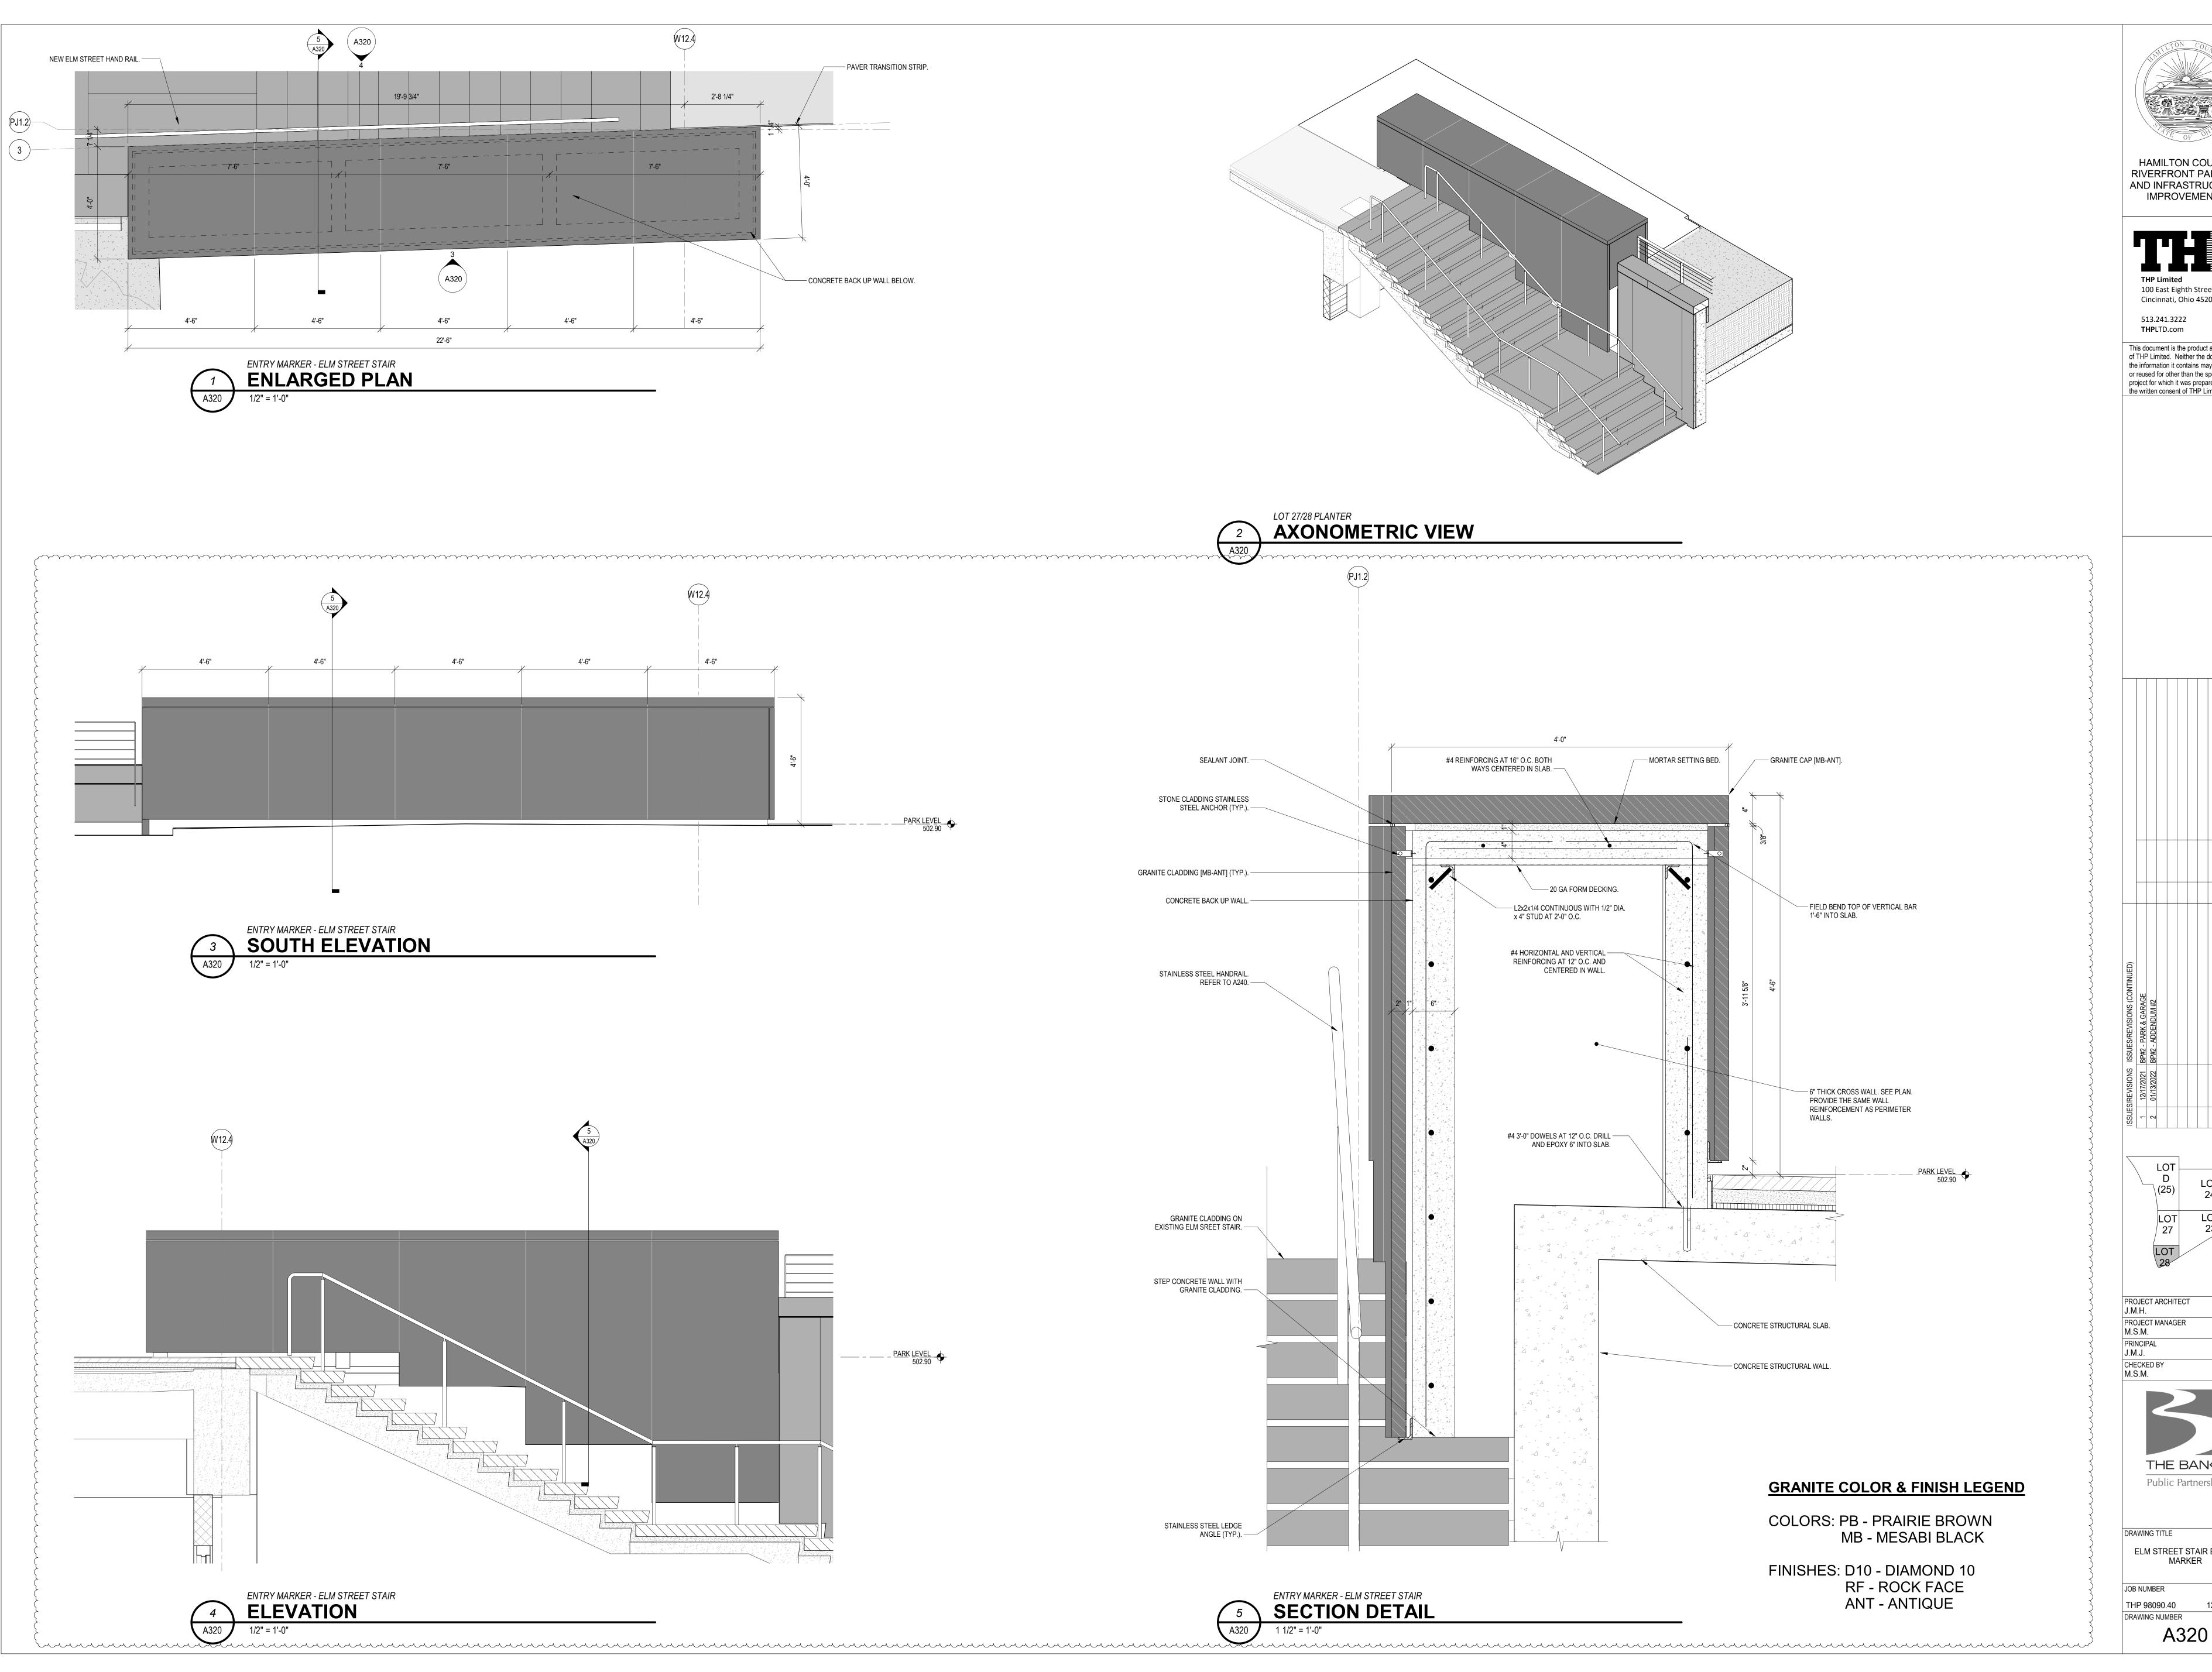
PROJECT ARCHITECT J.M.H. PROJECT MANAGER M.S.M. PRINCIPAL J.M.J.

THE BANKS

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DRAWING TITLE RACE STREET ENTRY MARKER

JOB NUMBER THP 98090.40 DRAWING NUMBER





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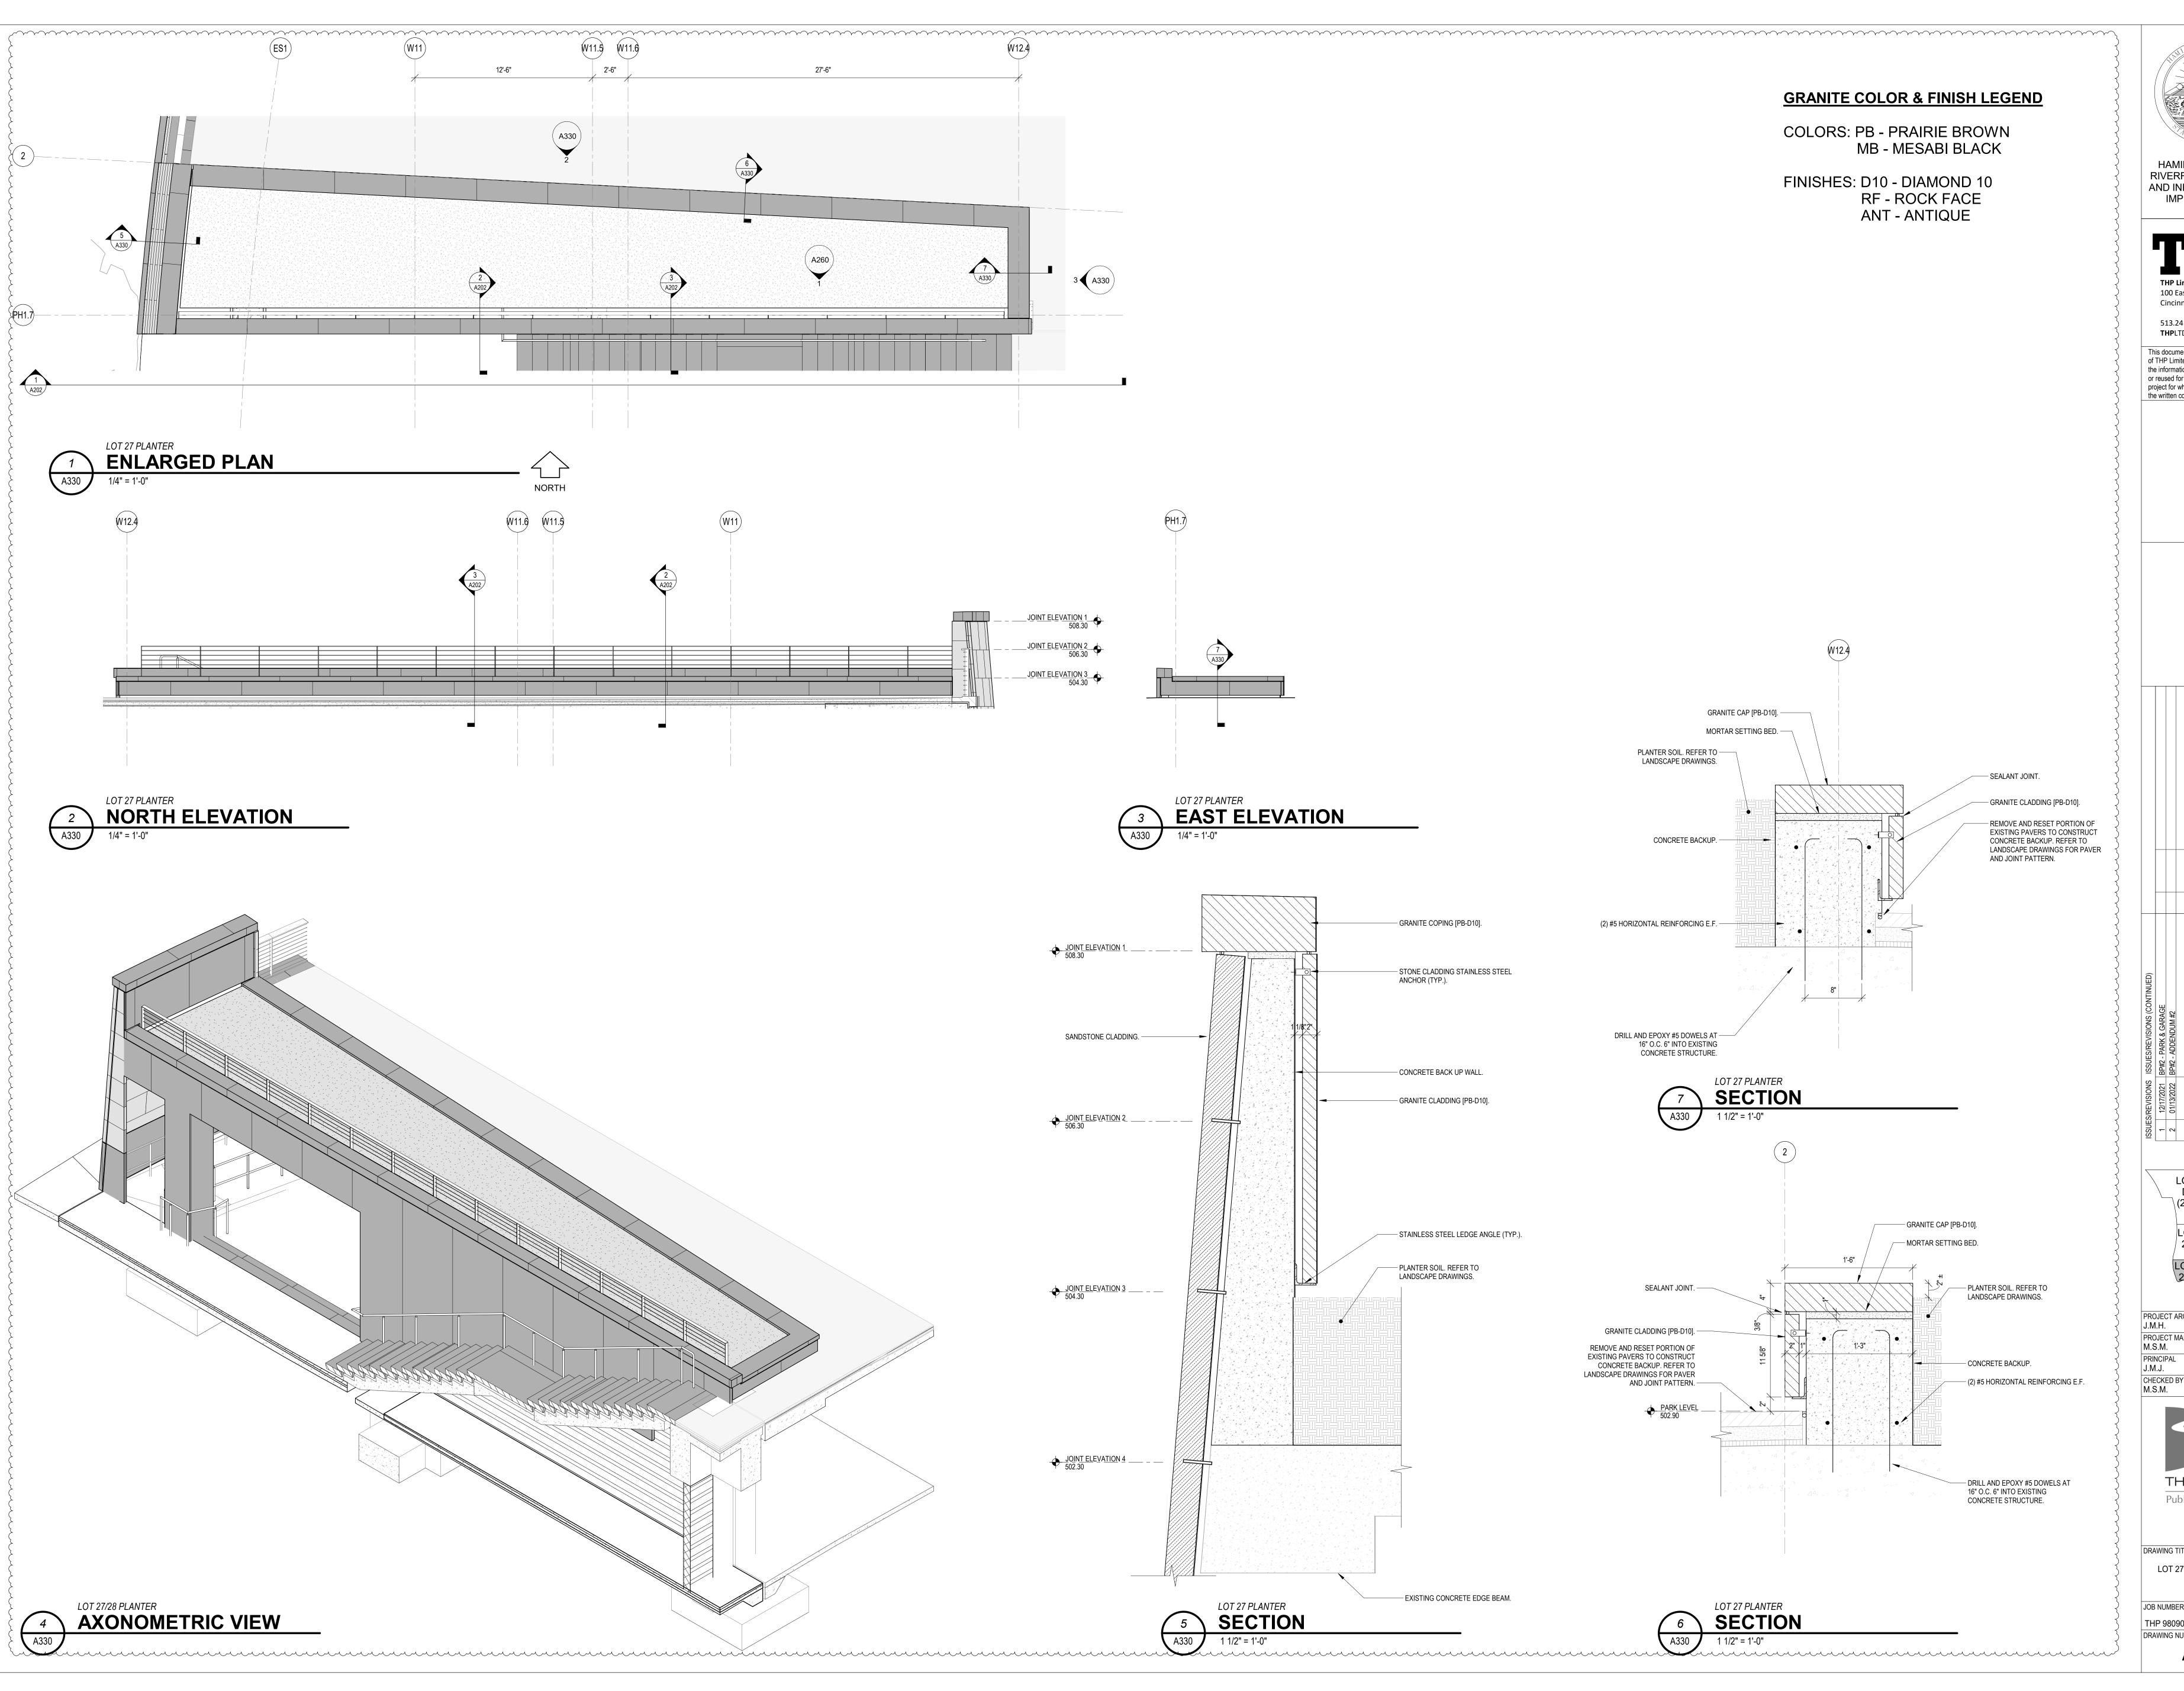
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PROJECT ARCHITECT PROJECT MANAGER

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ELM STREET STAIR ENTRY MARKER

THP 98090.40 DRAWING NUMBER









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LOT 27 PLANTER PLAN & SECTIONS

JOB NUMBER THP 98090.40 DRAWING NUMBER A330

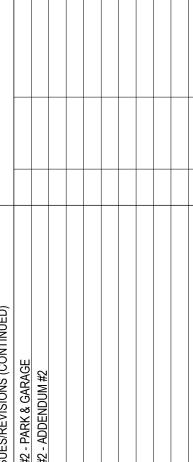


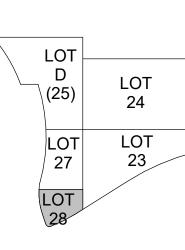




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M.S.M.

PRINCIPAL
J.M.J.
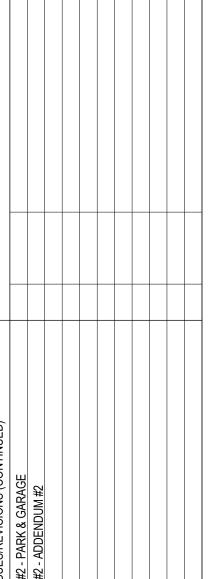
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M.S.M.

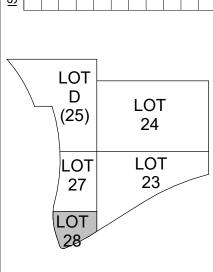


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UPPER LANDING DISPLAY


JOB NUMBER DA
THP 98090.40 12/17/20


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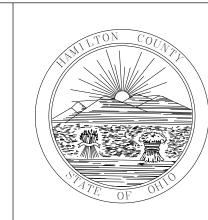
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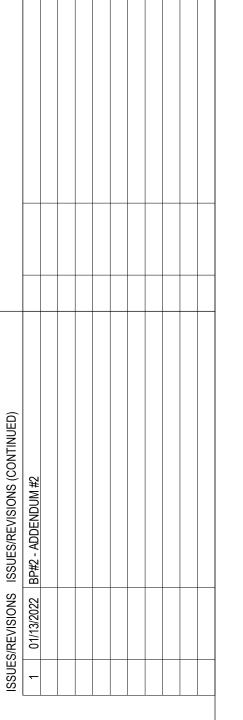
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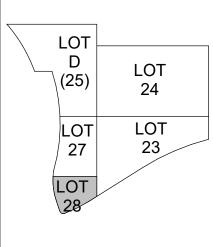


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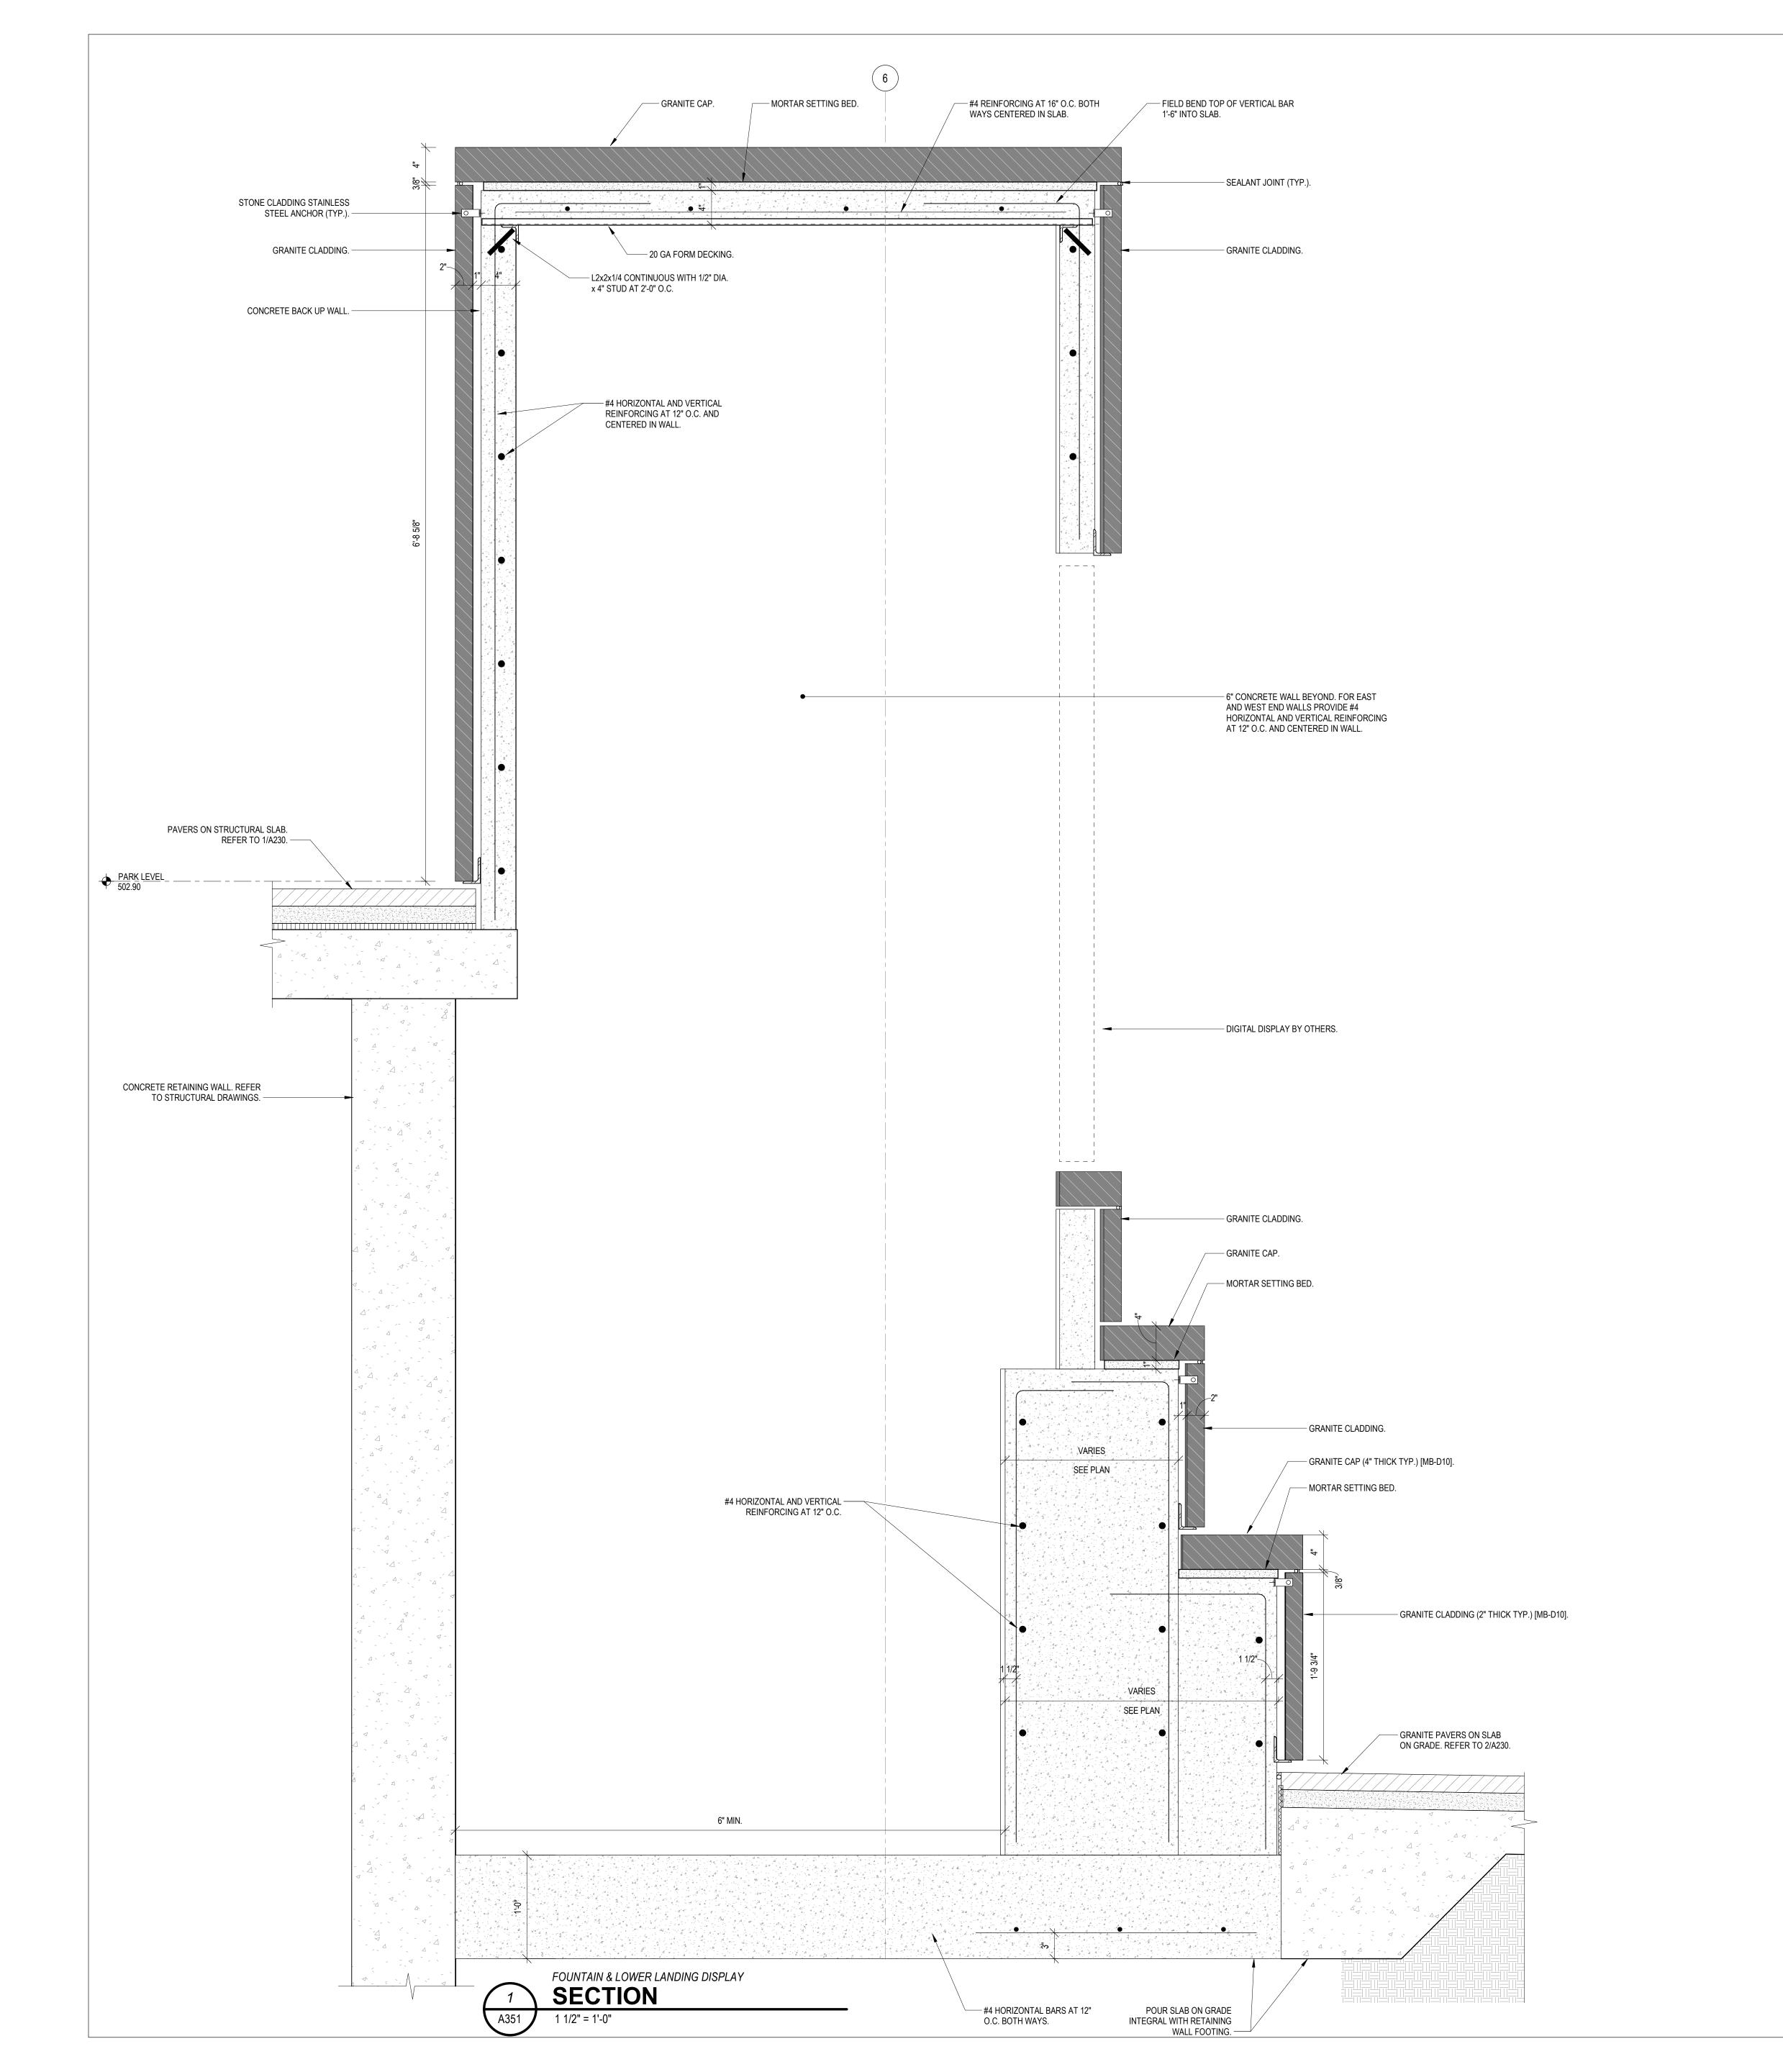
FOUNTAIN & LOWER LANDING
DISPLAY

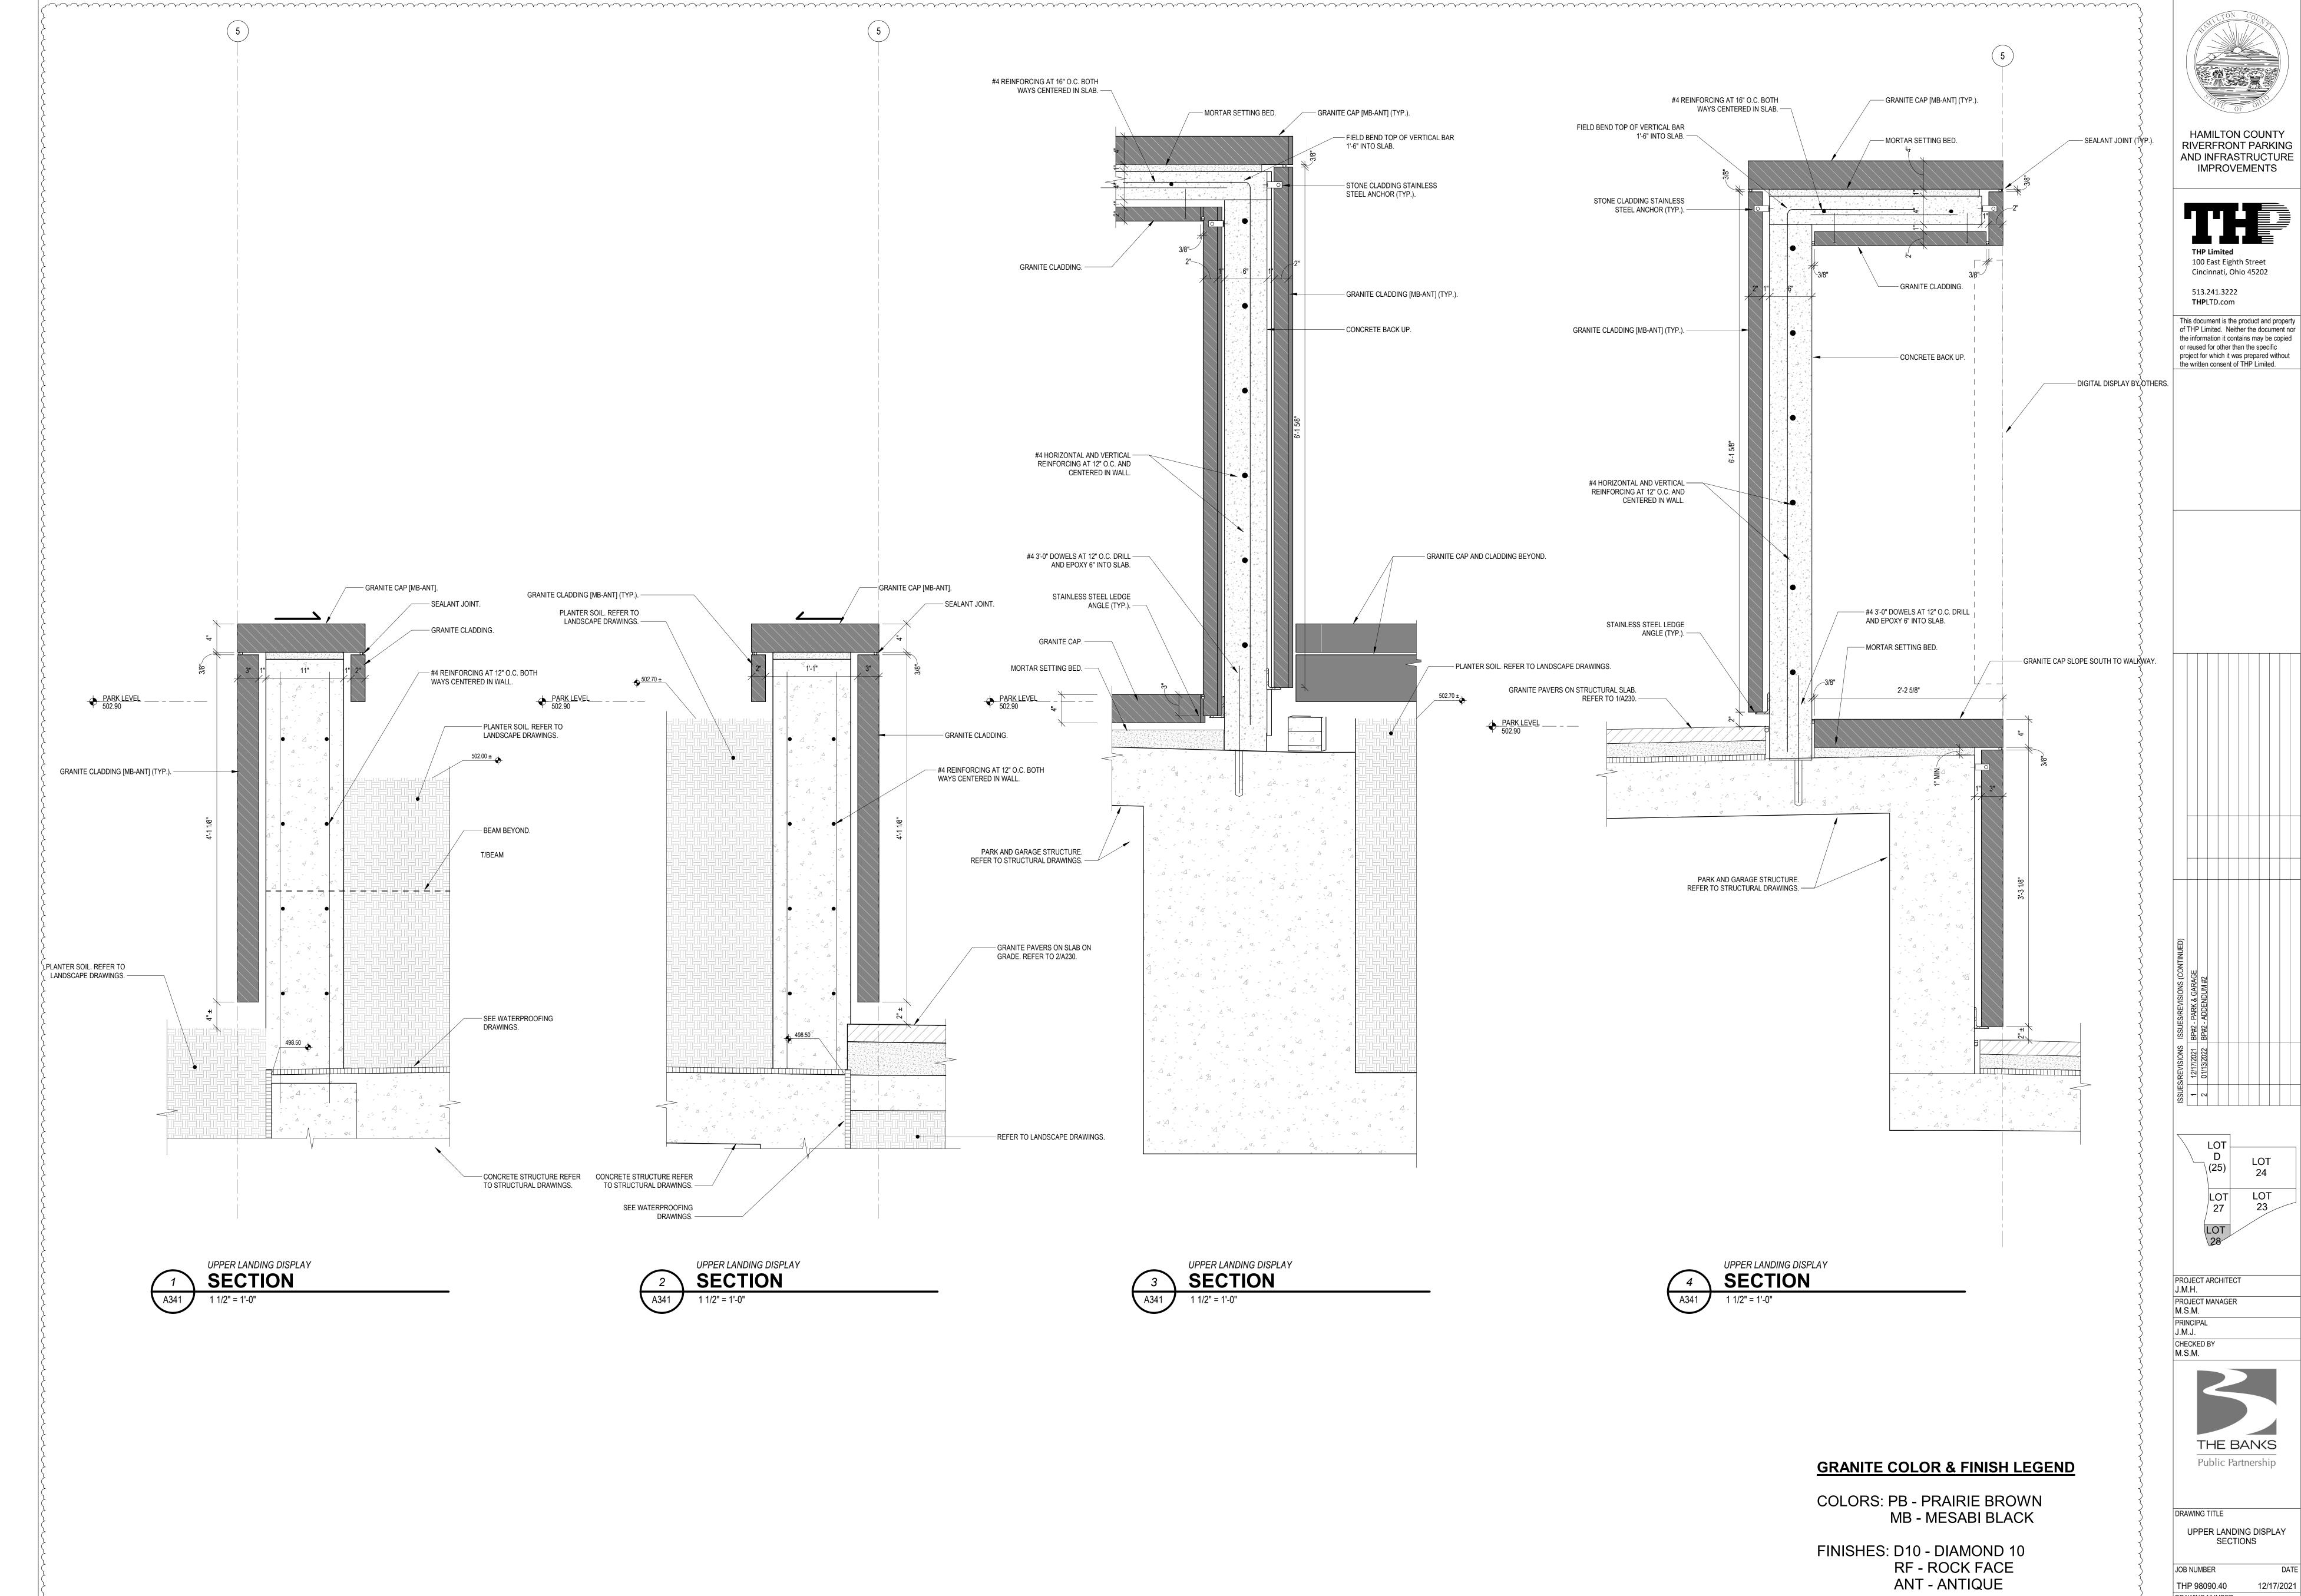JOB NUMBER DATE

THP 98090.40 12/17/2021

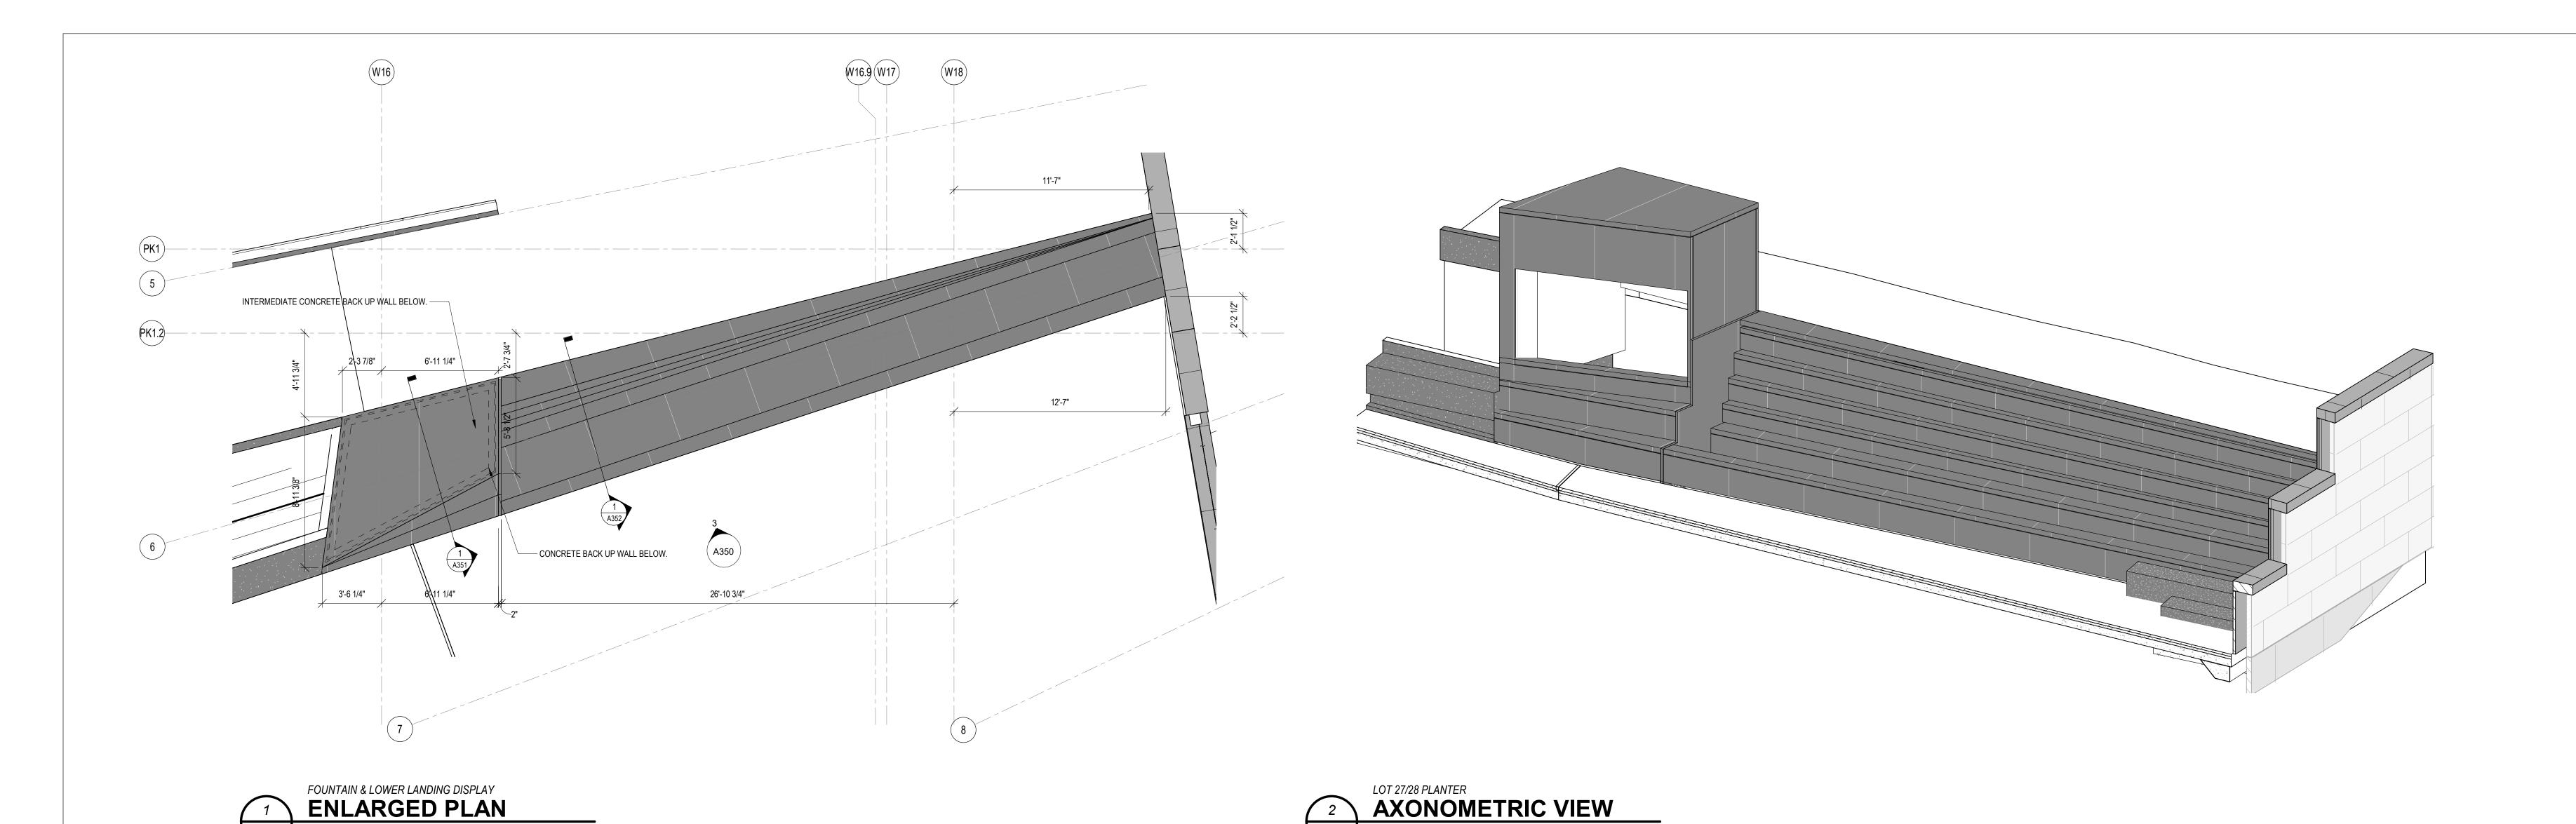DRAWING NUMBER
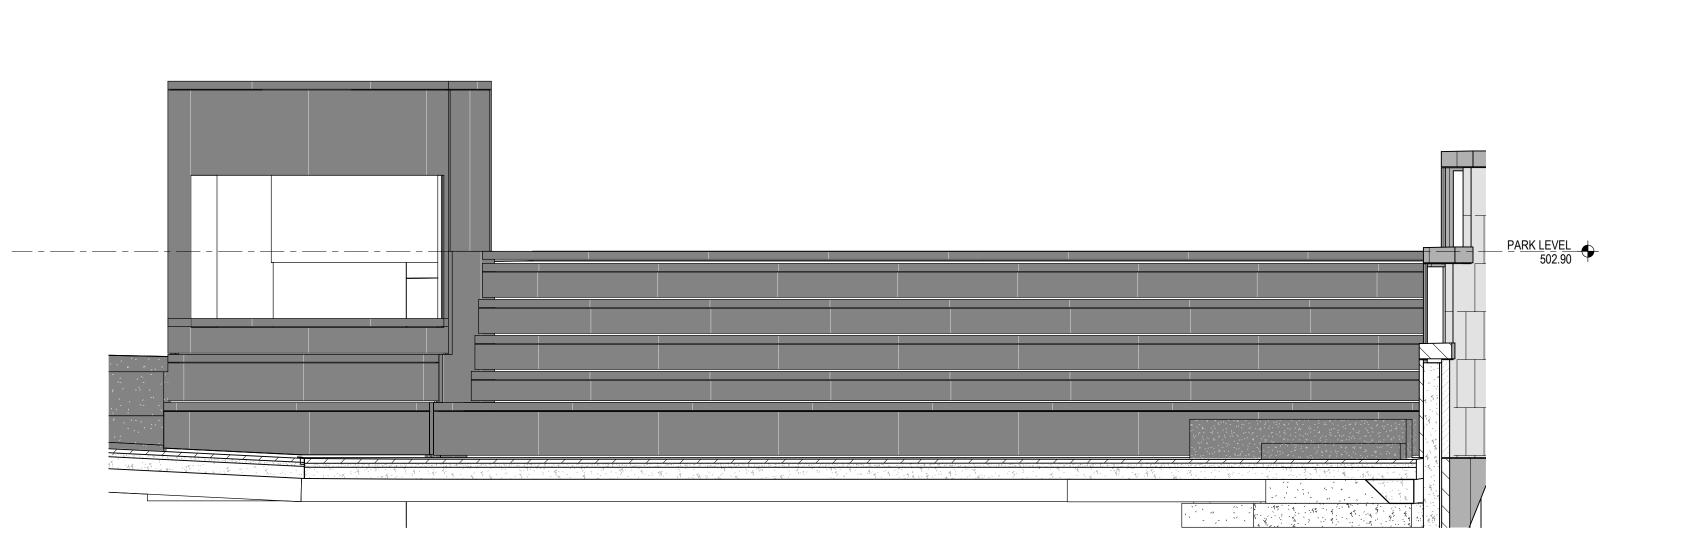
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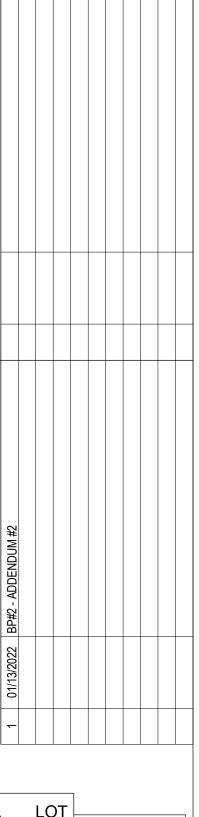






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GRANITE COLOR & FINISH LEGEND

MB - MESABI BLACK

COLORS: PB - PRAIRIE BROWN

FINISHES: D10 - DIAMOND 10 RF - ROCK FACE ANT - ANTIQUE PROJECT ARCHITECT

PROJECT MANAGER

THE BANKS
Public Partnership


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LOWER LANDING DISPLAY
SECTION & DETAILS

JOB NUMBER DATE

THP 98090.40 12/17/2021

DRAWING NUMBER




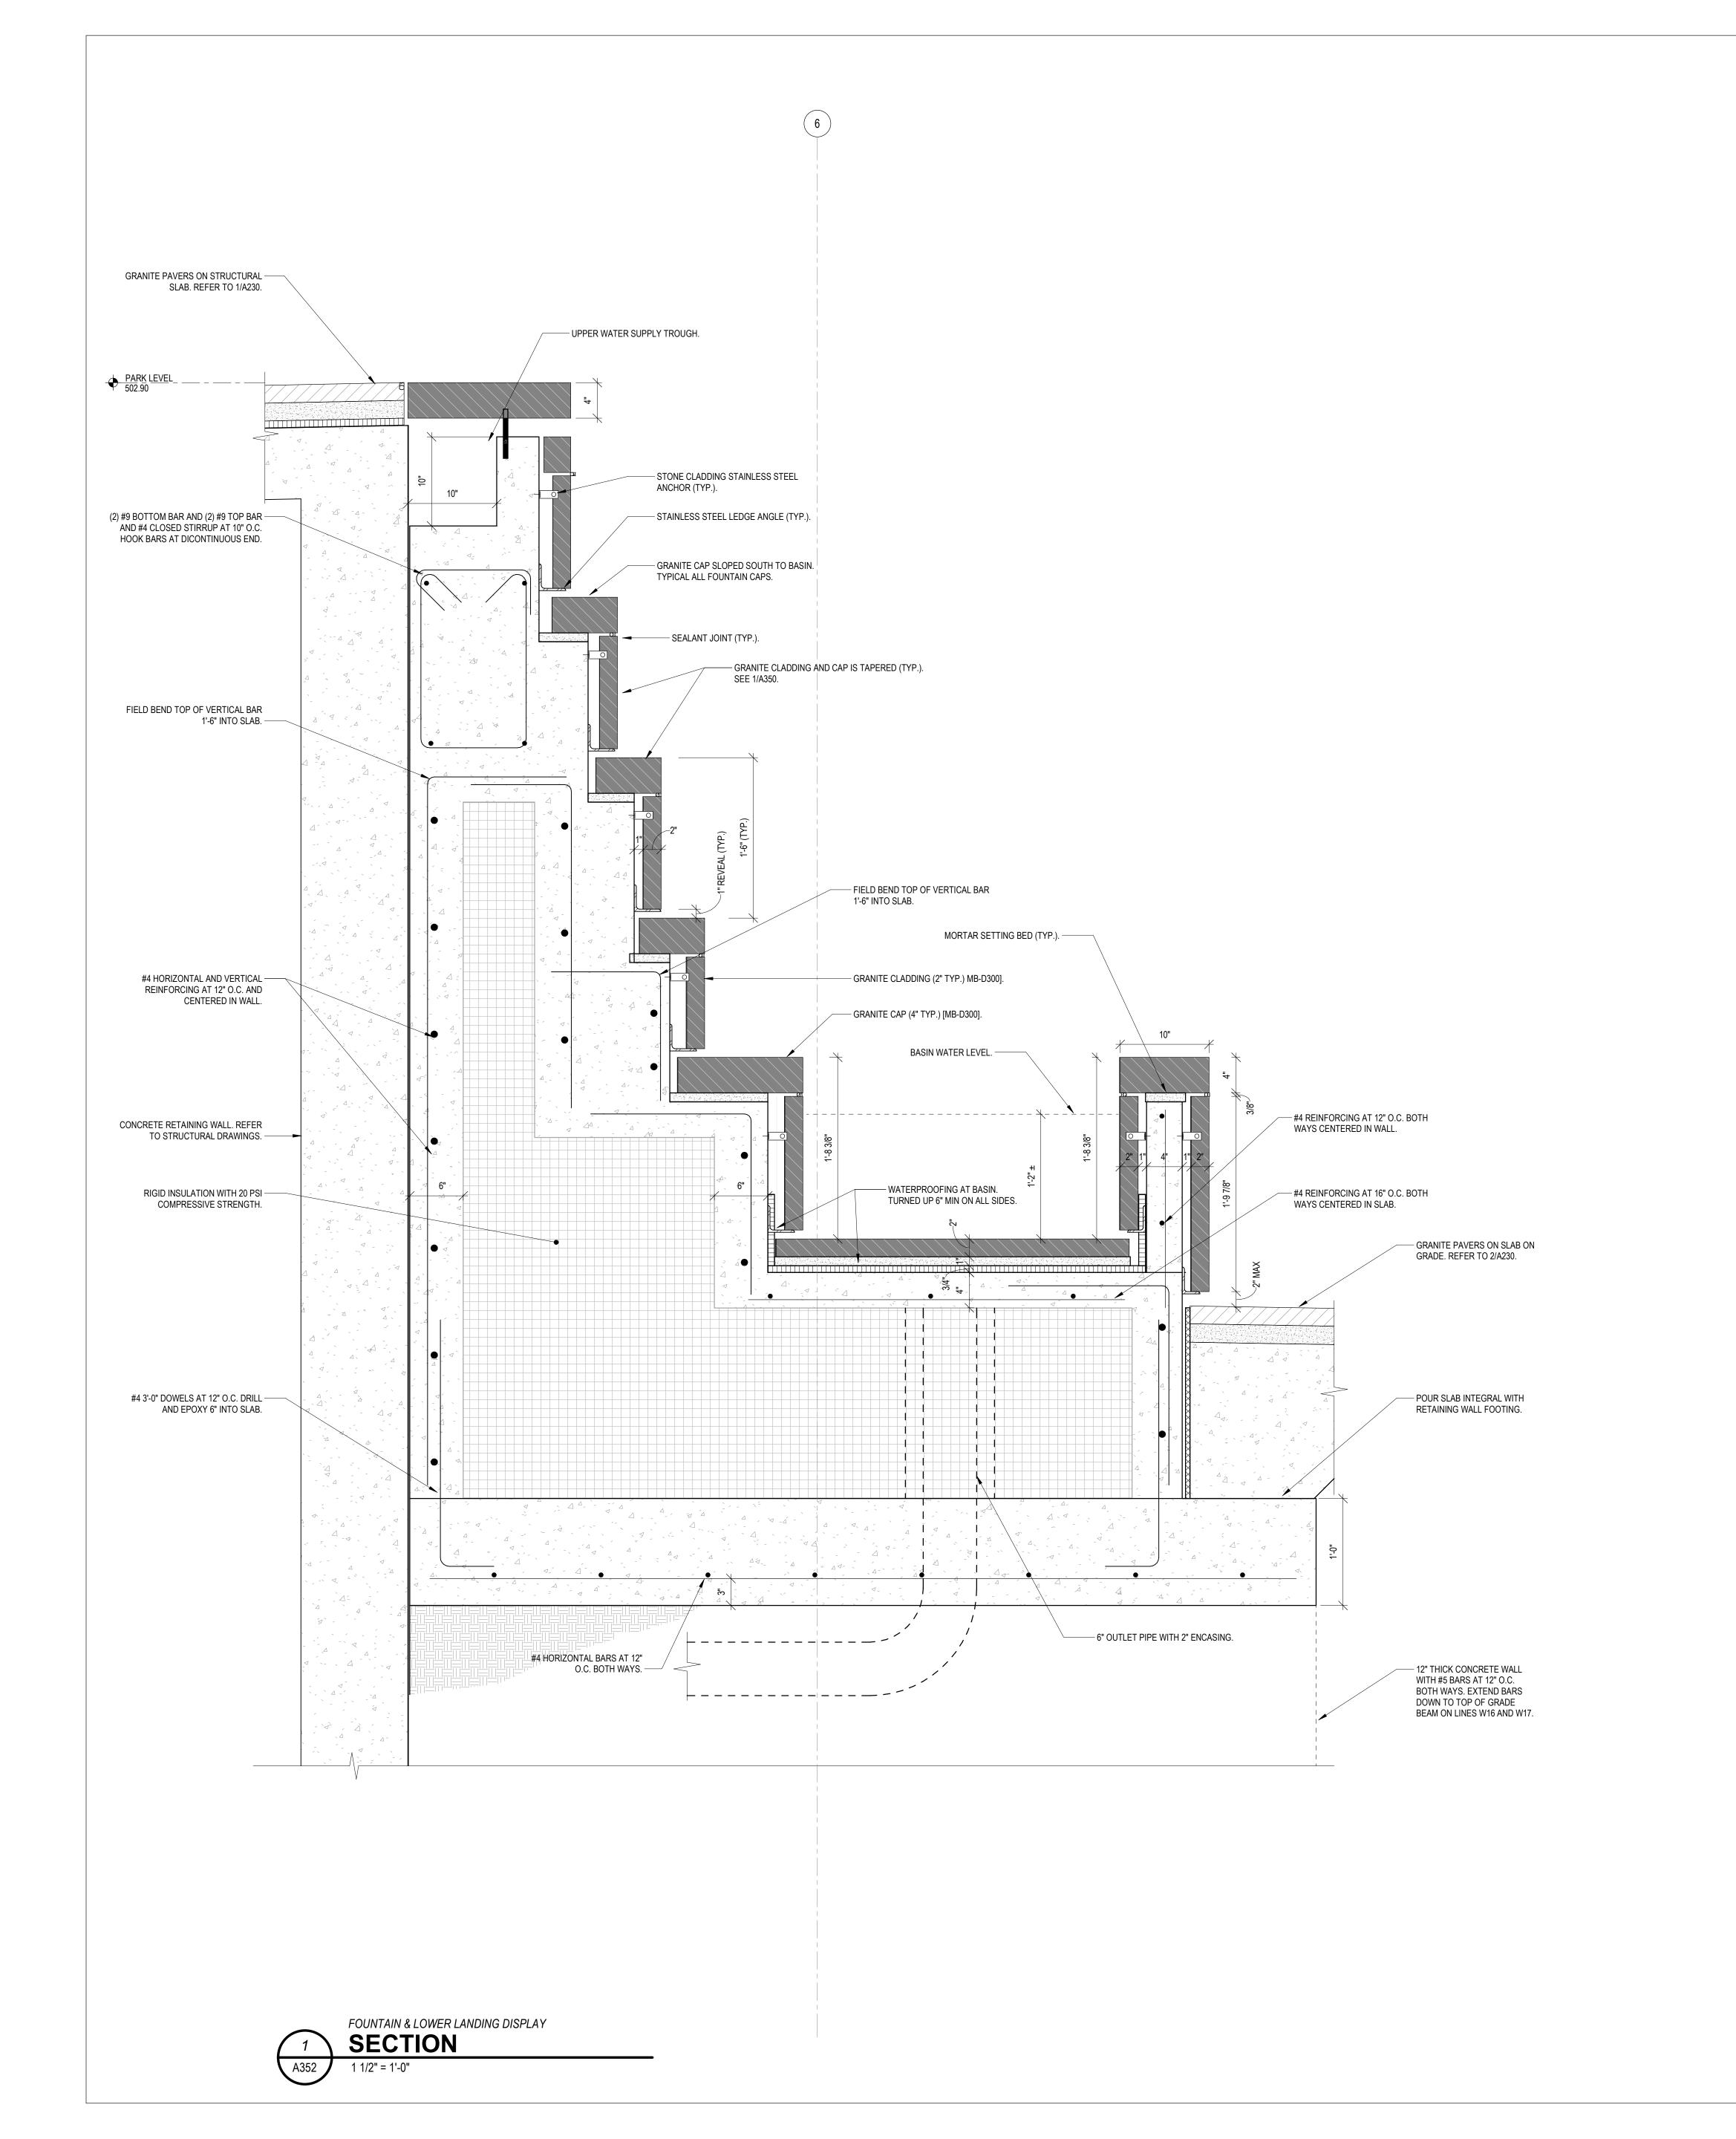




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PRINCIPAL

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GRANITE COLOR & FINISH LEGEND

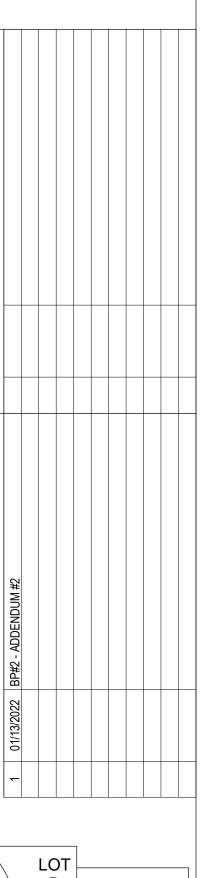MB - MESABI BLACK

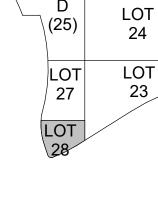D10 - DIAMOND 10

RF - ROCK FACE ANT - ANTIQUE

COLORS: PB - PRAIRIE BROWN

FINISHES: D300 - DIAMOND 300





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FOUNTAIN SECTIONS

JOB NUMBER DATE
THP 98090.40 12/17/2021
DRAWING NUMBER

A352



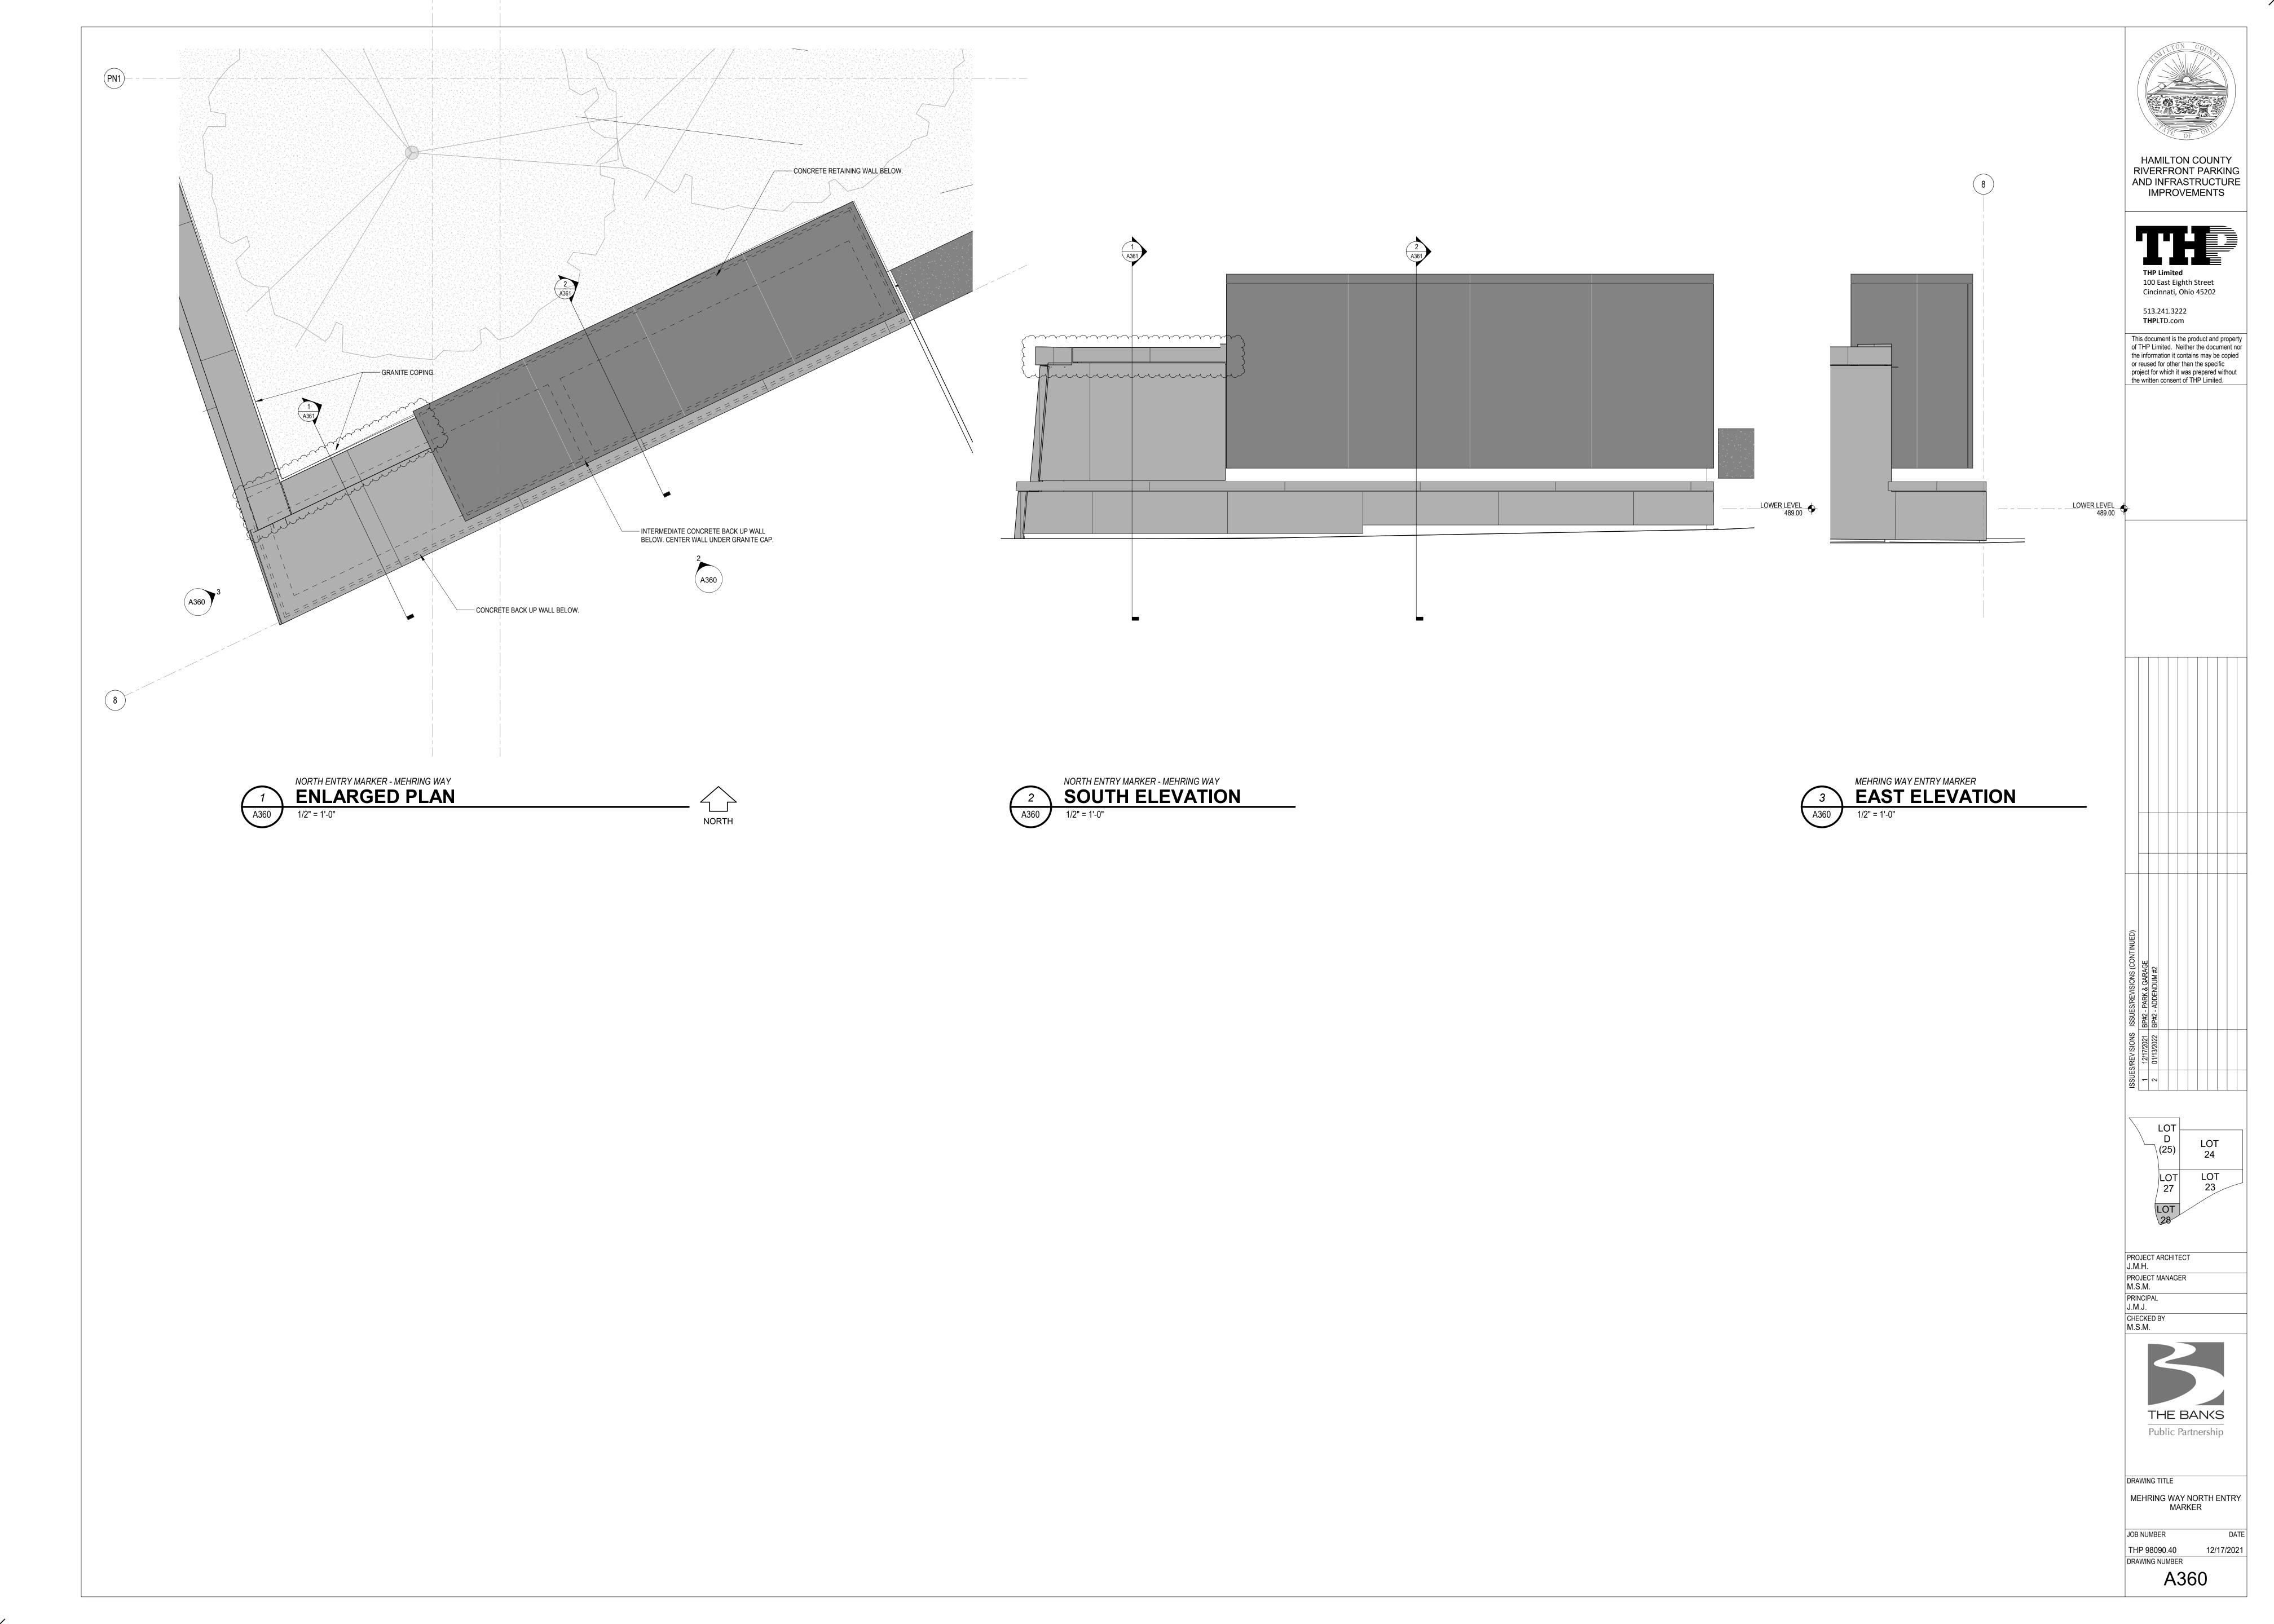

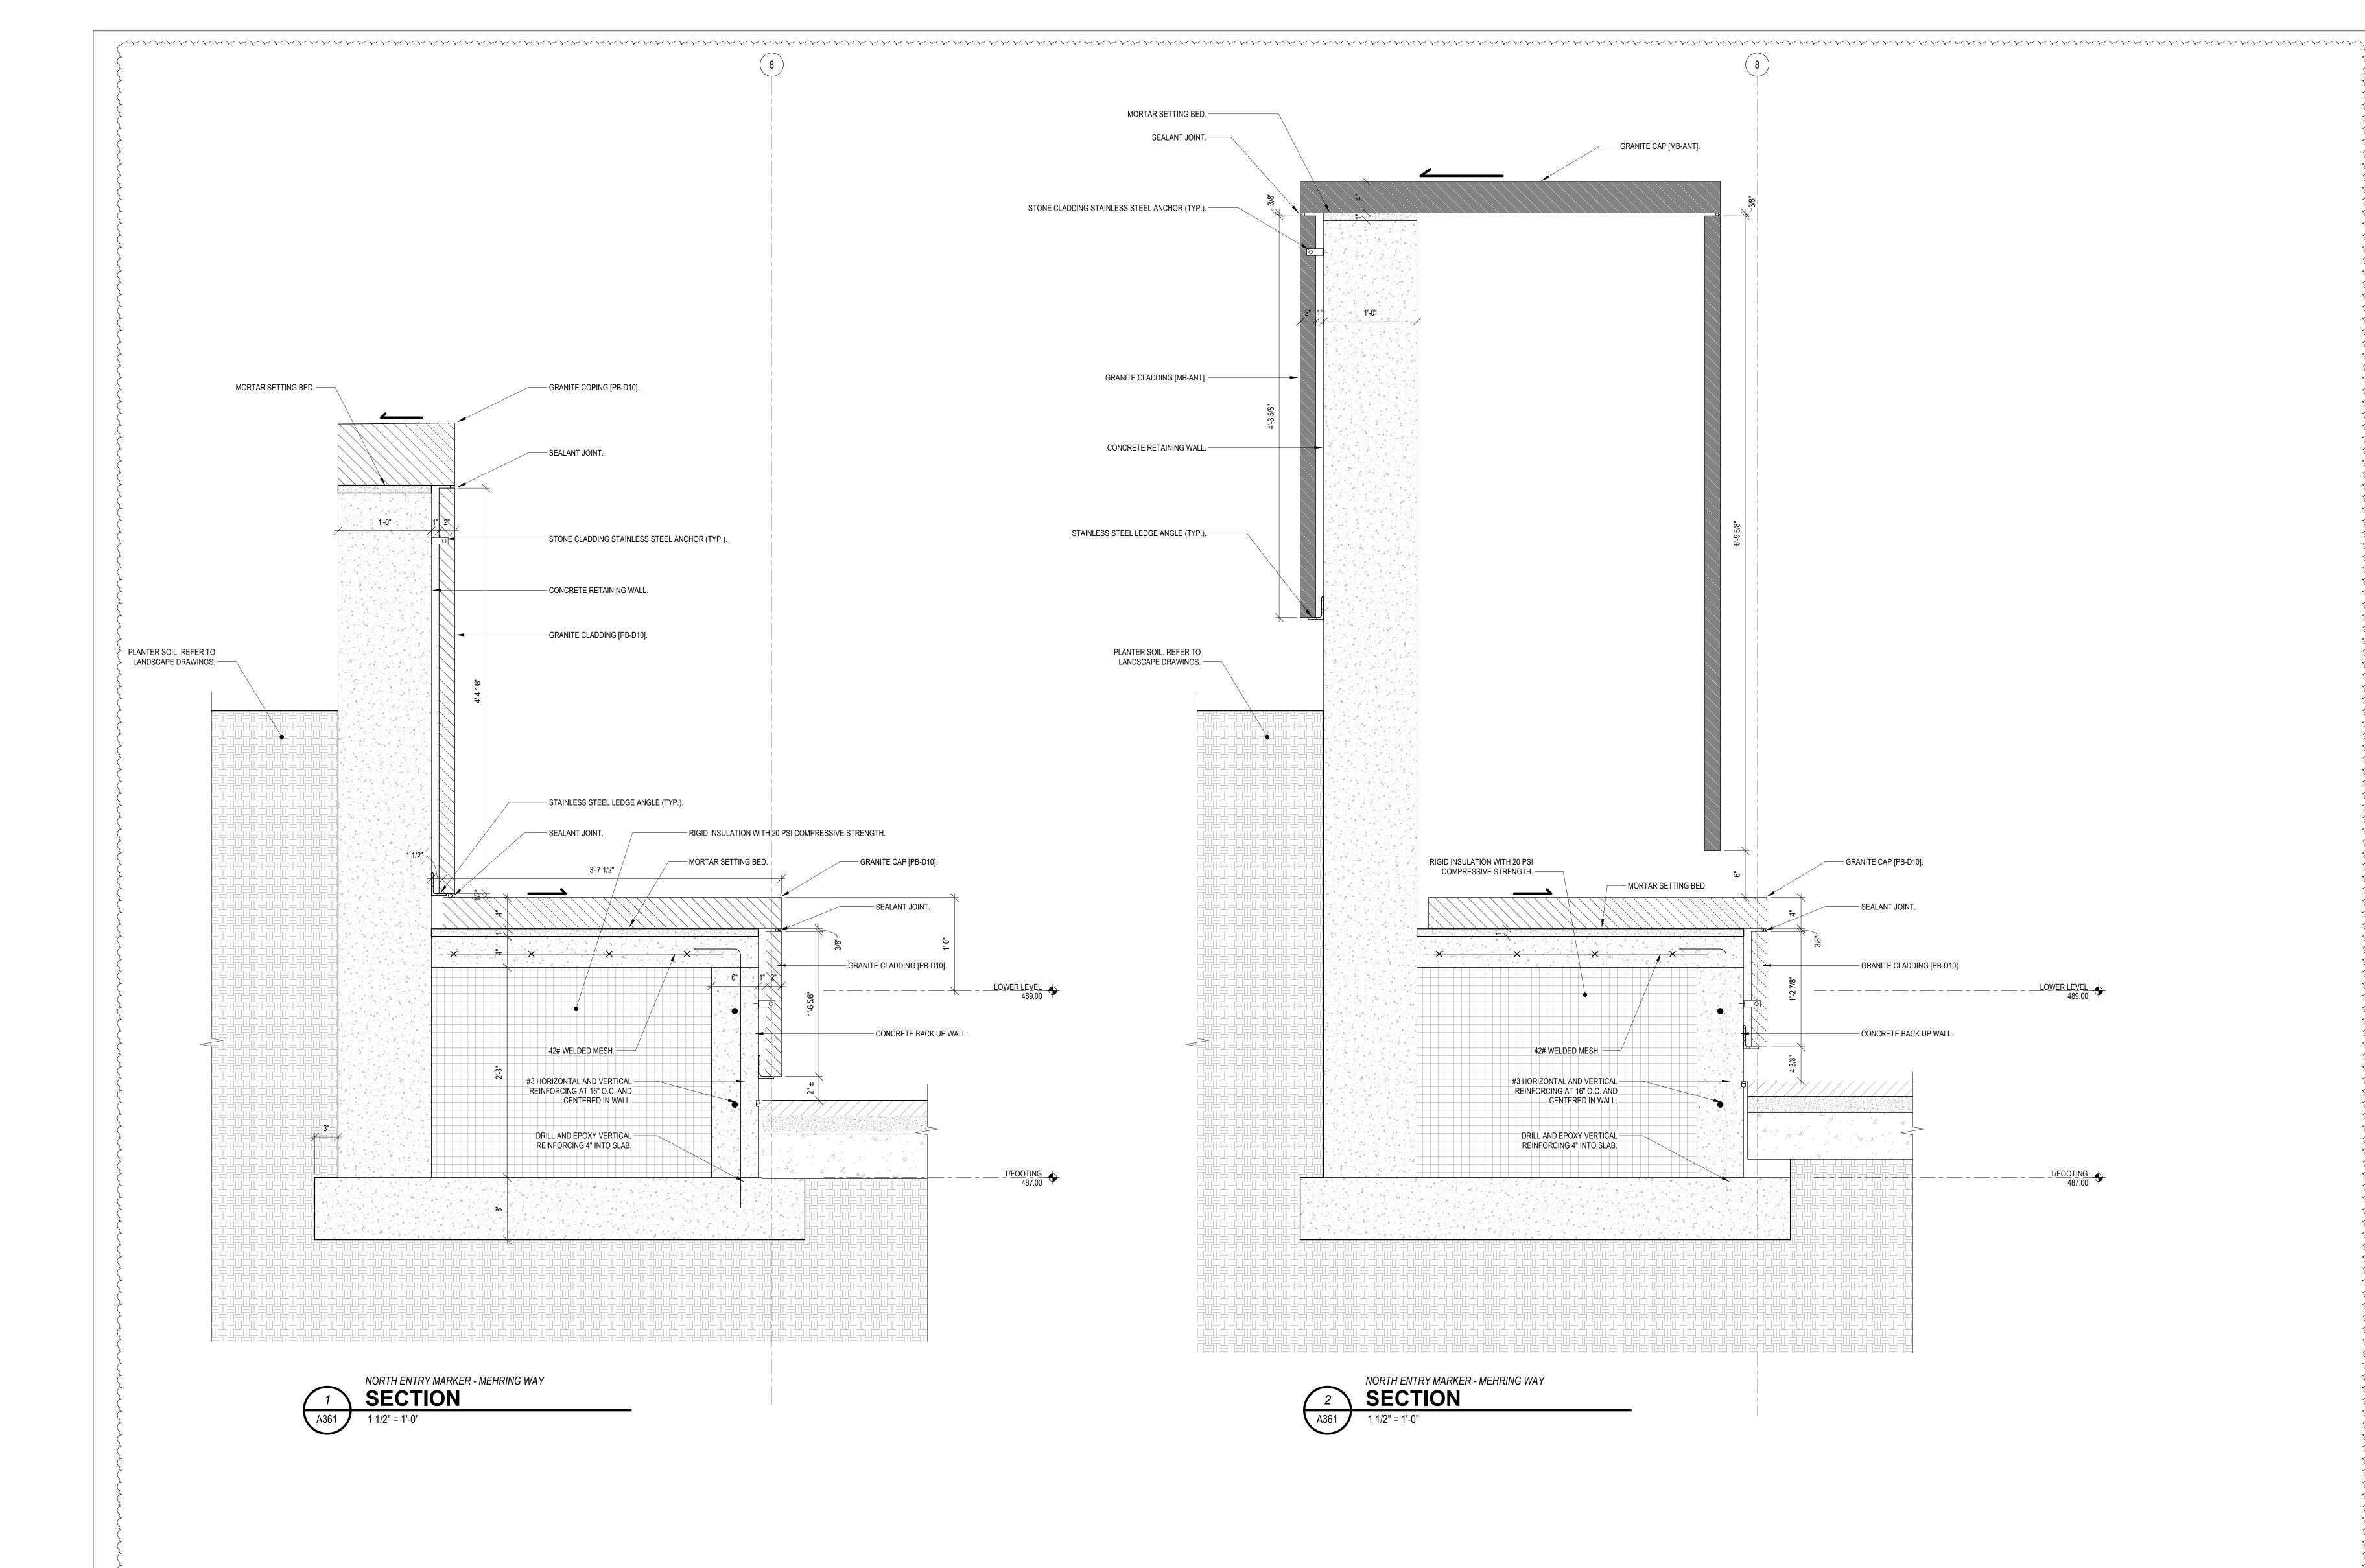GRANITE COLOR & FINISH LEGEND

COLORS: PB - PRAIRIE BROWN MB - MESABI BLACK


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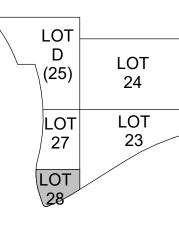


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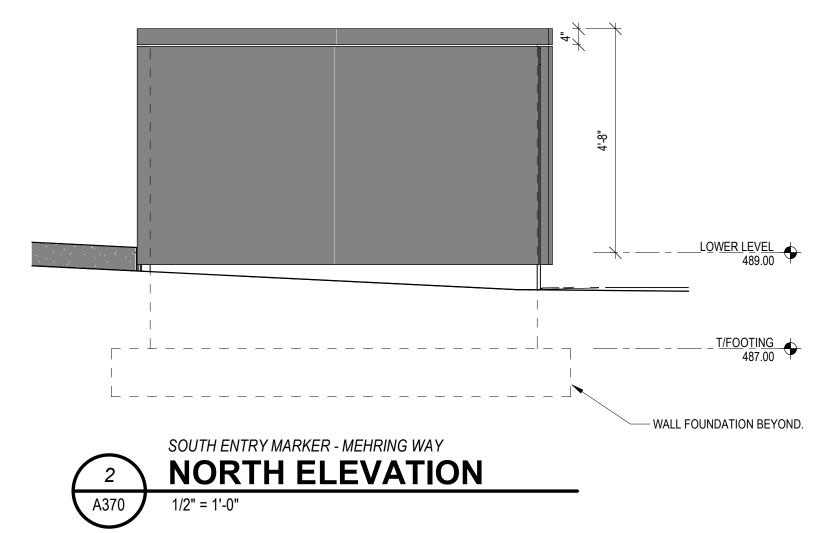
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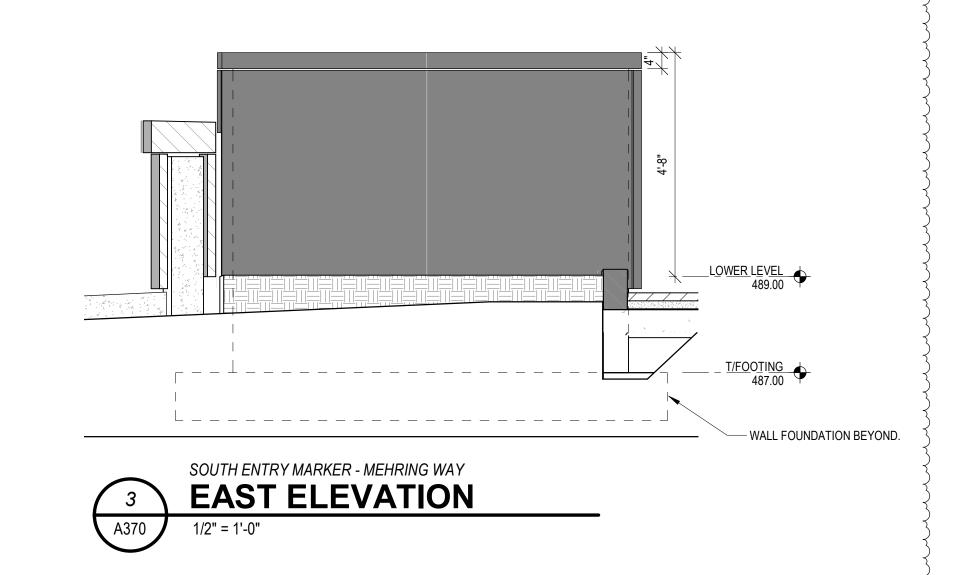
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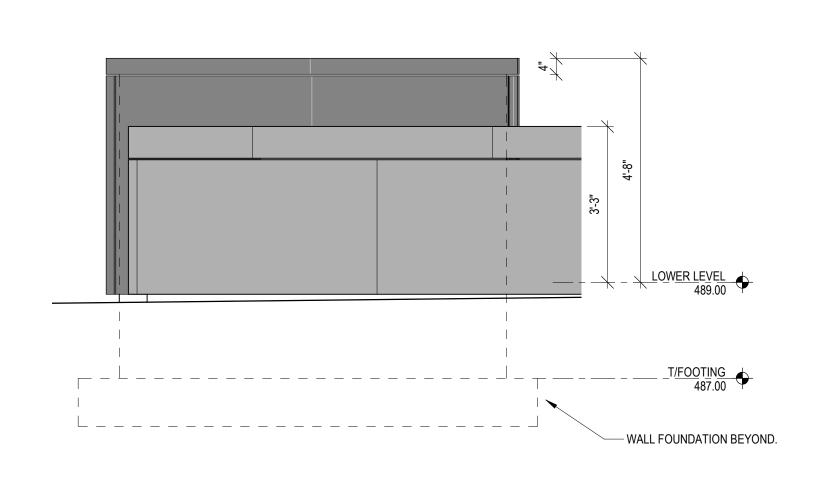
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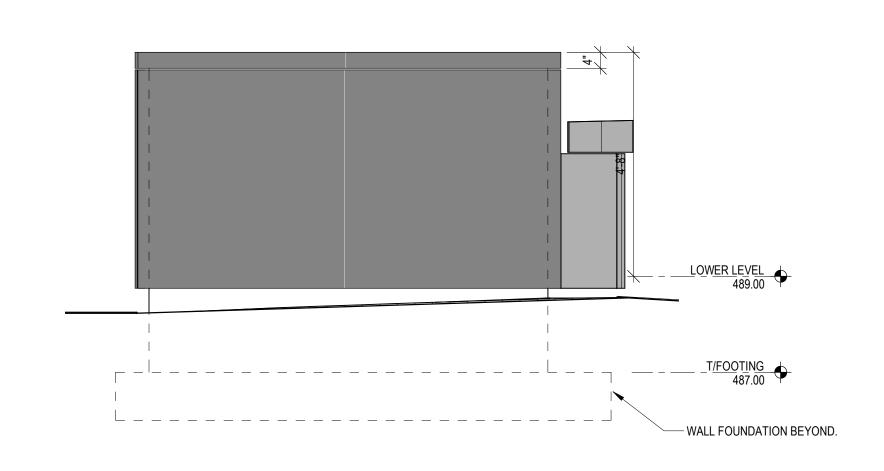
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THP 98090.40 12/17/202
DRAWING NUMBER








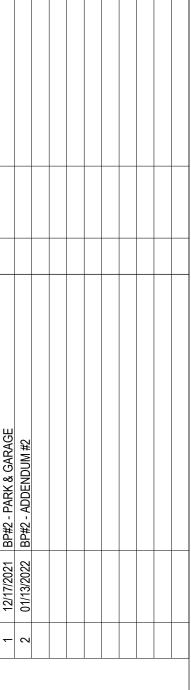








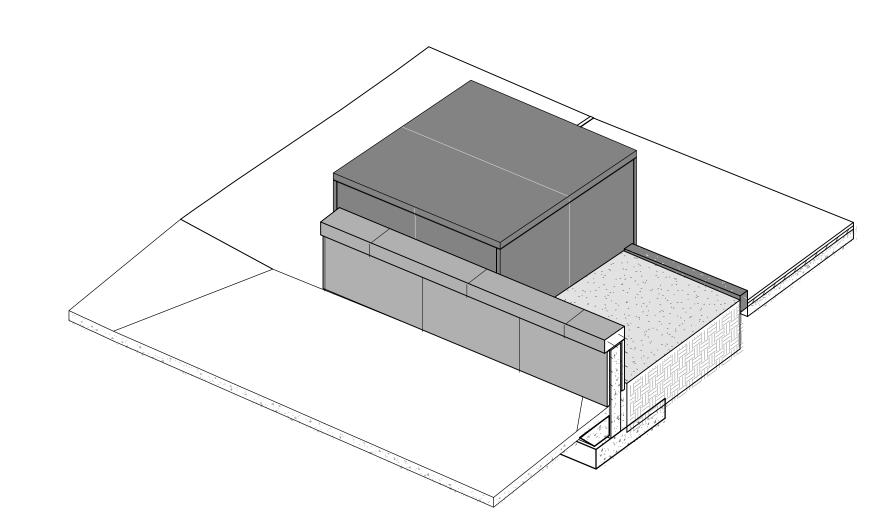



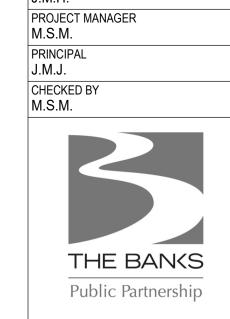

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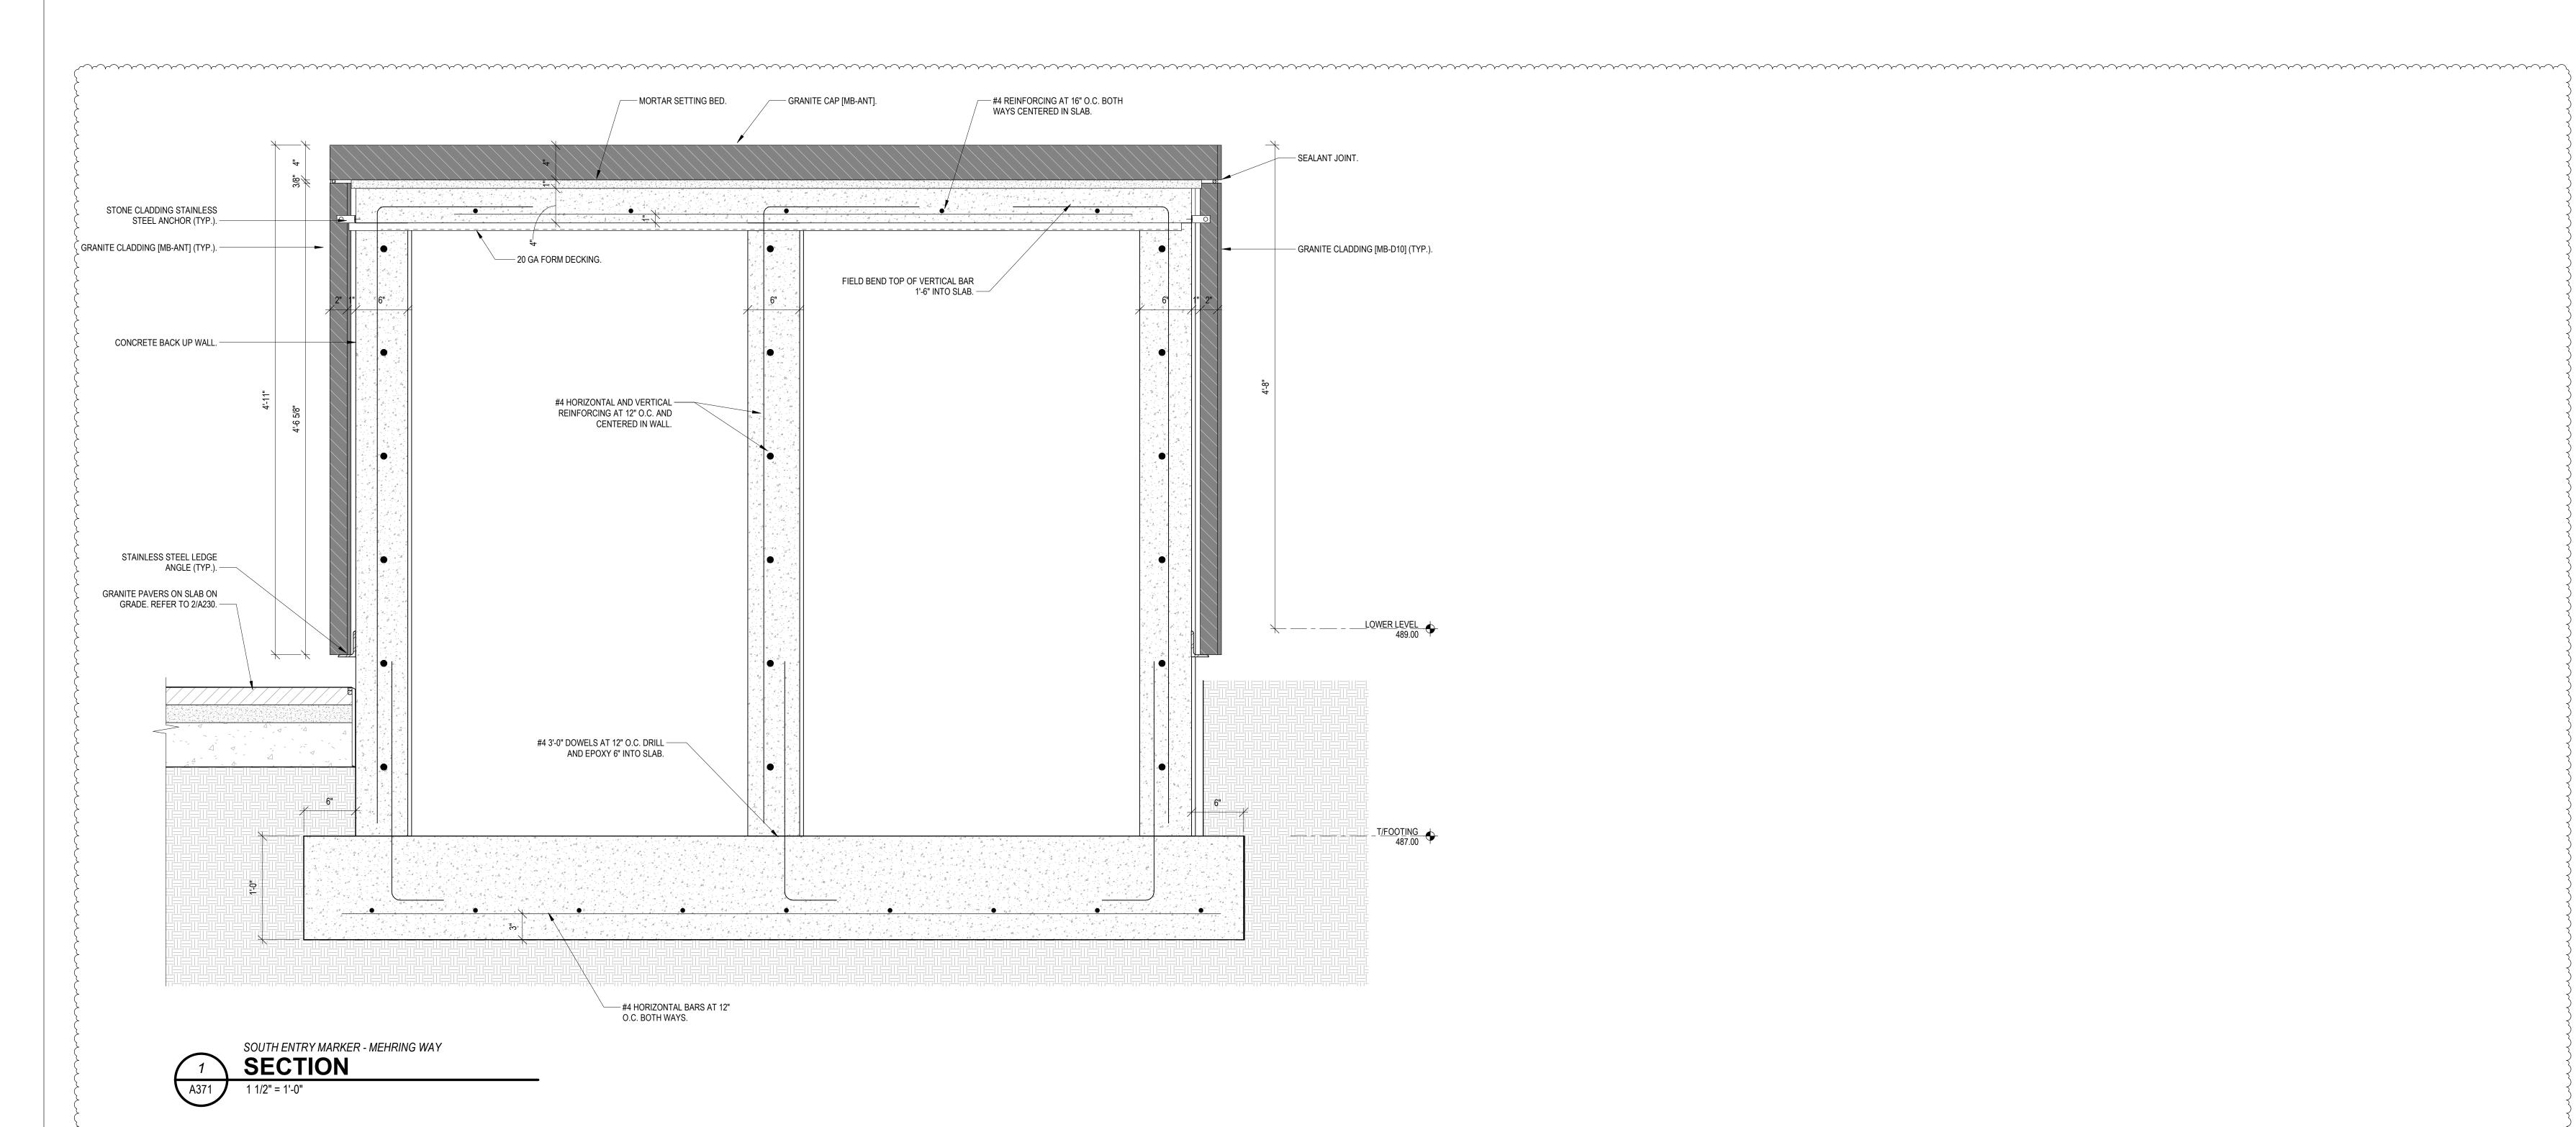
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DRAWING TITLE MEHRING WAY SOUTH ENTRY MARKER

JOB NUMBER THP 98090.40 DRAWING NUMBER



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FINISHES: D10 - DIAMOND 10 RF - ROCK FACE ANT - ANTIQUE







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PRINCIPAL
J.M.J.
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M.S.M.




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MEHRING WAY SOUTH ENTRY

MARKER E-W SECTION

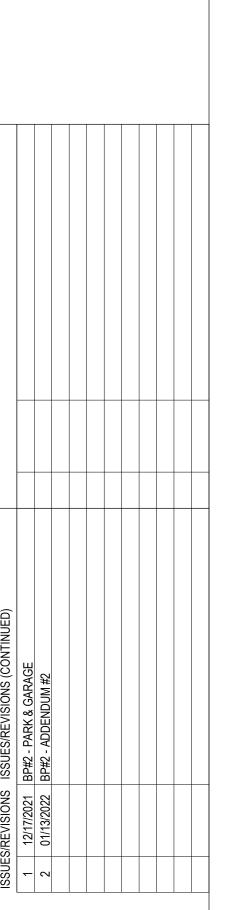JOB NUMBER DAT
THP 98090.40 12/17/2020
DRAWING NUMBER

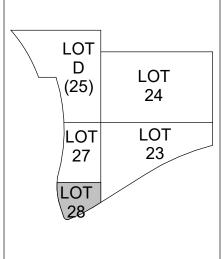A371



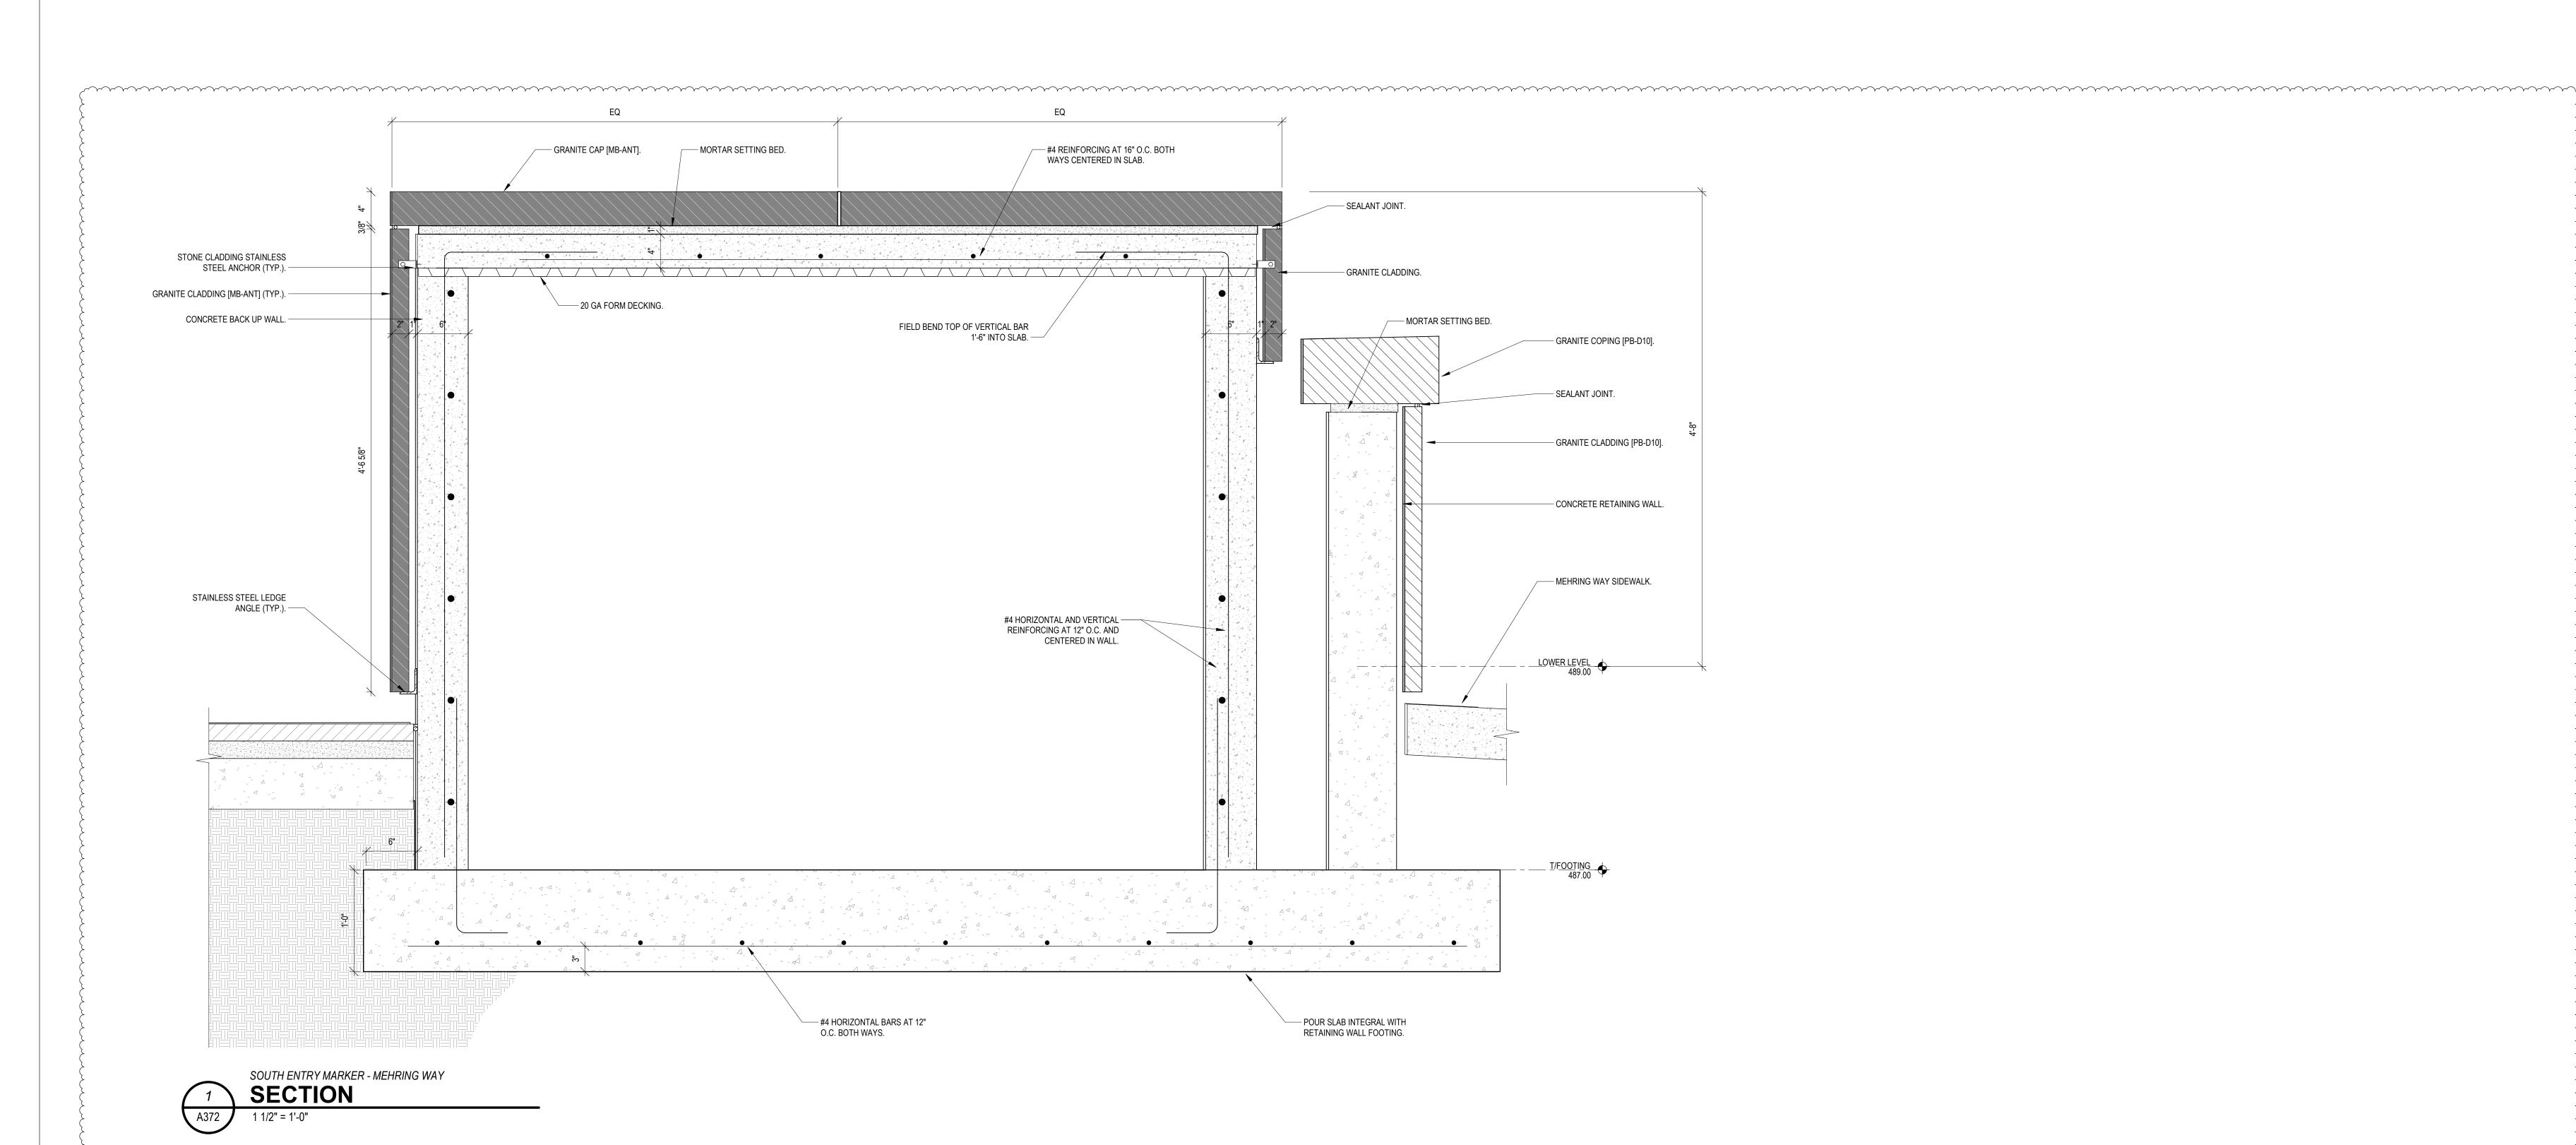

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M.S.M.
PRINCIPAL
J.M.J.
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DRAWING TITLE

MEHRING WAY SOUTH ENTRY

MARKER N-S SECTION


JOB NUMBER DAT
THP 98090.40 12/17/202
DRAWING NUMBER

A372

GRANITE COLOR & FINISH LEGEND

COLORS: PB - PRAIRIE BROWN MB - MESABI BLACK

FINISHES: D10 - DIAMOND 10 RF - ROCK FACE ANT - ANTIQUE

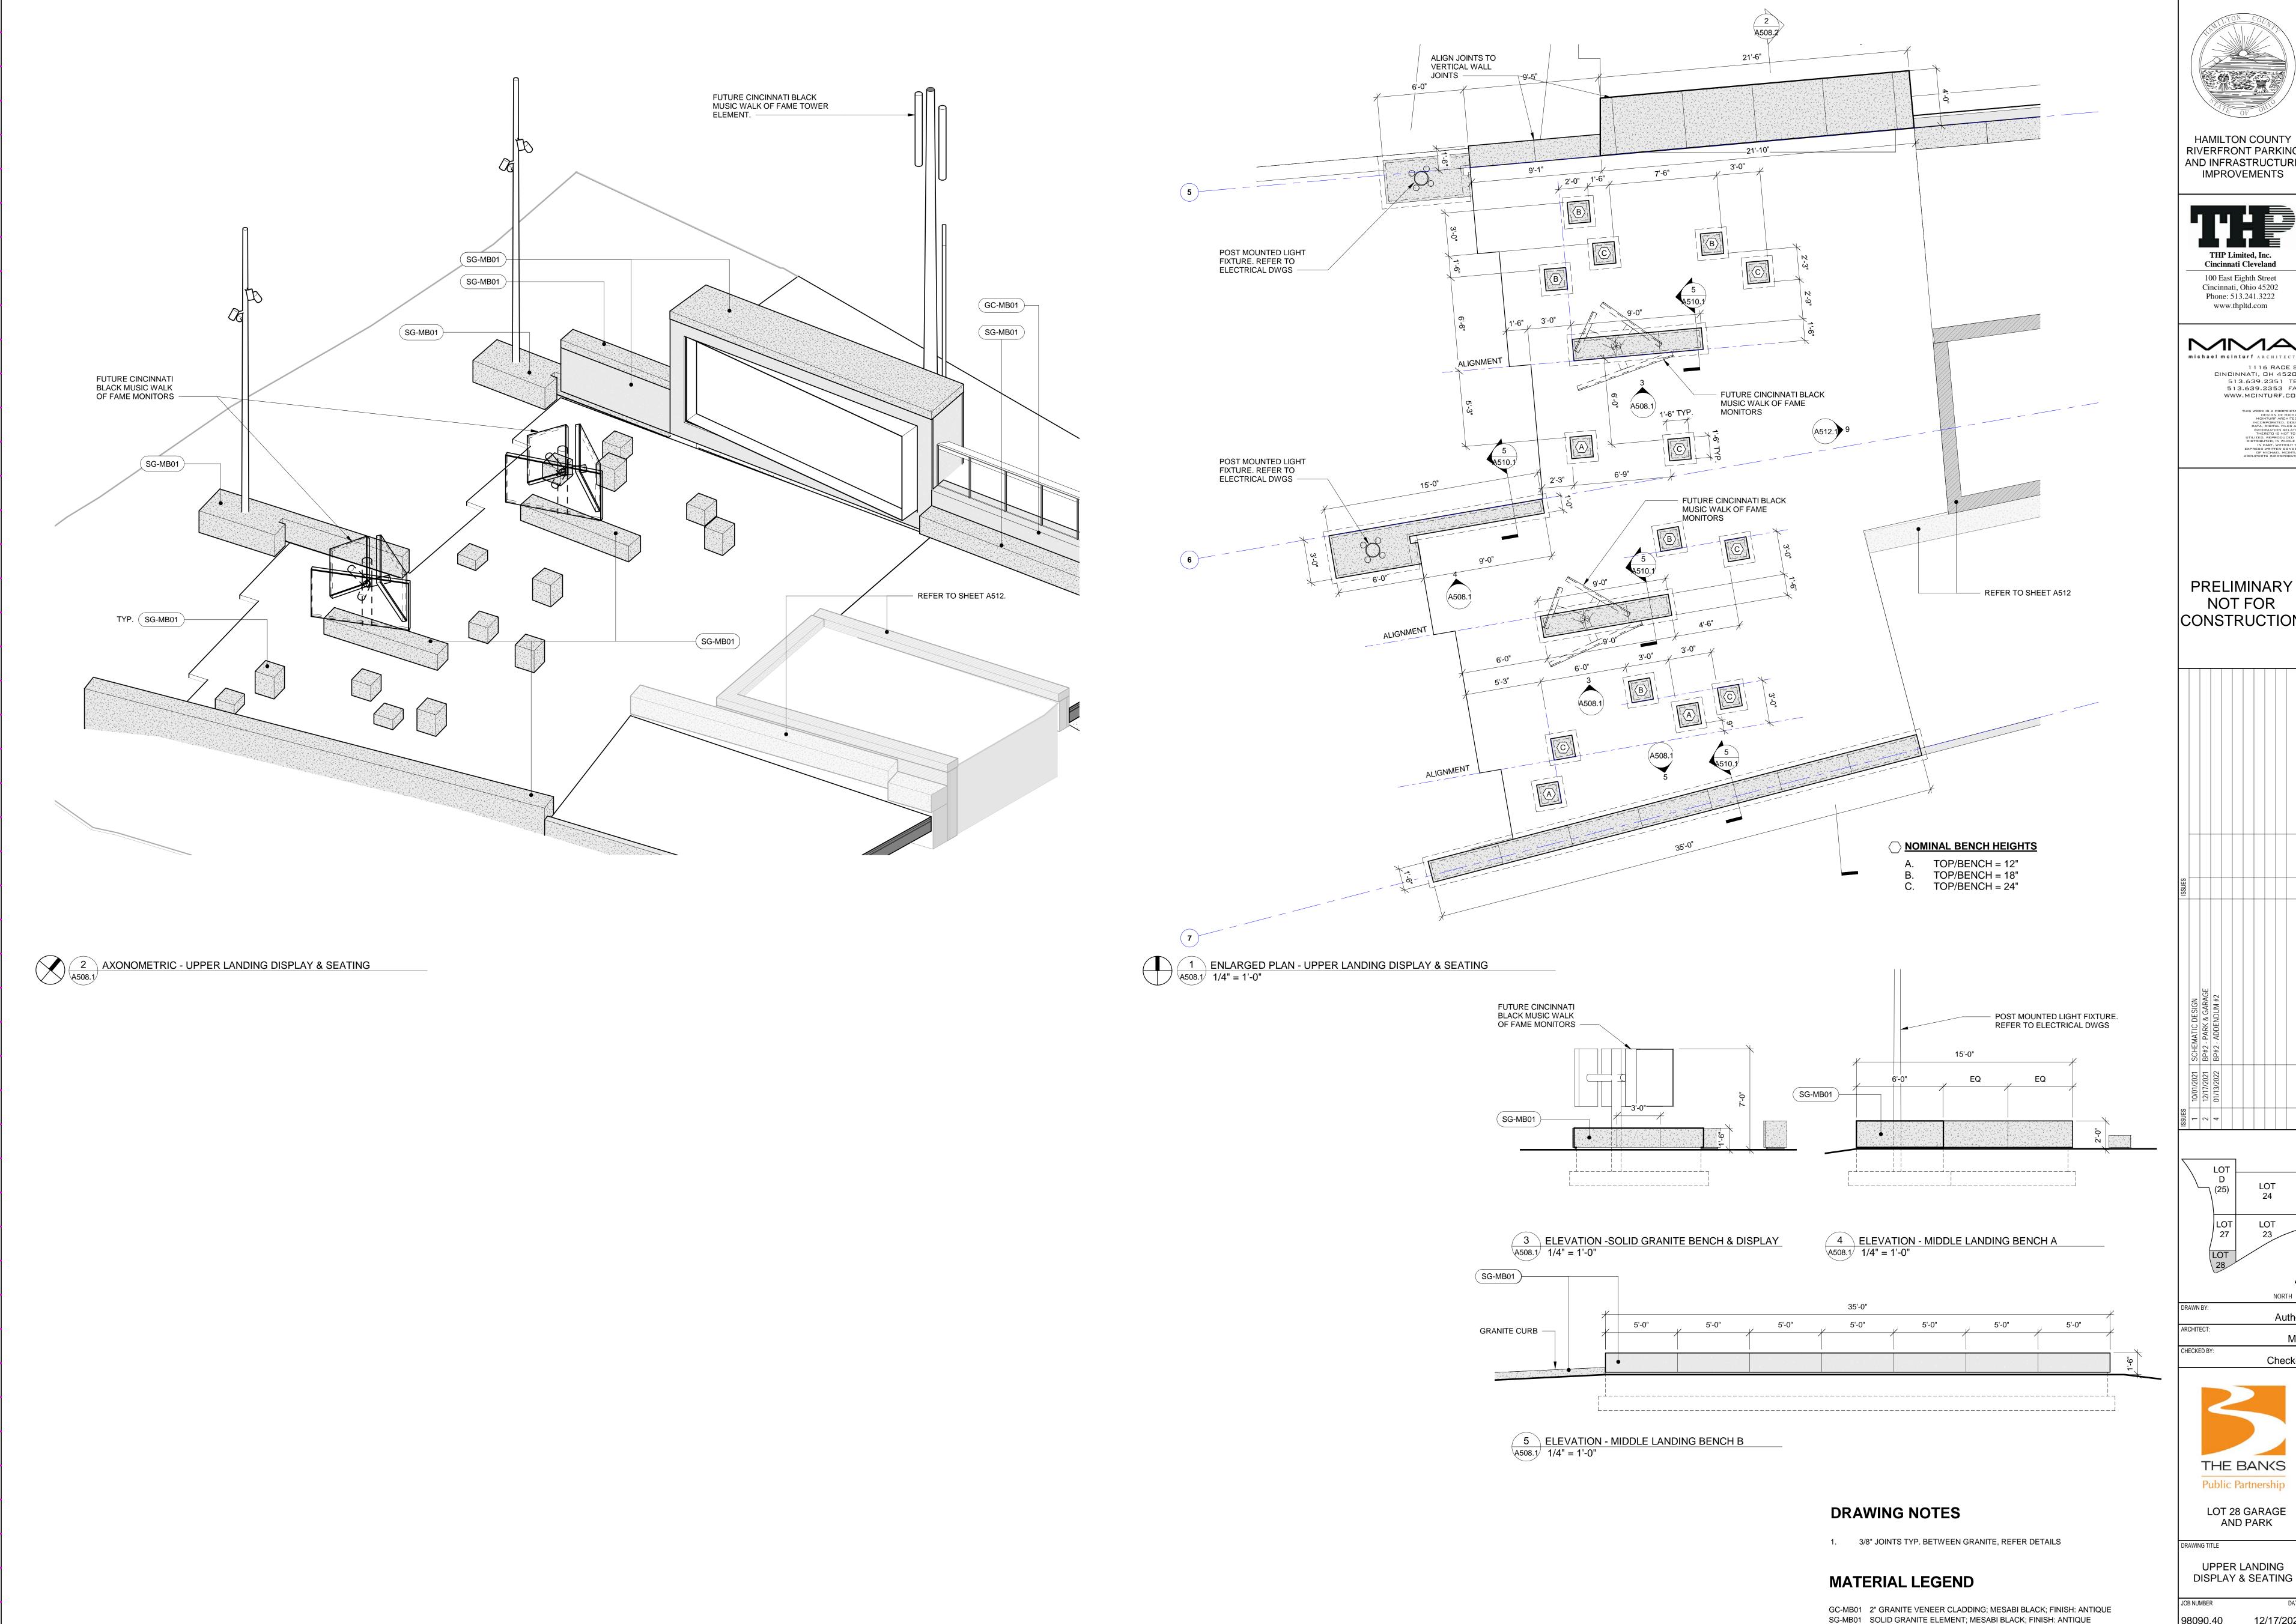




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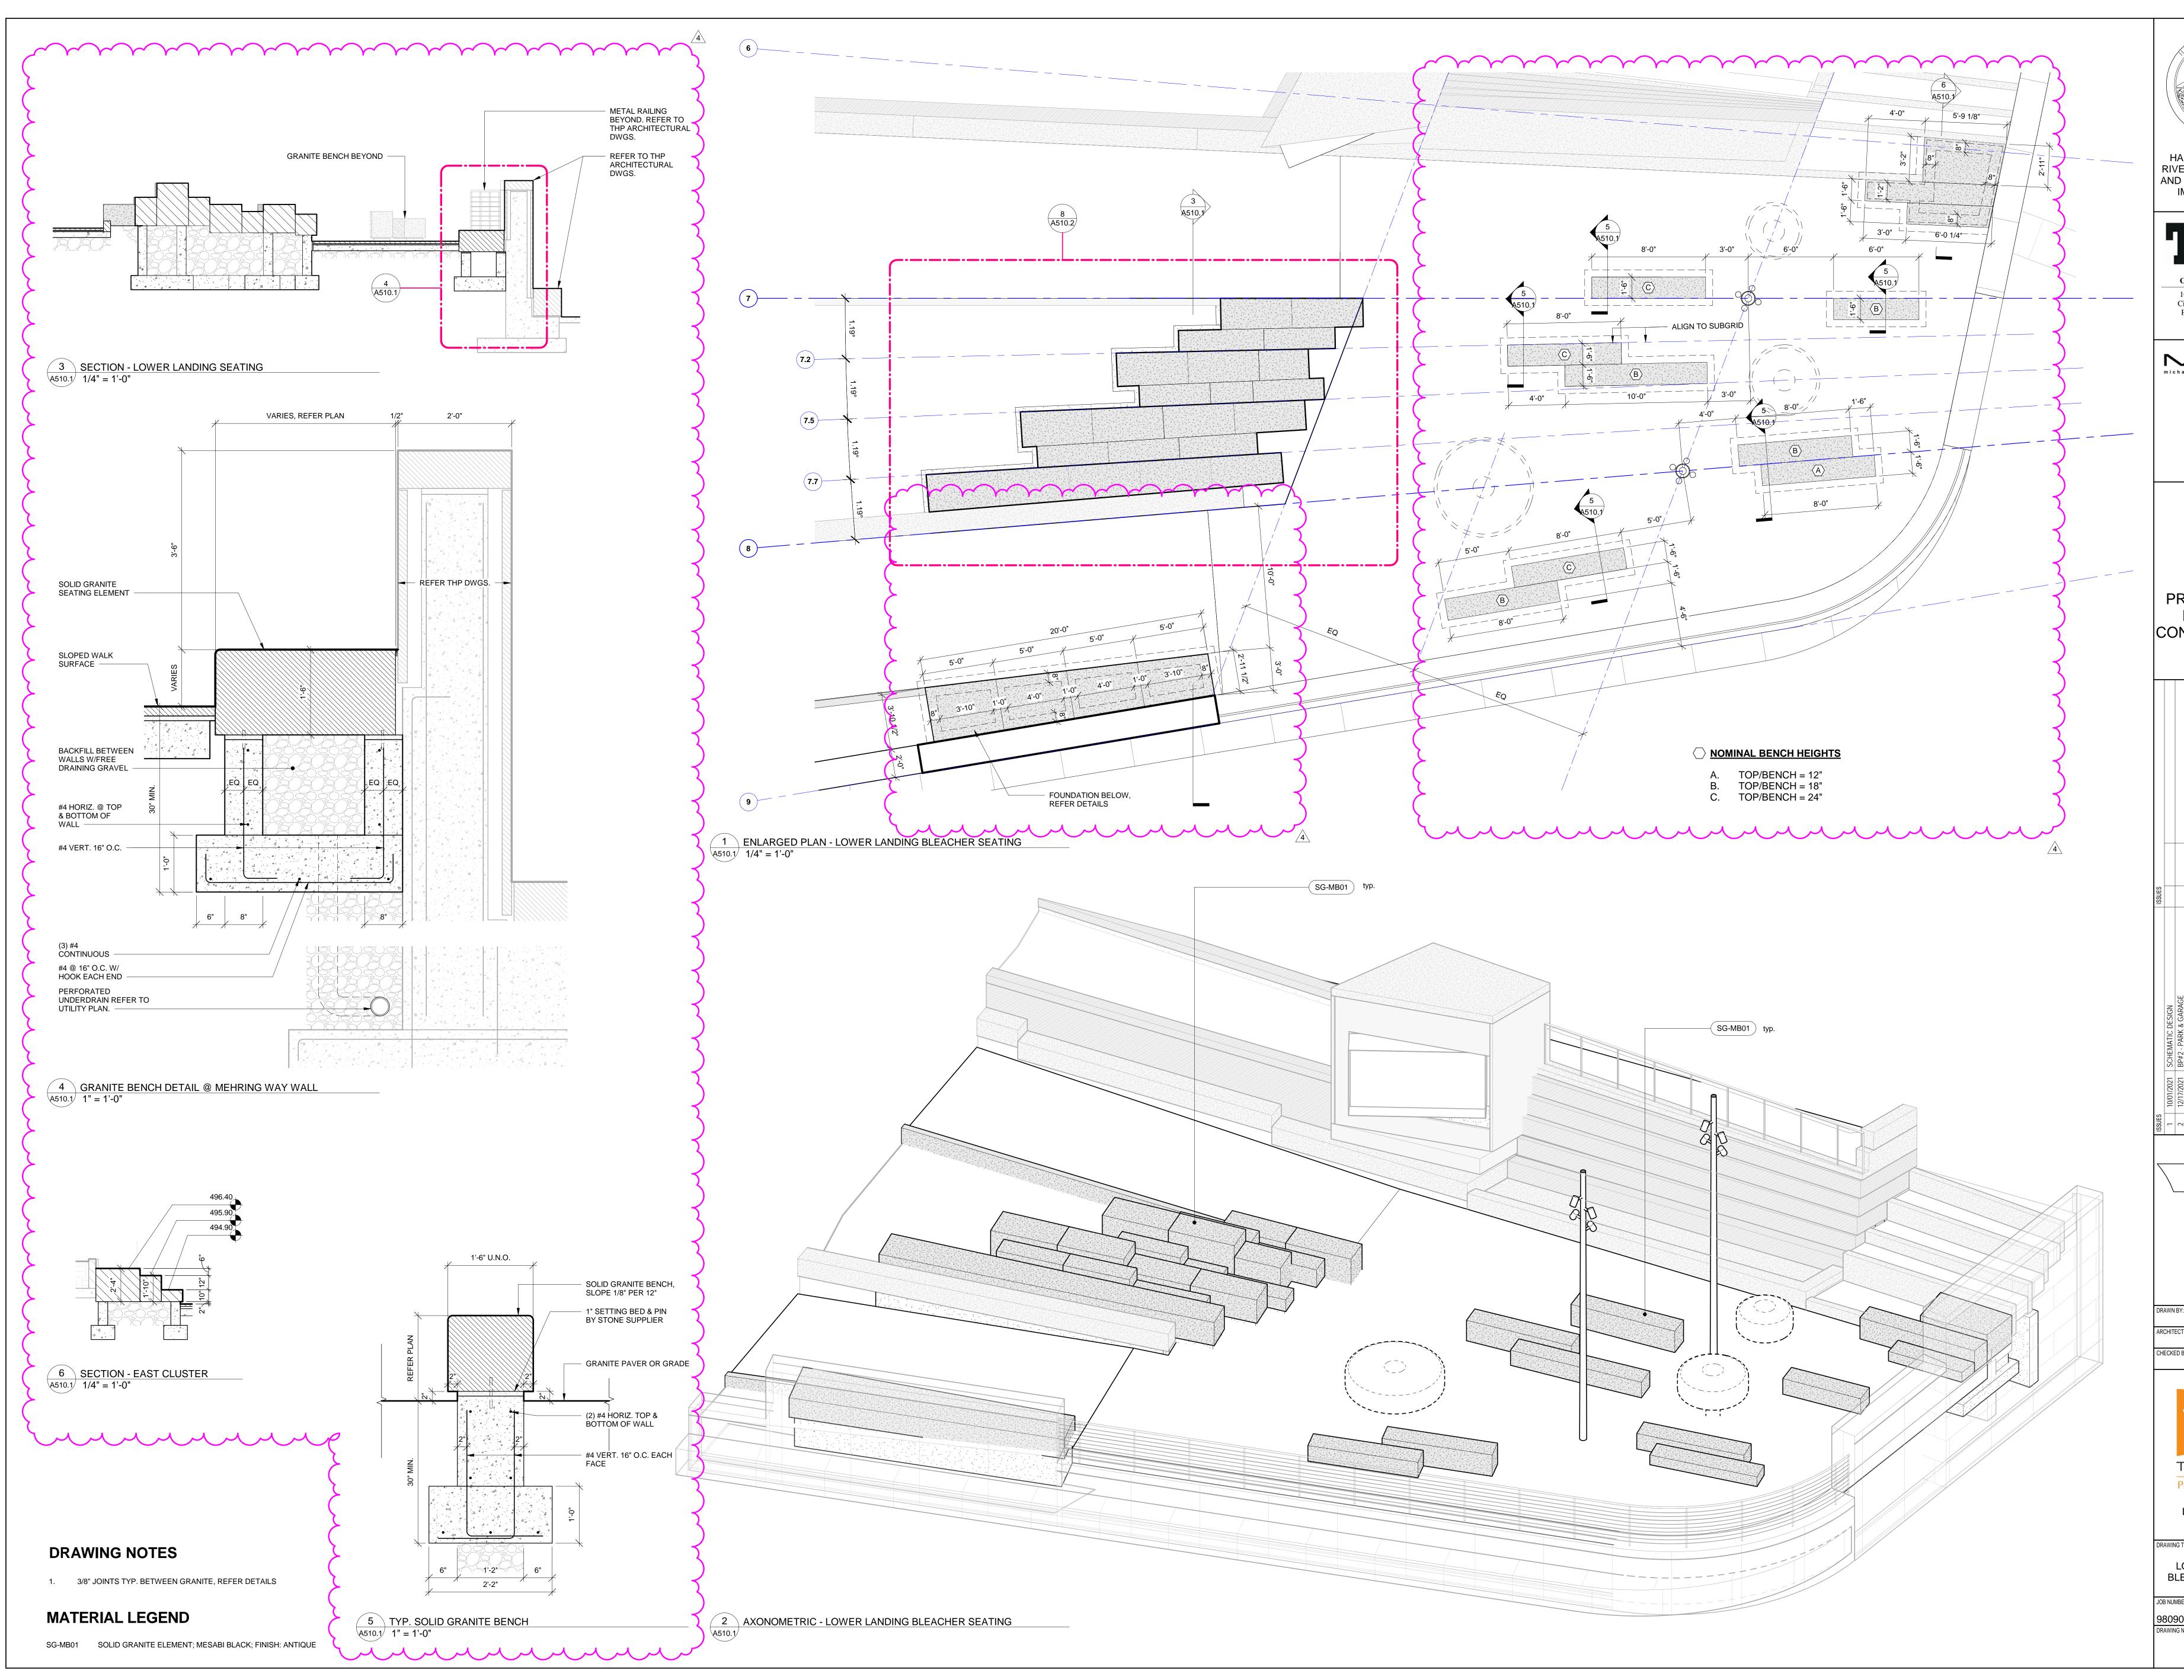
THE BANKS Public Partnership

LOT 28 GARAGE AND PARK

UPPER LANDING

98090.40 12/17/2021

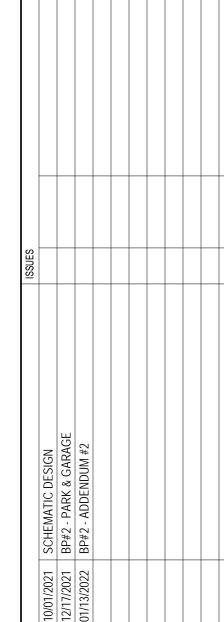A508.1



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HAMILTON COUNTY
RIVERFRONT PARKING
AND INFRASTRUCTURE
IMPROVEMENTS




michael mcinturf ARCHITECTS

1116 RACE ST
CINCINNATI, DH 452D2
513.639.2351 TEL
513.639.2353 FAX
WWW.MCINTURF.COM

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LOT D LOT 24

LOT 27 23

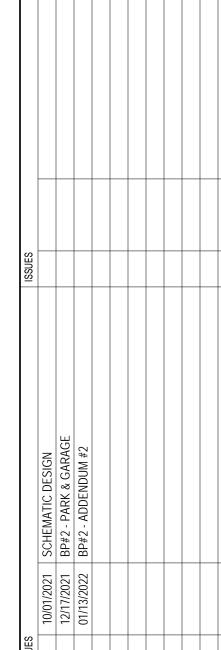LOT 28

NBY:
Author
TECT:
MM
TED BY:
Checker

THE BANKS
Public Partnership

LOT 28 GARAGE AND PARK


LOWER LANDING BLEACHER SEATING

JOB NUMBER DATE

98090.40 12/17/2021

DRAWING NUMBER

A510.1

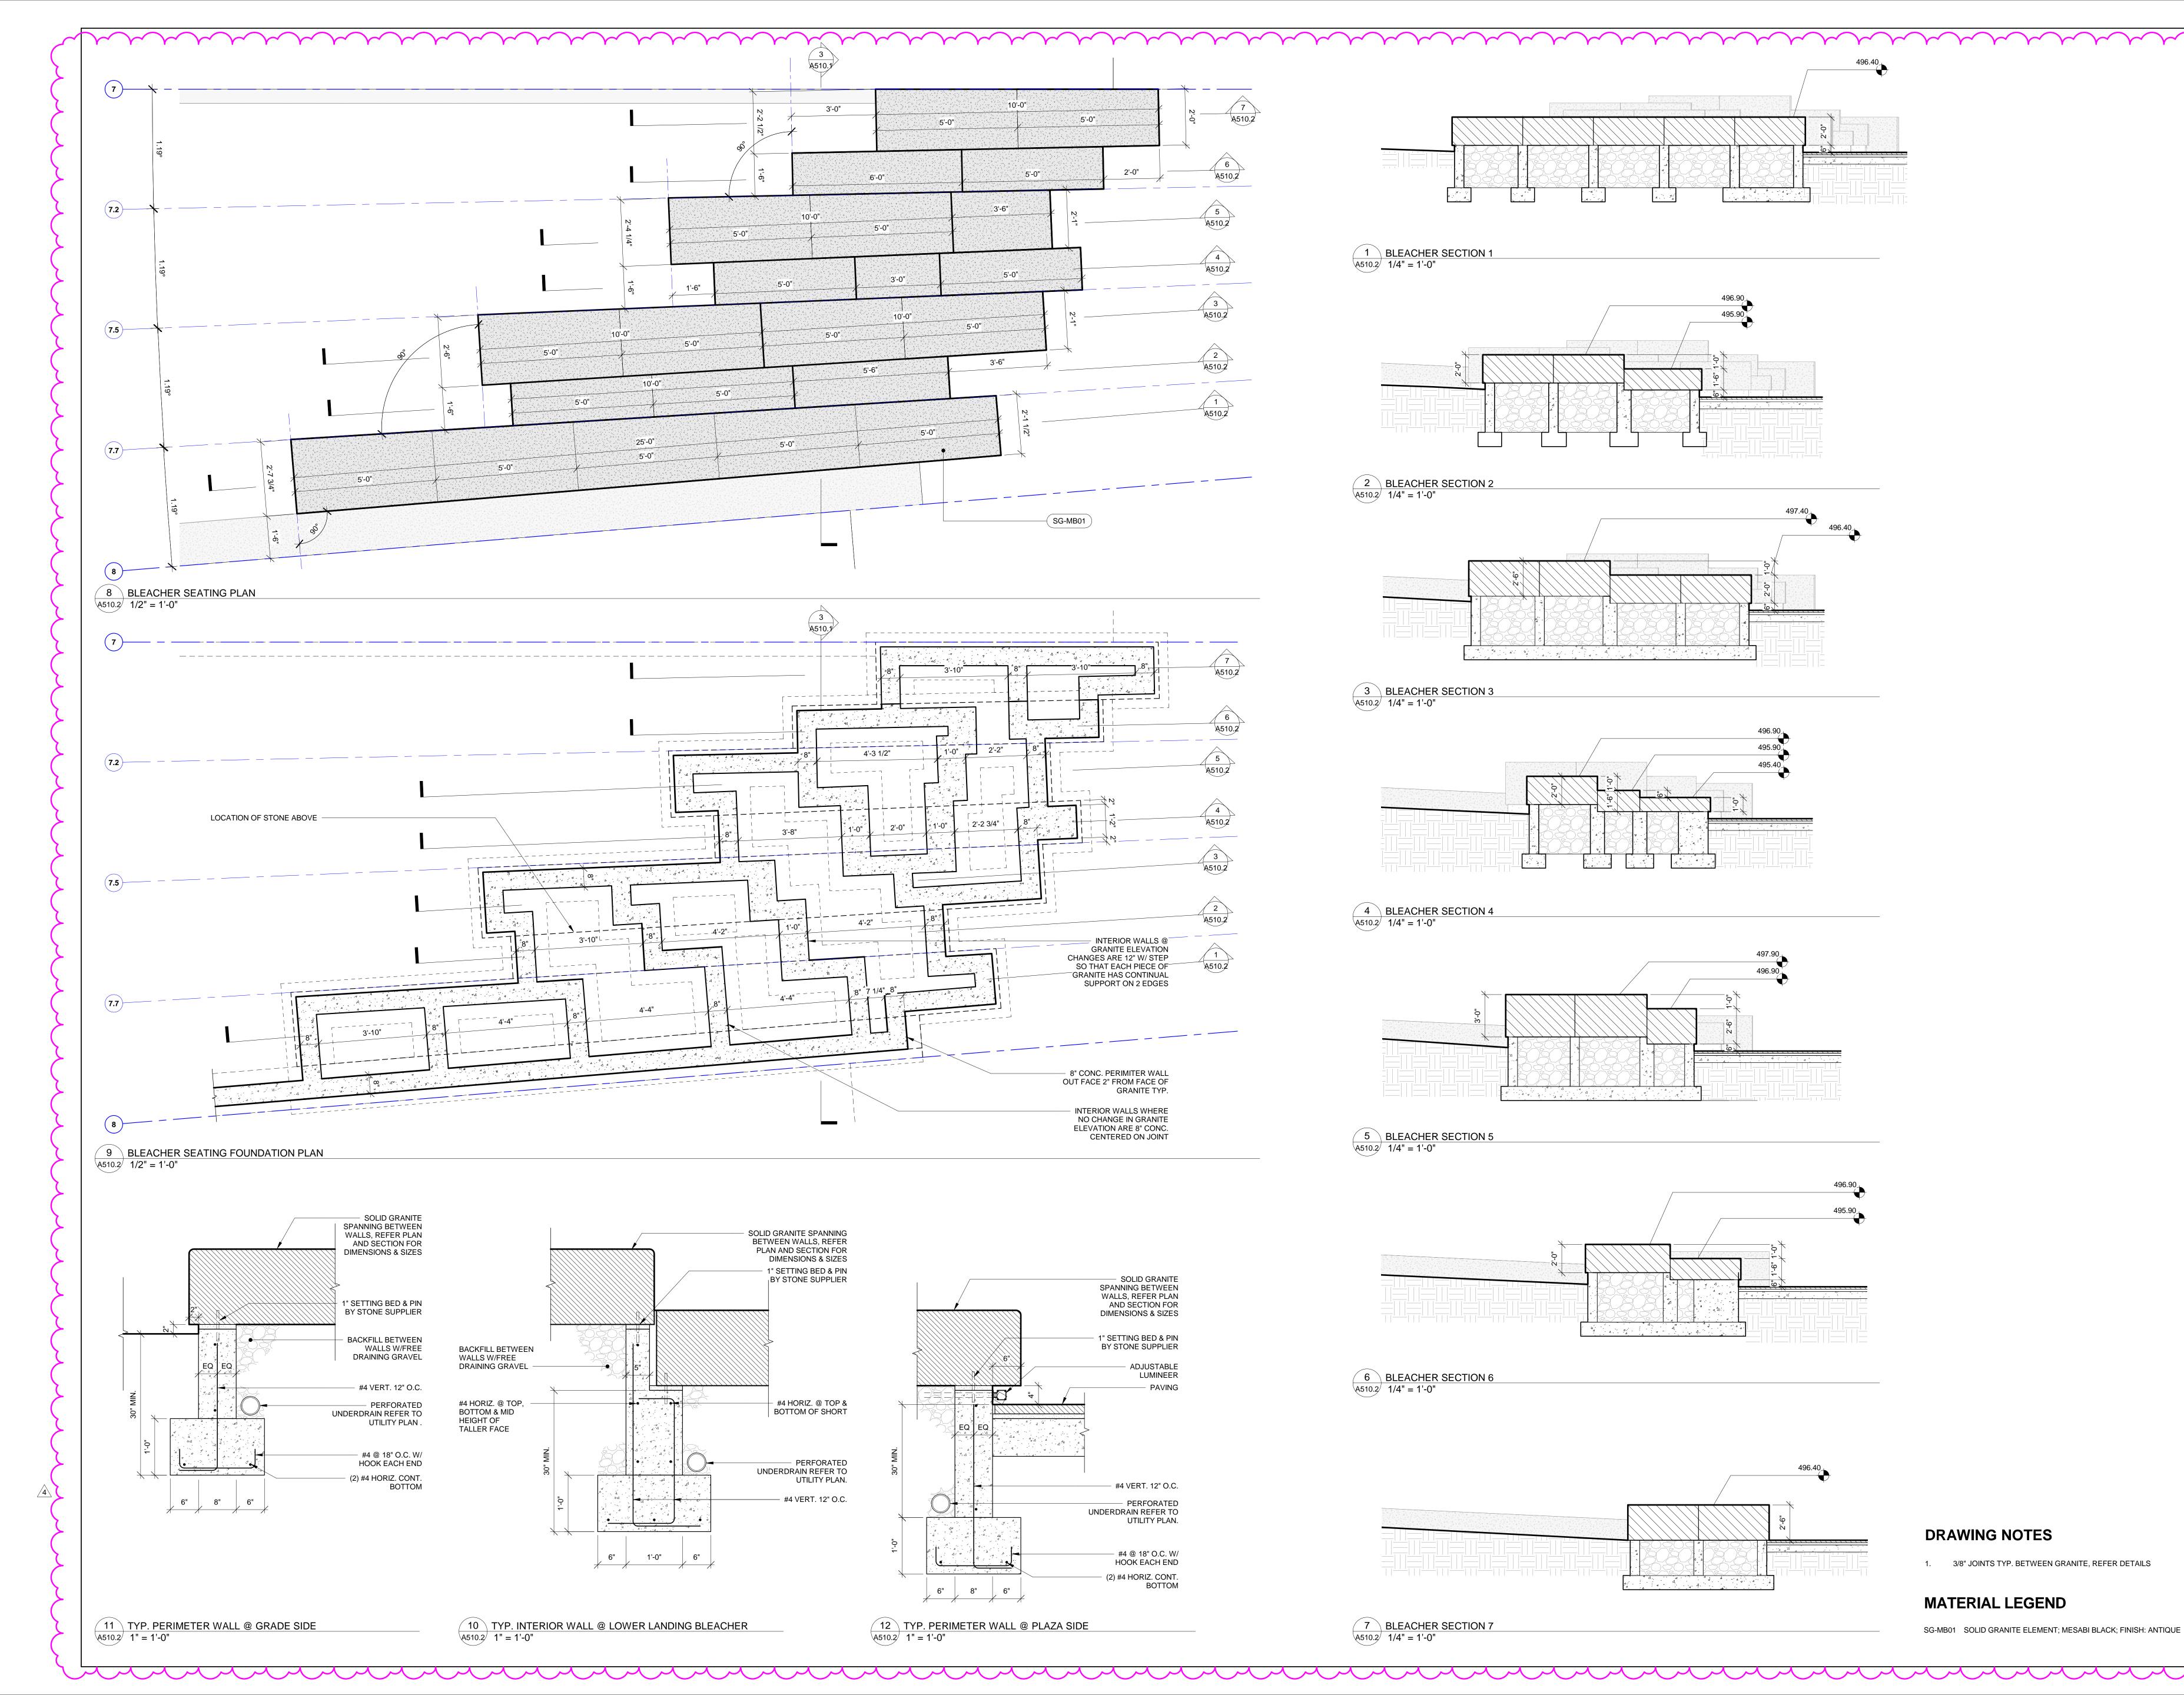





michael mcinturf Architects

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CINCINNATI, DH 45202
513.639.2351 TEL

1116 RACE ST
CINCINNATI, DH 45202
513.639.2351 TEL
513.639.2353 FAX
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ISSUES

1 10/01/2021 SCHEMATIC DESIGN
2 12/17/2021 BP#2 - PARK & GARAGE
4 01/13/2022 BP#2 - ADDENDUM #2

LOT D LOT 24

LOT 27 23

LOT 28

NORTH

NORTH

PRAWN BY:

Author

ARCHITECT:

MM

CHECKED BY:

Checker

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Public Partnership

LOT 28 GARAGE

AND PARK

VING TITLE

LOWER LANDING


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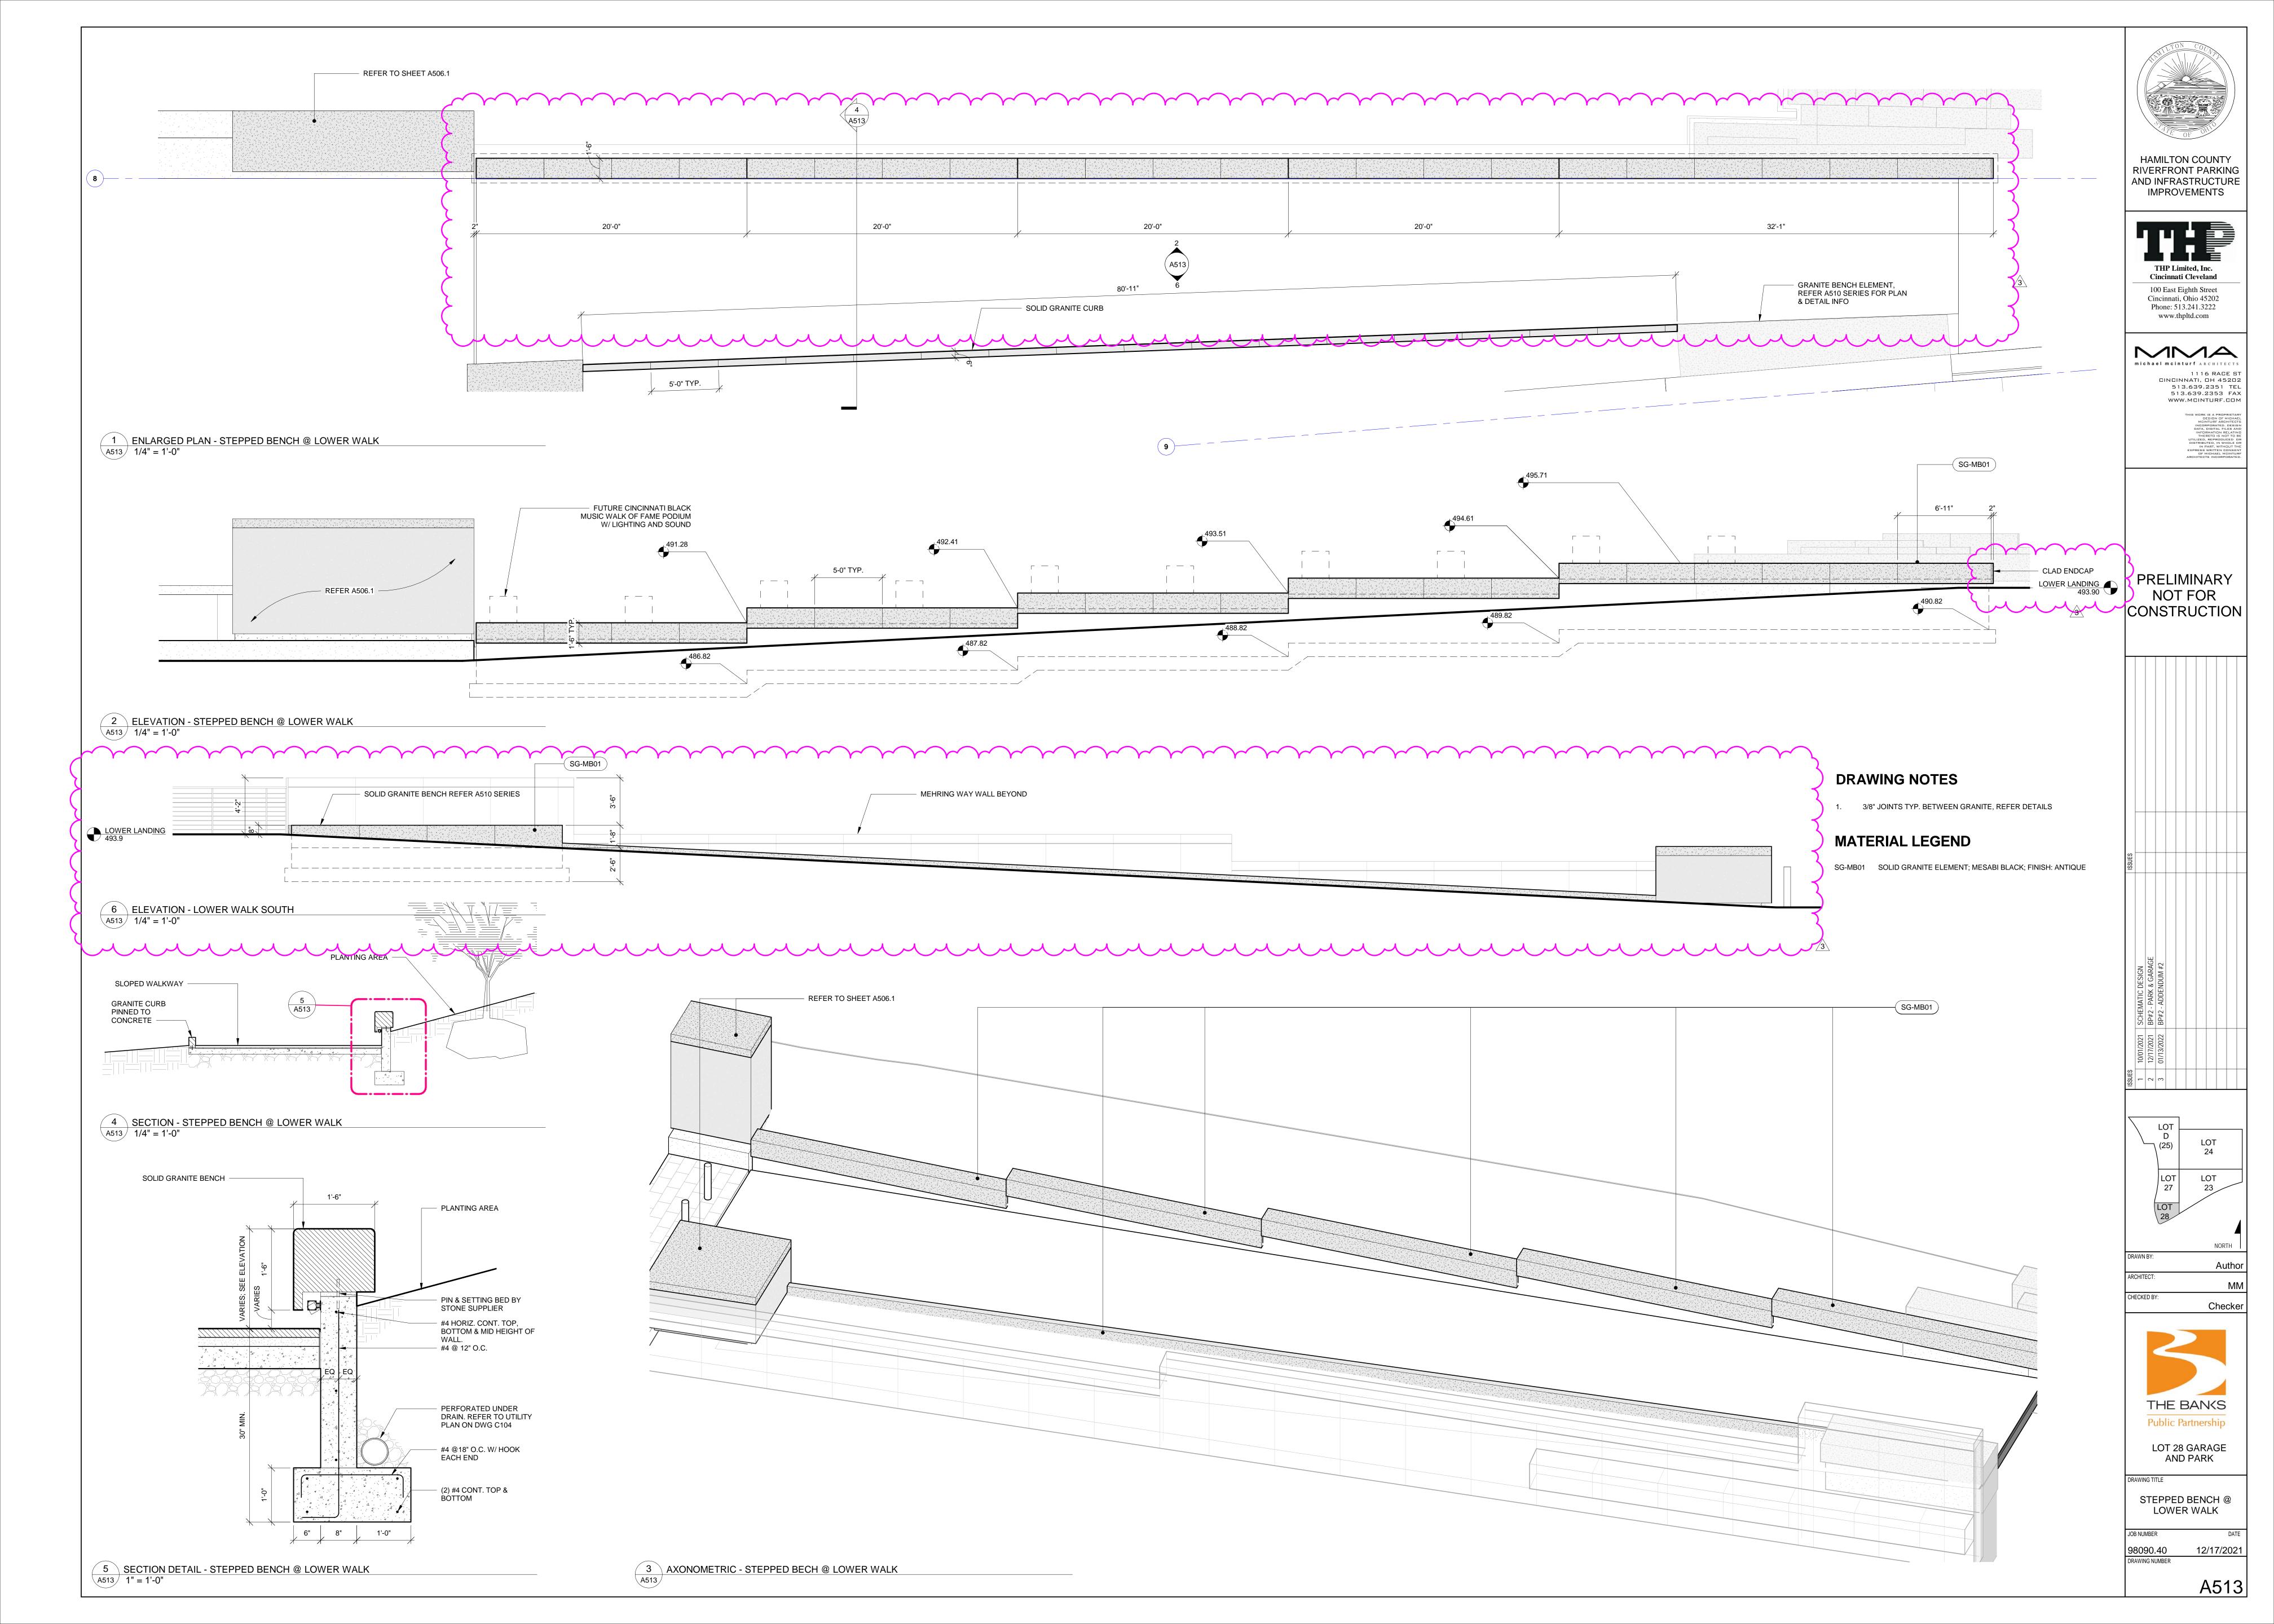
 JOB NUMBER
 DATE

 98090.40
 12/17/2021

 DRAWING NUMBER

A510.2



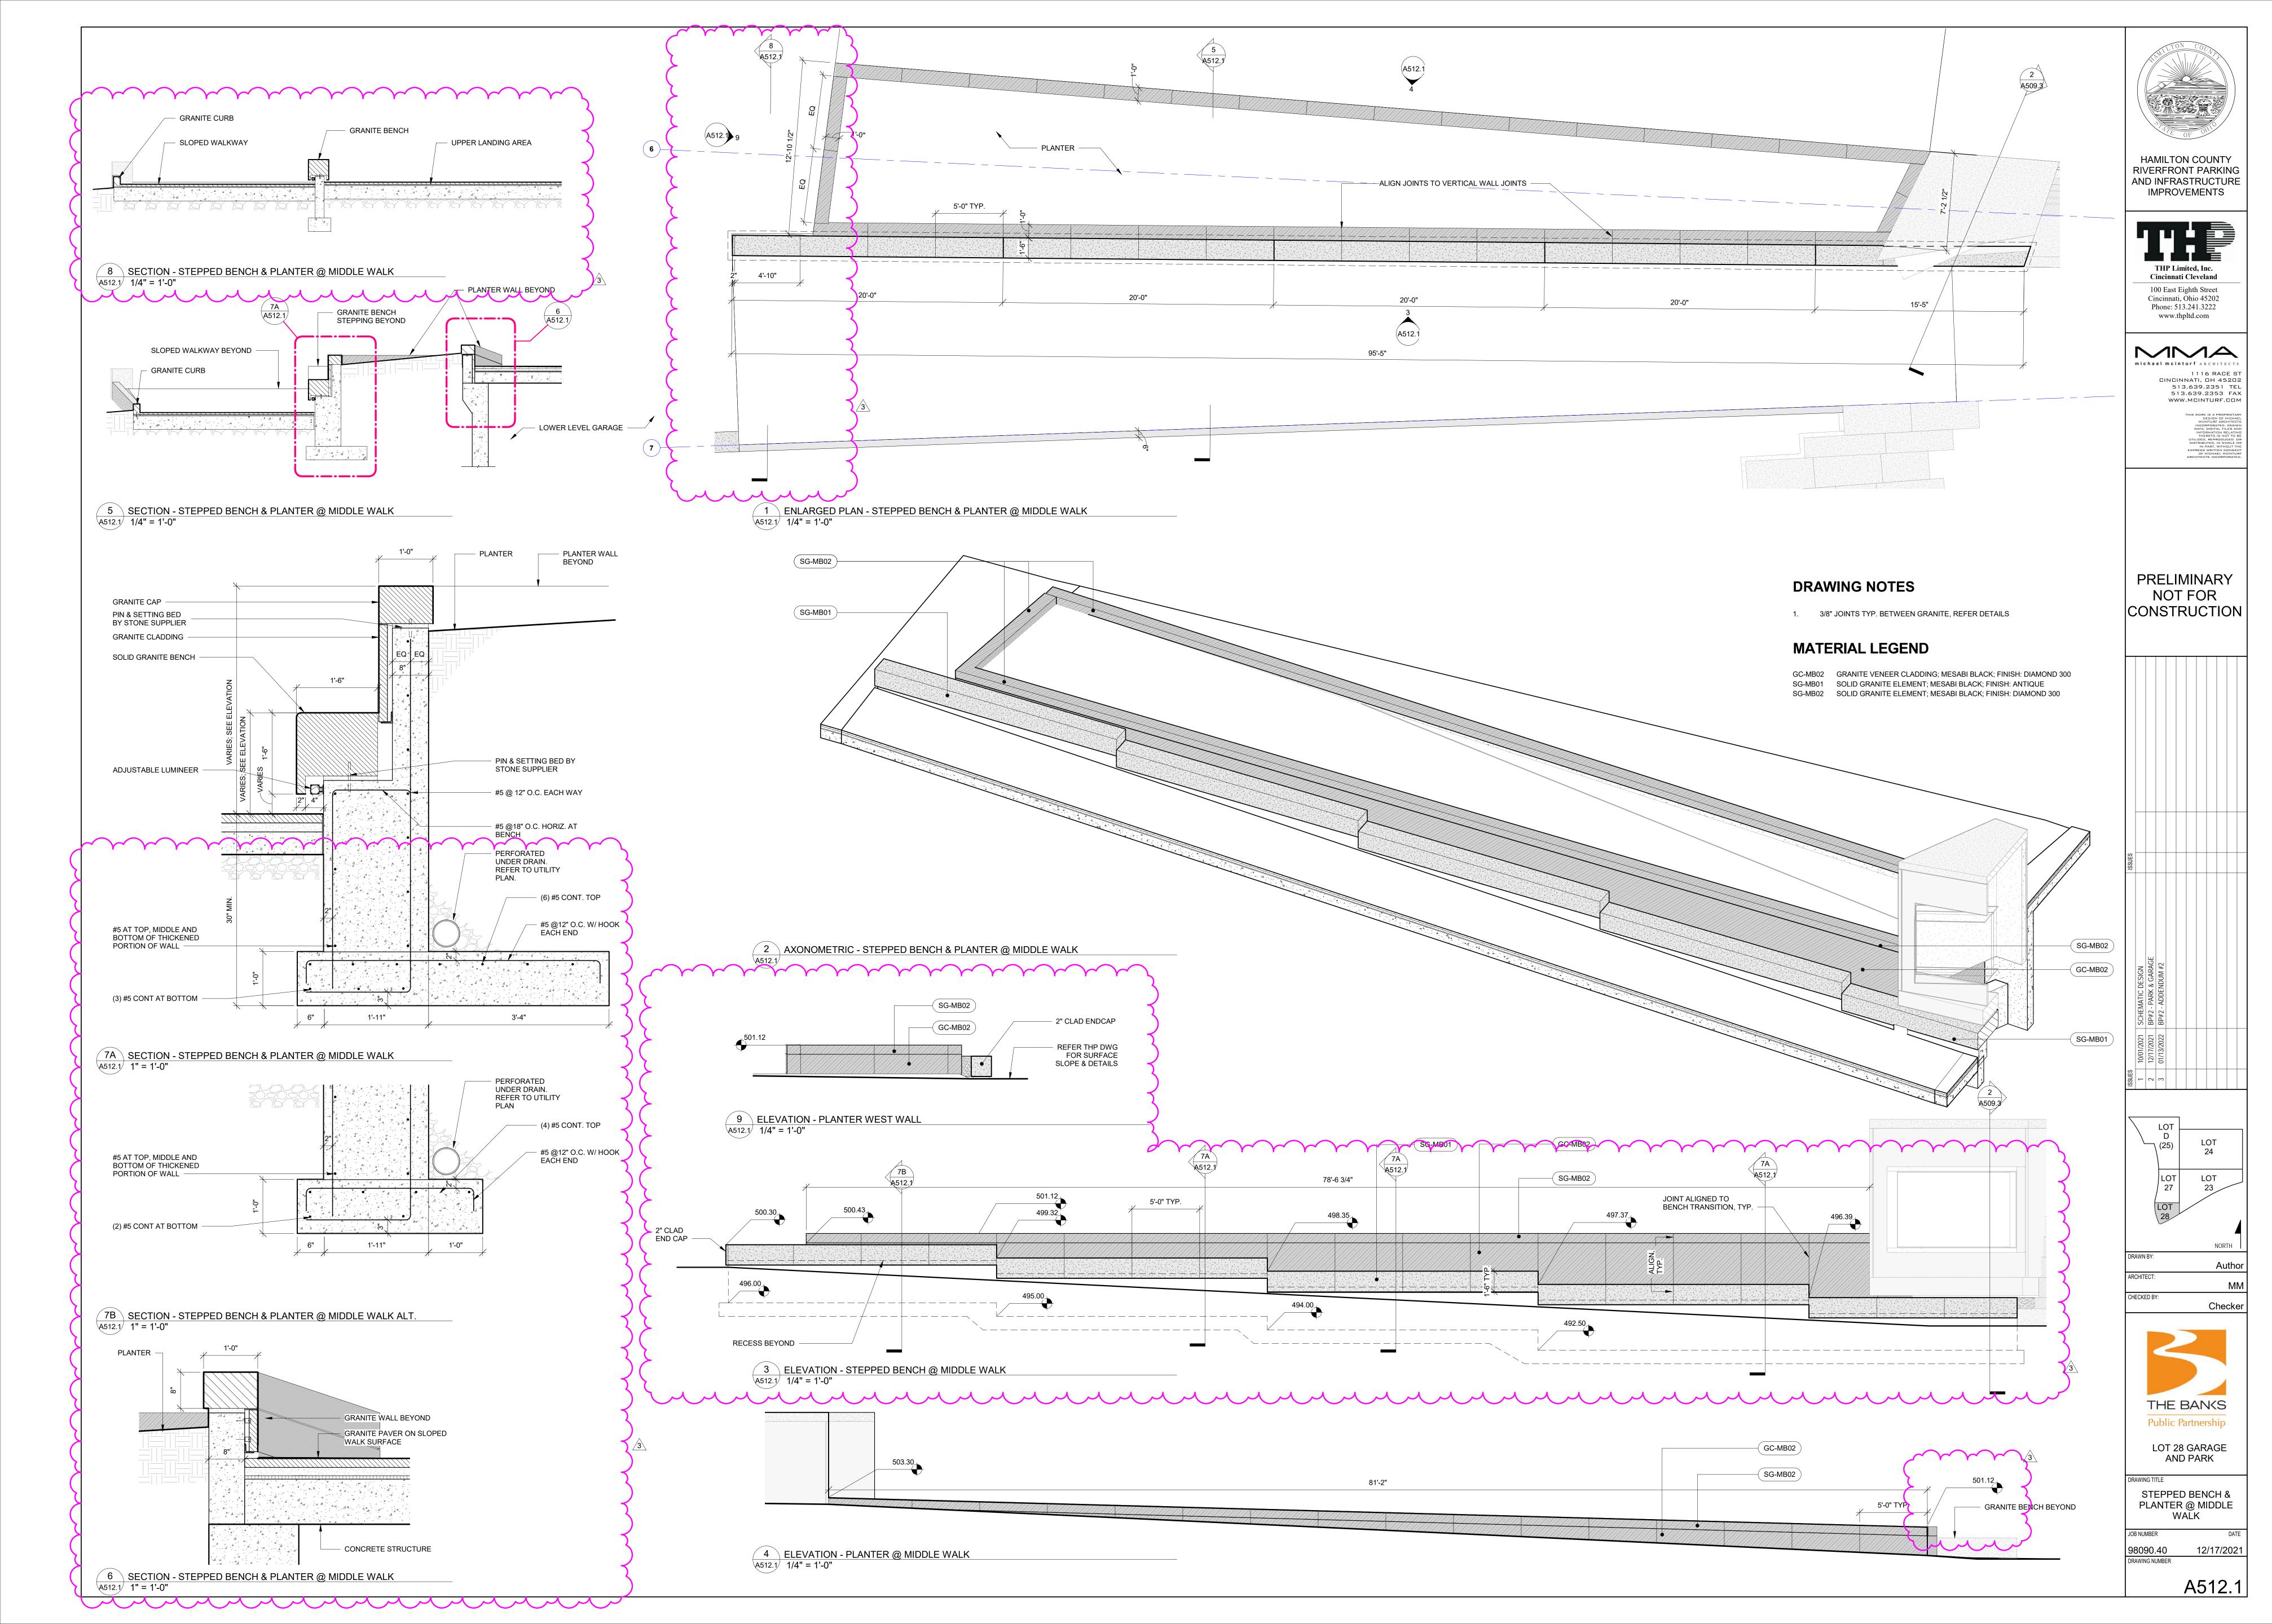

—	CHECK VALVE
→	CONCENTRIC PIPE REDUCER
—	UNION
©	CLEANOUT TO GRADE OR FINISHED FLOOR

BOTTOM CONNECTION (45°
BOTTOM CONNECTION (90°
BRANCH TEE CONNECTION (NOTE: BULLHEAD TEE'S ARE NOT PERMITTED)
DIRECTION OF PITCH
DROP
⇒ ELBOW DOWN
● ELBOW UP
EXISTING PIPE TO BE REMOVED
EXISTING PIPE TO REMAIN
FLOW DIRECTION DESIGNATION
PIPE RISER
PUMP
PUMP RISE

PLUMBING PIPING DESIGNATIONS

	EXISTING PIPE TO REMAIN
GD	GARAGE DRAINAGE PIPE
NPW	NON POTABLE WATER PIPE (HOSE BIBB)
IRR	NON POTABLE WATER PIPE - IRRIGATION
WD	NON POTABLE WATER PIPE - WASH DOWN
PD	PUMP DISCHARGE PIPE
SAN	SANITARY DRAINAGE PIPE
STM	STORM DRAINAGE PIPE
V	SANITARY SEWER VENT
WS	WATER SERVICE
OFNEDAL FL	COD DI ANIMOTEO

GENERAL FLOO	R PLAN NOTES
ELEV: 8' - 0" ELEV: 8' - 0"	APPROXIMATE DIMENSION ABOVE FINISHED FLOOR TO CENTERLINE OF PIPE, UNLESS NOTED OTHERWISE
	APPROXIMATE DIMENSION ABOVE FINISHED FLOOR TO TOP OR BOTTOM OF EQUIPMENT, UNLESS NOTED OTHERWISE
2	RISER OR STACK NUMBER
B P2	DETAIL: B = DETAIL DESIGNATION P2 = SHEET WHERE DETAIL IS LOCATED
1 P2	SECTION: 1 = SECTION DESIGNATION P2 = SHEET WHERE DETAIL IS LOCATED
A1	EQUIPMENT, DEVICE, OR PLUMBING FIXTURE MARK. LETTER DESIGNATIONS REFER TO SCHEDULES.
•	CONNECT TO EXISTING
3>	PLAN NOTE. APPLIES ONLY TO THE SHEET WHICH IT IS SHOWN UNLESS NOTED OTHERWISE.
3	DETAIL NOTE. APPLIES ONLY TO THE ASSOCIATED DETAIL.
(A1)	"UP TO" SYMBOL (ITEM ON FLOOR ABOVE)

— PLANTER DRAINAGE PIPING

ABBREVIATIONS

AFG ALT APPRO	- ABOVE FINISHED GRADE - ALTERNATE X - APPROXIMATE	FT FTG	- FEET - FOOTING
	- ARCHITECT OR ARCHITECTURAL - ASSEMBLY	G GA GAL	- GAS OR NA - GAUGE - GALLON
BLDG	- BUILDING	GALV	- GALVANIZE
BOB	- BOTTOM OF BEAM	GD	- GARAGE DF
BOF BOP	- BOTTOM OF FOOTING - BOTTOM OF PIPE	GPM	- GALLONS P
BOT	- BOTTOM	HD	- HUB DRAIN
BTU BTUH	- BRITISH THERMAL UNIT - BRITISH THERMAL UNIT PER HOUR	HP	- HORSEPOW
BTWN	- BETWEEN	ID INV	- INSIDE DIAM - INVERT ELE
CB	- CATCH BASIN	IN	- INCHES
CFCI	- CONTRACTOR FURNISHED CONTRACTOR INSTALLED	L	- LENGTH
CFM	- CUBIC FEET PER MINUTE	LBS	- POUNDS
CI	- CAST IRON		
CMU	- CONCRETE MASONRY UNIT	MAX	- Maximum

- CONCRETE MASONRY UNII - CLEAN OUT CONN - CONNECT OR CONNECTION CONTR - CONTRACTOR - CENTER - COPPER - COLD WATER - COMBINATION WATER SERVICE OR CONDENSER WATER SUPPLY

- FEET PER MINUTE AFF - ABOVE FINISHED FLOOR FPM FOOTING GAS OR NATURAL GAS GAUGE

GALLON GALVANIZED GARAGE DRAINAGE GALLONS PER MINUTE

- MANUFACTURER

- MISCELLANEOUS

- NOT IN CONTRACT

- NOT TO SCALE

INSTALLED

INSTALLED

DRAIN

PLBG - PLUMBING

PRESS - PRESSURE

REQD - REQUIRED

NOTE: ALL SYMBOLS AND ABBREVIATIONS ARE SUBJECT

TO MODIFICATIONS ON OTHER DRAWINGS.

- NATIONAL PIPE THREAD

OFCI - OWNER FURNISHED CONTRACTOR

OFOI - OWNER FURNISHED OWNER

PSF - POUNDS PER SQUARE FOOT

RCP - REINFORCED CONCRETE PIPE

- OUTSIDE DIAMETER OR OVERFLOW

- PLUMBING CONTRACTOR (DIVISION 22)

- PUMP DISCHARGE OR PARAPET

- POUNDS PER SQUARE INCH

- POUNDS PER SQUARE INCH GAUGE

- MINIMUM OR MINUTE

- MANHOLE

- NOMINAL

HUB DRAIN HORSEPOWER OR HIGH POINT INSIDE DIAMETER **INVERT ELEVATION**

- DEPTH OR DRAIN LINE - DECK DRAIN DET - DETAIL - DRAINAGE FIXTURE UNIT - DIAMETER DIM - DIMENSION

- DOWN - DOWN SPOUT OR SPRINKLER (DRY) - DRAWING

- EXPANSION JOINT ELEV - ELEVATOR - EQUAL EQUIP - EQUIPMENT - EXISTING TO REMAIN - EQUIPMENT SUPPLIER - EXPANSION

- EACH

- EXTERIOR - EXISTING EX

- FLOOR

- FLOOR CLEANOUT - FLOOR DRAIN - FINISHED FLOOR ELEVATION - FORCE MAIN

SAN - SANITARY OR SANITARY DRAIN SCH - SCHEDULE

- SHEET SPEC - SPECIFICATIONS

SQ - SQUARE - SANITARY STACK (SOIL OR WASTE) OR STAINLESS STEEL STD - STANDARD

STM - STORM OR STORM DRAINAGE STRUC - STRUCTURAL OR STRUCTURE SUC - SITE UTILITY CONTRACTOR TOB - TOP OF BEAM

TYP - TYPICAL UNO - UNLESS NOTED OTHERWISE

TOS - TOP OF SLAB OR TOP OF STEEL

TOF - TOP OF FOOTING

TOP - TOP OF PIPE

- VENT OR SANITARY SEWER VENT VEL VELOCITY - VOLUME - VENT STACK VR - VENT RISER

W/ - WITH W/O - WITHOUT W - WASTE WS - WATER SERVICE 1400 W Dorothy Lane, Dayton, OH 45409-1310 Ph 937-224-0861 Fax 937-224-5777 www.heapy.com

HAMILTON COUNTY

RIVERFRONT PARKING

AND INFRASTRUCTURE

IMPROVEMENTS

THP Limited, Inc.

Consulting Engineers 100 East Eighth Street Cincinnati, Ohio 45202

Phone: (513) 241–3222 Fax: (513) 241–2981

Heapy Engineering

ALL SYMBOLS OR ABBREVIATIONS MIGHT NOT NECESSARILY BE USED ON THIS PROJECT.

EQUIPMENT DATA

ARMSTRONG, OR VC SYSTEMS.

BP1 BOOSTER PUMP; IRRIGATION SYSTEM CME PUMP, CONSTANT PRESSURE, ON-BOARD INTEGRAL SPEED CONTROL, STAINLESS STEEL, MLE PREMIUM MOTOR, EXPANSION TANK, 1" INLET AND OUTLET ISOLATION VALVES WITH UNIONS. RATING: 15 GPM @ 53 PSI (BOOSTED PRESSURE; 28 PSI AVAILABLE AT INLET OF PUMP) ELECTRICAL: 1.5 HP - 208V - 1 PH DESIGN BASIS: GRUNDFOS "CMBE 3-62" OR ENGINEER APPROVED EQUAL.

EQUAL MANUFACTURERS ARE: SYNCROFLO, QUANTUMFLO, BELL & GOSSETT,

													DI	\mathbb{R}^{A}	IN S	SC	H	EC)U	LE	=																			
	MANUFACTURER DESIGN BASIS: ZURN		TYI	PE			ВОІ	DY			0	UTLE	ΞT			S	TRAII	NER/	GRAT	E				Т	OP FI	INISH	1		\Box			ADD	OITIO	NAL	FEA	TURE	S			
	(OR ENGINEER APPROVED EQUAL FROM BELOW LIST): J.R. SMITH, WADE, JOSAM, WATTS, MIFAB, ZURN	JR	ЭF	AGE DECK	JCH	TIRON	NZE	RESIS.	STAINLESS STEEL	OSITE		TOM				JUSTABLE		ME	ESSED	NEL	DAL RESISTANT	NLESS STEEL	S TOP GRATE	KEL-BRONZE	TIRON	RESIS.	AINLESS STEEL	STIC		HOR FLANGE	IG. CLAMP	DRAINAGE	BUCKET	STRAINER	RING PAN	CK CLAMP	ANDPIPE	PRIMER CON.	SCREEN	DRAIN
TYPE	CATALOG NOS.	FLO	P00	GAR,	TREN	CAS	BRO	ACID	STAI	COMF	SIZE	BOT	SIDE		SIZE	ADJ	FLAT	DOM	REC	FUNNEL	VANDAL	STAINL	LES	NICK	CAS	ACID	STAI	PLAS		ANC	FLS	DBL.	SED	AUX	BEAI	U'DE	2" ST	TRA	BIRD	SEE

9" RD | X | X | X | X |

9" RD | X | X | X | X |

1 DRAINS IN AREAS SUBJECT TO FREEZING IN PARKING AREAS SHALL NOT BE PROVIDED WITH P-TRAPS.

PLAZA Z415 SERIES

2 CLOSELY COORDINATE INSTALLATION LOCATIONS OF DRAINS WITH CONSTRUCTION MANAGER. CONTRACTOR SHALL ALSO REFER TO ARCHITECTURAL SHEETS.

3 PROVIDE ADDITIONAL 8-10" TALL STAINLESS STEEL PERFORATED GRATING AROUND DRAIN DOME GRATING (ZURN SUFFIX "-PS"). COORDINATE FINAL SCREEN HEIGHT WITH CM PRIOR TO PURCHASE.

	SHEET LIST PLUMBING
Sheet Number	Sheet Name
P001	LEGEND SCHEDULES & NOTES
P101	LOWER LEVEL PLUMBING PLAN
P101A	LOWER LEVEL PLUMBING PLAN (LOT 27)
P102	UPPER TERRACE LEVEL PLUMBING PLAN

| x | x | x | | | | |

| X | X | X | X |

DRAWN BY:	DDM



GARAGE LEGEND SCHEDULES &

BP#2 - PARK &

12/17/2021 98090.40 DRAWING NUMBER

3 FLEXIBLE CONNECTOR (TYP). 1. MURDOCK M-6150-LL 1.5" OUTLET, FLUSH STYLE YARD HYDRANT WITH LOCKING LID. 4 INLINE BOOSTER PUMP. 2. STEEL EDGING, 4" TALL BY 14 GA. SECURE INTO GROUND AROUND PERIMETER OF GRAVEL 5 INTEGRAL EXPANSION TANK. 3. CONCRETE BASE FLUSH WITH GRADE -6 FLOW SENSOR. REFER TO IRRIGATION DRAWINGS FOR ALL WIRING REQUIREMENTS. 4. GRAVEL DRAINAGE AROUND WEEPHOLES -MINIMUM 6 CU.FT. 7 PUMP CONTROLLER. 5. WATER SUPPLY 6. COVER SHALL BE PERMENTLY MARKED - "NON-8 UNION (TYP). 7. GRAVEL DRAINAGE - 36" DIA. x 24" DEEP. 9 IRRIGATION CONTROL SOLENOID VALVE. REFER TO IRRIGATION DRAWINGS FOR ALL WIRING REQUIREMENTS. NON-POTABLE WATER HYDRANT 10 FOR ITEMS WITHIN DASHED BOX, REFER TO IRRIGATION DRAWINGS FOR "MASTER VALVE / FLOW SENSOR" DETAIL. IRRIGATION BOOSTER PUMP DETAIL DESIGN DOCUMENTS.

— DRAIN CLEANOUT (4"-6" PVC)

C TYPICAL DETAIL AT TREE PIT (PD2 DRAIN)
SCALE: NONE

- SUBSURFACE DRAIN (PD2)

—— SLEEVES FOR TREE PIT IRRIGATION & LIGHTS/POWER (TIGHT TO UNDERSIDE OF SLAB)

4- -----

PERFORATED PERIMETER DRAIN. SEE LANDSCAPE DRAWINGS. —

2 TO IRRIGATION SYSTEM (SIZED PER DRAWINGS).

^

F------

L------

DRAIN COLLAR PIECE -

DRAIN BODY —

STAINLESS STEEL PERFORATED SCREEN —

MEMBRANE ----


STRUCTURAL SLAB —


CONTRACTOR SHALL COMPLY WITH ALL PIPE LENGTH AND PIPE DIAMETER REQUIREMENTS AS INDICATED WITHIN IRRIGATION POWER DISCONNECT BY EC. COORDINATE AND PROVIDE ALL EQUIPMENT WIRING PER MANUFACTURER'S GUIDELINES.


O DETAIL NOTES

1 PIPING FROM WATER TAP LOWER LEVEL CEILING.

○ PLAN NOTES 1. EXISTING PIPING TO REMAIN. 2. PIPING LOCATED BELOW GARAGE FLOOR SLAB. 3. EXTEND PIPING 1'-0" AFF AND TEMPORALLY CAP. HAMILTON COUNTY RIVERFRONT PARKING AND INFRASTRUCTURE IMPROVEMENTS Consulting Engineers
100 East Eighth Street
Cincinnati, Ohio 45202
Phone: (513) 241-3222
Fax: (513) 241-2981 Heapy Engineering 1400 W Dorothy Lane, Dayton, OH 45409-1310 Ph 937-224-0861 Fax 937-224-5777 www.heapy.com 4" DS DN THE BANKS Public Partnership BP#2 - PARK & GARAGE LOWER LEVEL PLUMBING PLAN (LOT 27) 98090.40 DRAWING NUMBER P101A

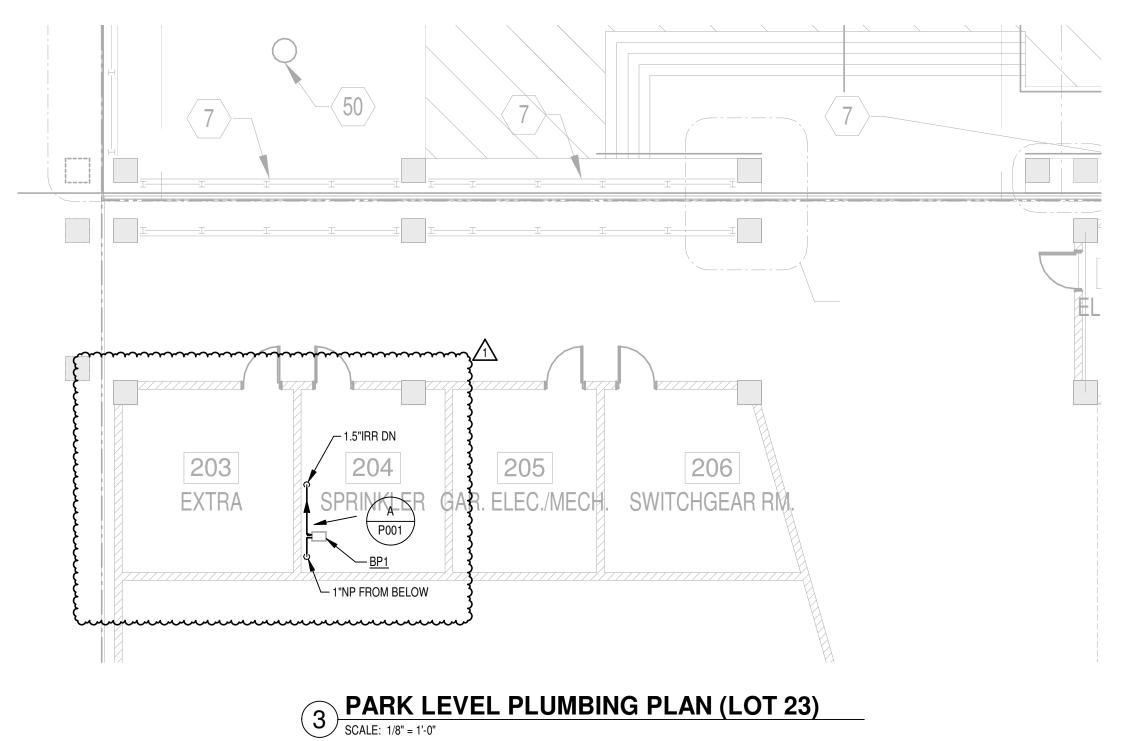

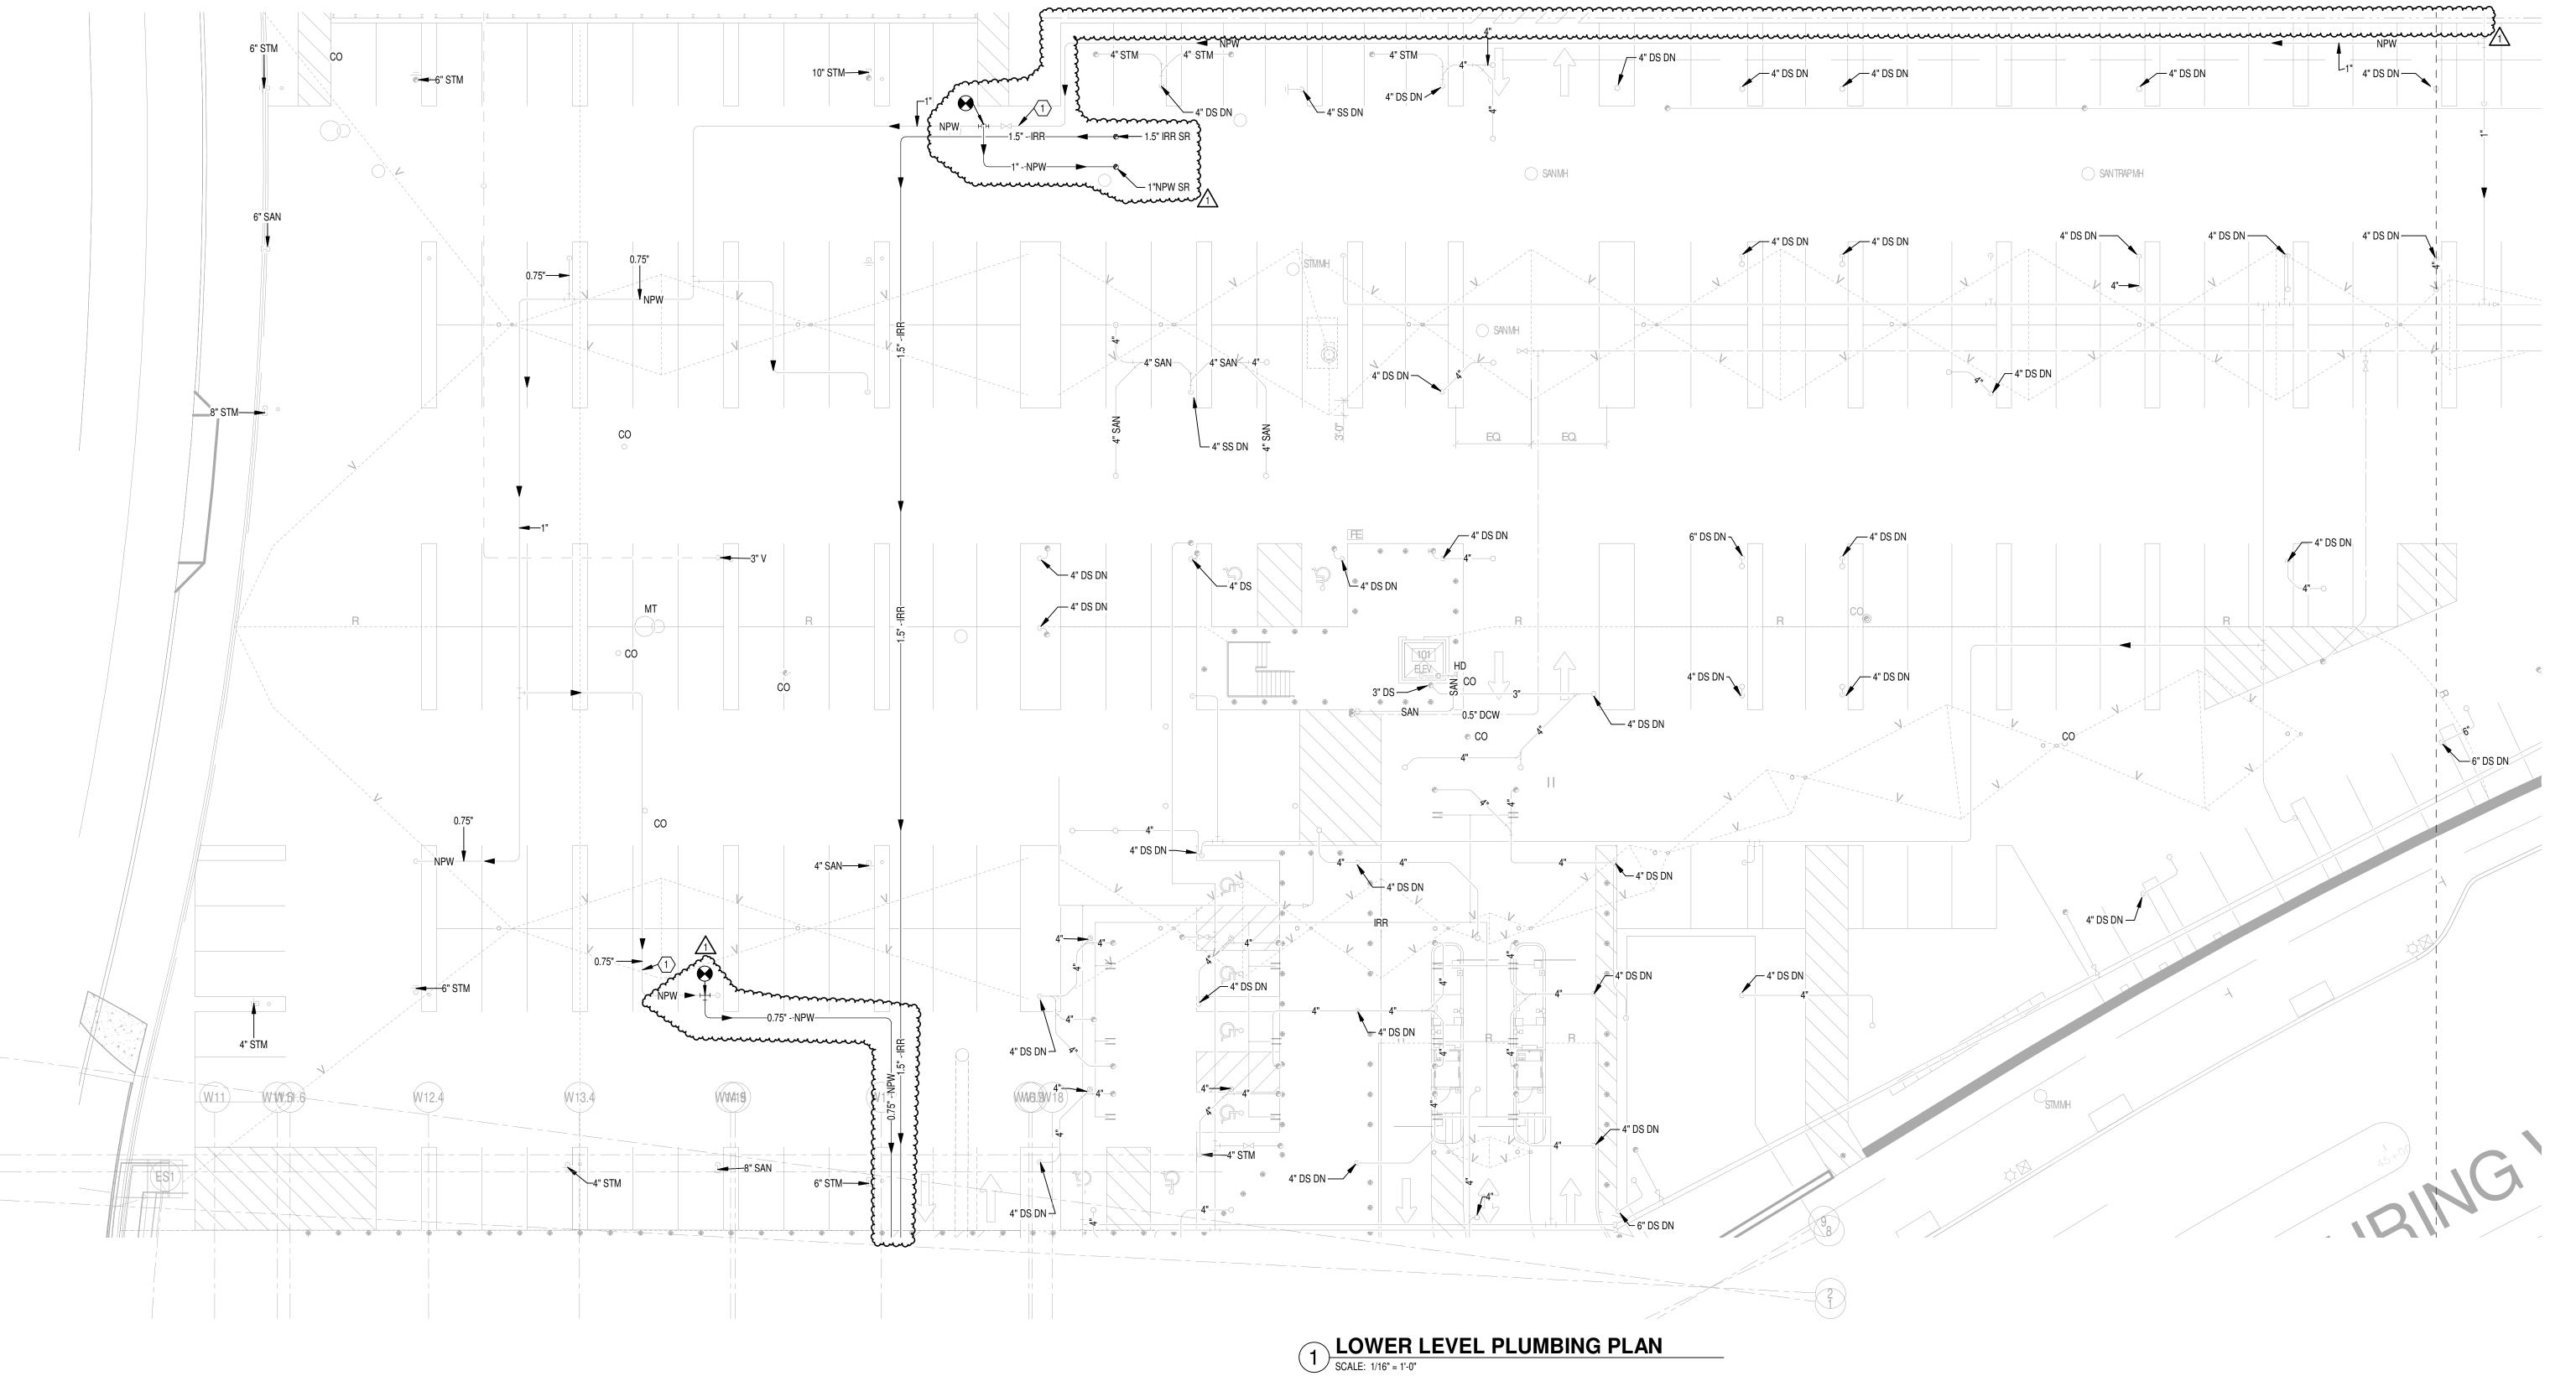

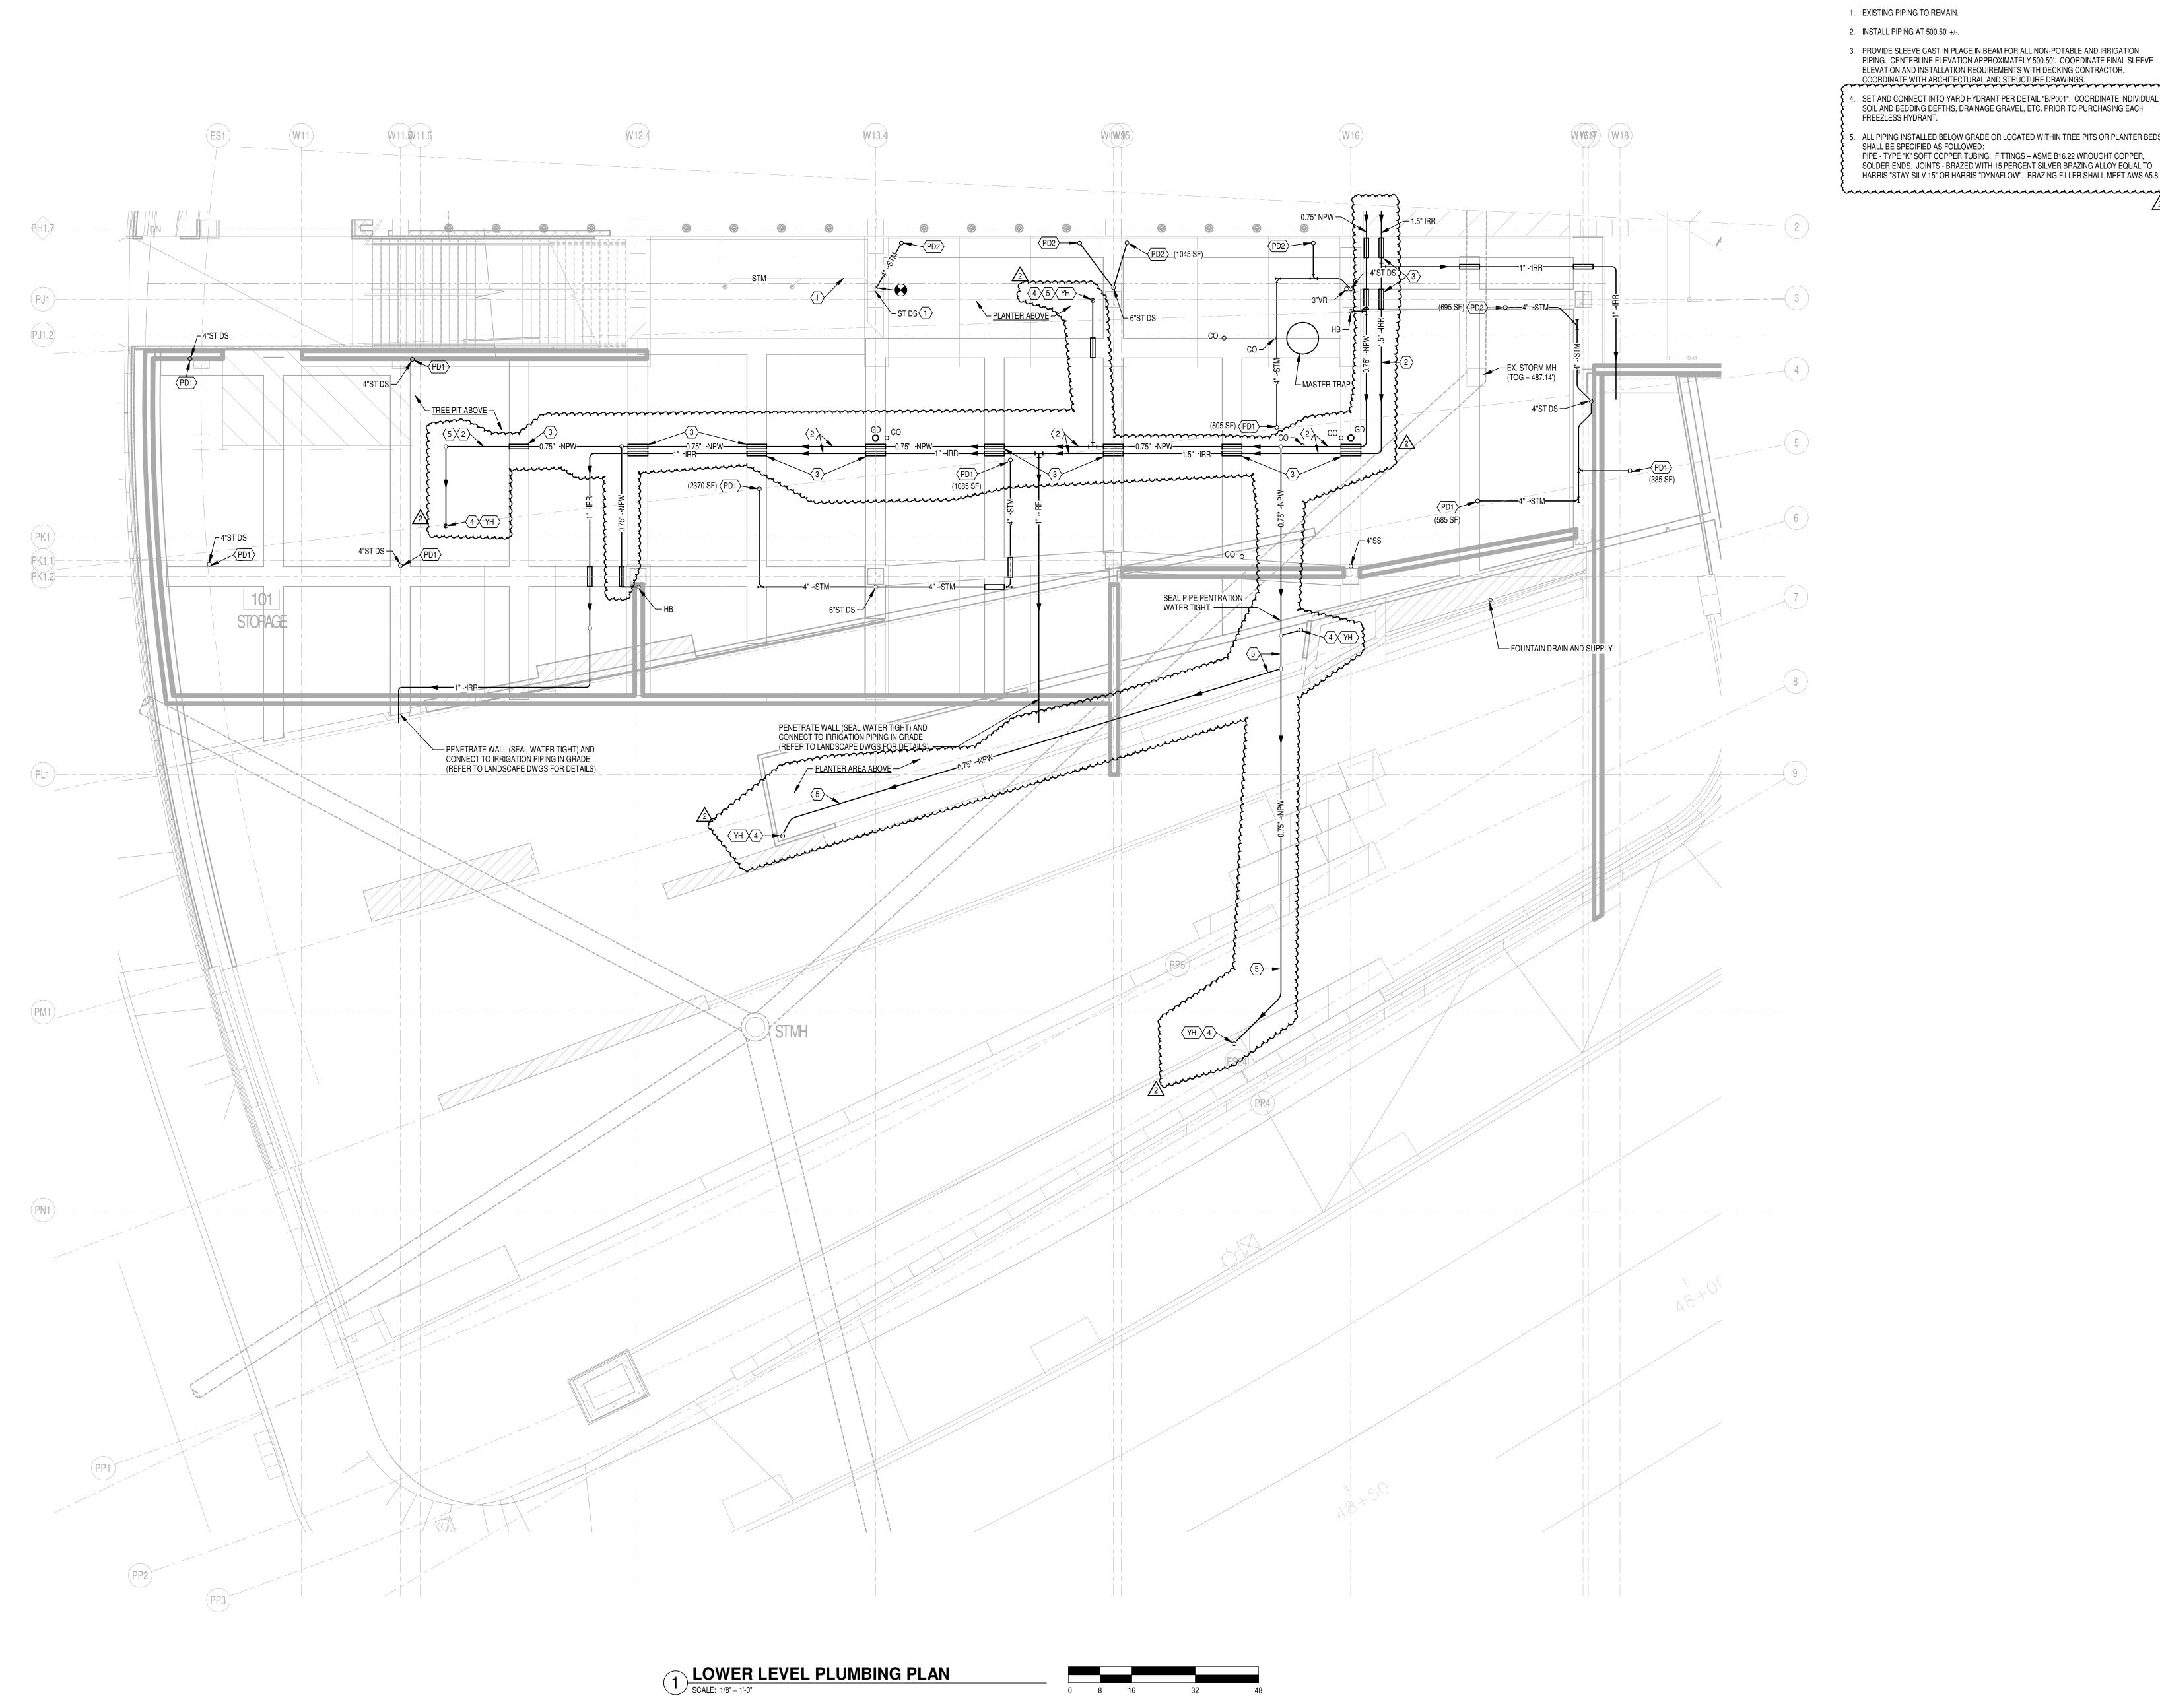

○ PLAN NOTES

- 1. EXISTING PIPING TO REMAIN.
- 2. INSTALL PIPING AT 500.50' +/-.
- 3. PROVIDE SLEEVE CAST IN PLACE IN BEAM FOR ALL NON-POTABLE AND IRRIGATION PIPING. CENTERLINE ELEVATION APPROXIMATELY 500.50'. COORDINATE FINAL SLEEVE ELEVATION AND INSTALLATION REQUIREMENTS WITH DECKING CONTRACTOR. COORDINATE WITH ARCHITECTURAL AND STRUCTURE DRAWINGS.
- I. SET AND CONNECT INTO YARD HYDRANT PER DETAIL "B/P001". COORDINATE INDIVIDUAL SOIL AND BEDDING DEPTHS, DRAINAGE GRAVEL, ETC. PRIOR TO PURCHASING EACH FREEZLESS HYDRANT.
- 5. ALL PIPING INSTALLED BELOW GRADE OR LOCATED WITHIN TREE PITS OR PLANTER BEDS SHALL BE SPECIFIED AS FOLLOWED: PIPE - TYPE "K" SOFT COPPER TUBING. FITTINGS - ASME B16.22 WROUGHT COPPER, SOLDER ENDS. JOINTS - BRAZED WITH 15 PERCENT SILVER BRAZING ALLOY EQUAL TO HARRIS "STAY-SILV 15" OR HARRIS "DYNAFLOW". BRAZING FILLER SHALL MEET AWS A5.8.




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Heapy Engineering

MEP Design Technology Planning Commissioning Energy 1400 W Dorothy Lane, Dayton, OH 45409-1310 Ph 937-224-0861 Fax 937-224-5777 www.heapy.com





THE BANKS Public Partnership

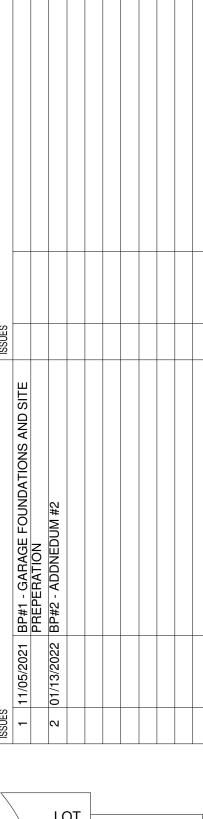BP#2 - PARK & GARAGE

LOWER LEVEL PLUMBING
PLAN

98090.40 DRAWING NUMBER

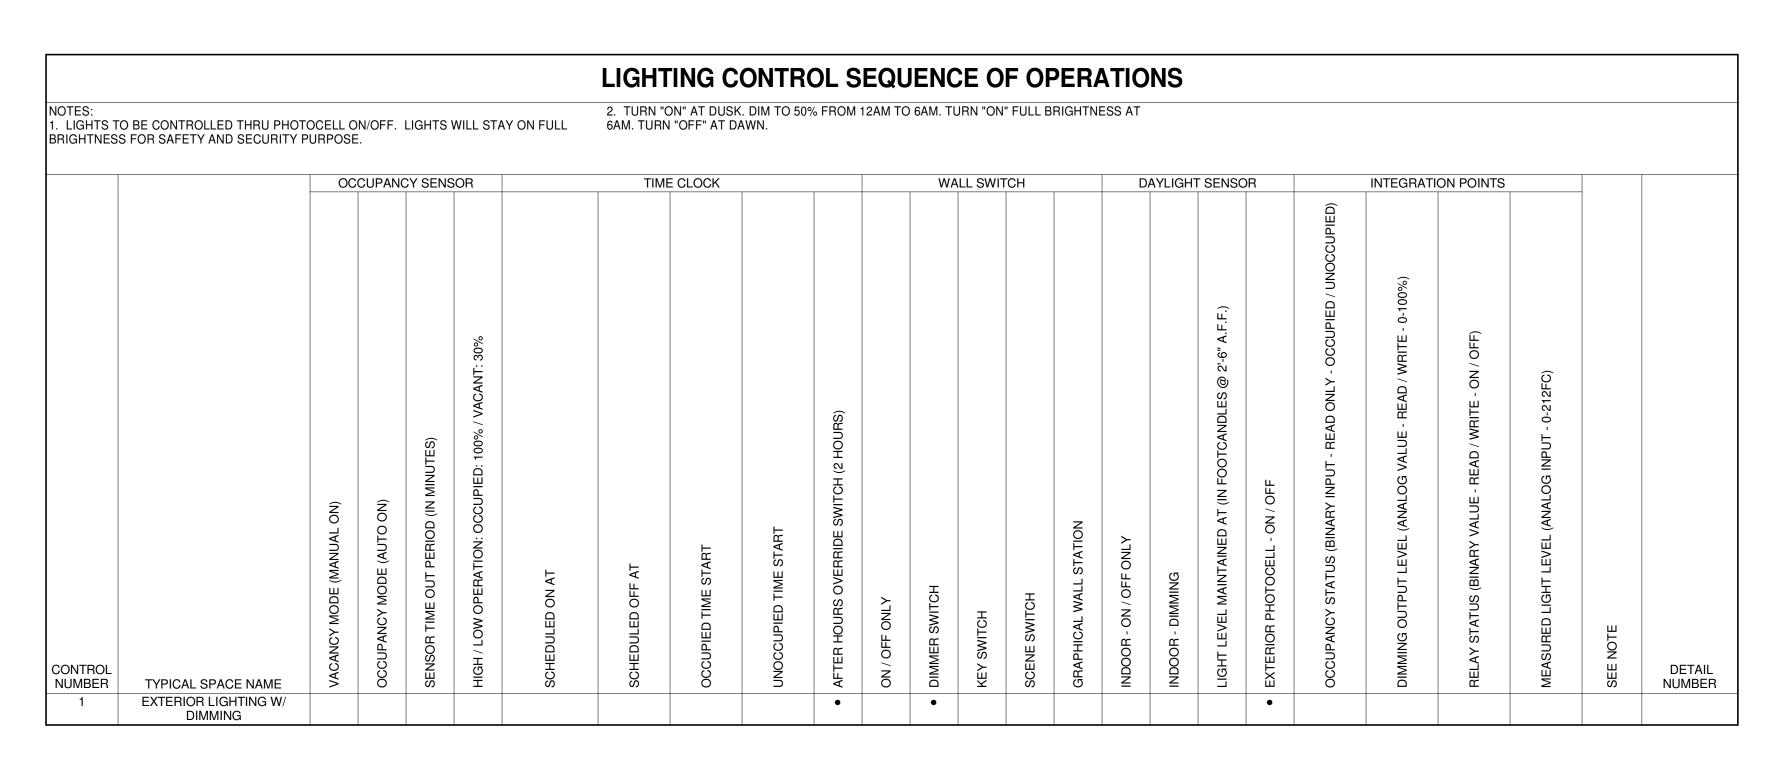

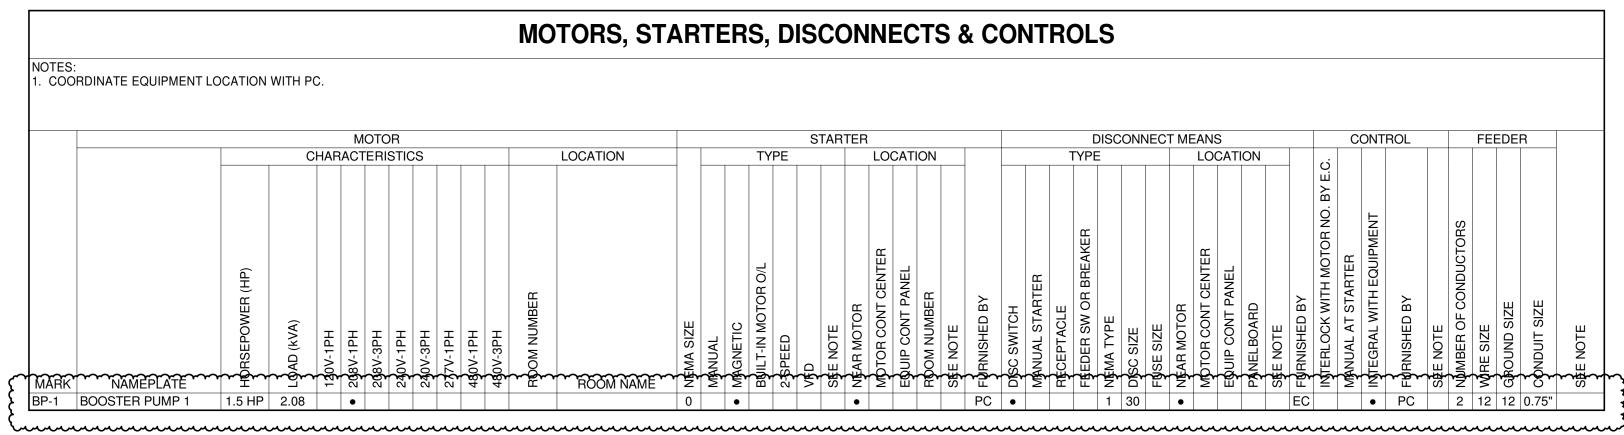

									LUMINAIRES									
			LAMPS									TI	RIM COLOR	MOUNTING		SIZE		
MARK	=LUORESCENT NCANDESCENT	E.D.	VA / LINEAR FOOT	CATALOG NO.	COLOR	LOAD (VA)	MANUFACTURER	CATALOG NO.	DESCRIPTION	OTHER ACCEPTABLE MANUFACTURERS	DIFFUSING MEDIA	WHITE	ALUMINUM BRONZE STANDABD	S-SURFACE R-RECESSED SM-STEM MTD WM-WALL MTD C-CHAIN MTD UC-UNDER CAB UCS-CEIL SURFACE PM-POLE MOUNT	OIAMETER	MIDTH	ב - 55 ב - 15 ב	SEE NOTE
C1		LED 41	IN	CLUDED		41 27	77 KURTZON	SERIES "WL-A"	ALUMINUM HOUSING. WHITE POWDER COAT FINISH, FULLY GASKETED, UL LISTED, IP65 IP55 & HD85 RATED, 80 CRI, UNIVERSAL VOLTAGE DRIVER	KENALL, PARAMOUNT	LINEAR OPAL	•	Д Ш О.	S		3.699" 49.3	375" 4.	5" 1.
										INDUSTRIES	ACRYLIC							
H1		LED 77	' IN	CLUDED	5000K	58 27	77 MCGRAW-EDISON	SERIES "TT-A3-LED-E1-WQ-DOS"	ONE PIECE CAST ALUMINUM HOUSING, POWDER COAT FINISH, LM-80, UL LISTED, IP66 & 3G VIBRATION RATED, -40 DEG TO 104 DEG TEMPRATURE RATING, DIMMING OCCUPANCY SENSOR, UNIVERSAL VOLTAGE DRIVER	LITHONIA, GARDCO, BEACON	ACYLIC LENS WITH WAVESTEAM OPTICS	•		S	18.375'	"	4.43	38" 1, 2,
H1A		LED 77	IN	CLUDED	5000K	58 27	77 MCGRAW-EDISON	SERIES "TT-A3-LED-E1-WQ-DOS"	ONE PIECE CAST ALUMINUM HOUSING, POWDER COAT FINISH, LM-80, UL LISTED, IP66 & 3G VIBRATION RATED, -40 DEG TO 104 DEG TEMPRATURE RATING, DIMMING OCCUPANCY SENSOR, UNIVERSAL VOLTAGE DRIVER, PENDANT MOUNT	LITHONIA, GARDCO, BEACON	ACYLIC LENS WITH WAVESTEAM OPTICS	•		PENDANT	18.375	"	4.4:	38" 1, 2,
K1		1 40	IN	CLUDED	4000K			ULEW-30021-T3-W40-XX-		LITHONIA, COLUMBIA	TYPE 3 DIST.		•	WM		12" 17.1	25" 6	
	\cdots			~~~~~~~~~~~~~~~~~~~~~~~~~~~~~~~~~~~~~~	400016				ON POLE LIGHT & ENTURED MOUNTED AT 401		AODVI IO LENIO	\cdots	m		}	40" 47.4	105"	,
PL6		3 85	IN	CLUDED	4000K	255 27	77 KIM LIGHTING	FIXTURE: ALT1-28L-85-4K7-4-UNV- XX-CC-CLR; POLE: KRS SERIES	20' POLE LIGHT, 3 FIXTURES MOUNTED AT 16'.	BEGA, INSIGHT, HYDREL	ACRYLIC LENS		•	PM - 20' ROUND POLE	3	12" 17.1	25" 6	
S1		1 0	18 IN	CLUDED	RGBW	0 27	77 INSIGHT LIGHTING	MER-HO-RGBWQ-1060-X X-XX"-DMXSY-CC	LINEAR WALL MOUNT LED	ARCHITECT APPROVED	10 X 60 DIST.		•	S	}	2"	1.85	,2"
-sour	mumu	my	mymy	CLUDED	ROBWW	month of the	77 OSRAWITHAXON		LEDICOLORICHANGING'STRIPLIGHTING	WARCHITECTUM	YP87LENS	mm		uuuguuu		9" 31	2" 9	
\/O		1.50		0111050			77 DEOEUELLI BAGG	RXX-B-X-0-0-44-0-1-3	DOLVOADDONATE HOLIONO LII LIOTED, DAMB LOCATION LIOTED, LINIVEDON, EASE DI ATE DOLIDI E CIDED MITH DES CITEROS AND	APPROVED	WILLIE LIQUORIC WIT			0 (DED DI 11)		011 11	0" 6.5	7511 /
X2		LED 3		CLUDED		3 27	77 BEGEHELLI PACO	SERIES "PX"	POLYCARBONATE HOUSING, UL LISTED, DAMP LOCATION LISTED, UNIVERSAL FACE PLATE DOUBLE SIDED WITH RED STENCIL LETTERS AND UNIVERSAL MOUNTING BRACKETS, MULTI-VOLTAGE	SURE LITE, CHLORIDE, LITHONIA, BARRON, COMPASS	WHITE HOUSING WITH RED STENCIL LETTERS, FACES AND DIRECTIONAL ARROWS PLAN			S (PER PLAN)		9" 13	2.37	5 1,3
X4		LED 3	IN	CLUDED		3 27	77 BEGEHELLI PACO	SERIES "PX"	POLYCARBONATE HOUSING, UL LISTED, DAMP LOCATION LISTED, UNIVERSAL FACE PLATE SINGLE SIDED WITH RED STENCIL LETTERS AND UNIVERSAL MOUNTING BRACKETS, MULTI-VOLTAGE	SURE LITE, CHLORIDE, LITHONIA, BARRON, COMPASS	WHITE HOUSING WITH RED STENCIL LETTERS, FACES AND DIRECTIONAL ARROWS PLAN			S (PER PLAN)		9" 13	3" 2.37	5" 1, 3

LUMINAIRE SCHEDULE NOTES:


LUMINAIRE MOUNTING TO MATCH THAT OF LOT 27 GARAGE.
 INTEGRAL OCCUPANCY SENSOR AT LUMINAIRE TO REDUCE LUMEN OUTPUT BY 50%.
 LUMINAIRE TO MATCH THAT OF LOT 27.

HAMILTON COUNTY






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ISSUES							
	1/13/2022 BP#2 - ADDNEDUM #2						
	1/13/2022						

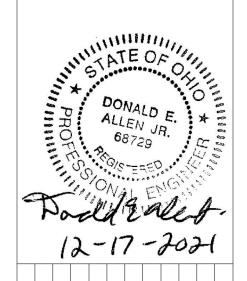LC C (2	OT) 5)	LOT 24	
L	OT 27	LOT 23	
LO 28	T		4

	NORTH
DRAWN BY:	JJT
ENGINEER:	JJT
CHECKED BY:	DA



THE BANKS
Public Partnership
BP#2 - PARK &

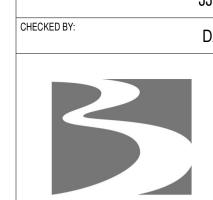SCHEDULES

JOB NUMBER
98090.40 12/17/2021
DRAWING NUMBER

E002

Supp	ocation: LOT 23 ELECTR ly From: EL-24 Voltage: 480/277 Wye-					Mounti Enclosu	ng: Surf I re: Type 1 A				Mains	Rating: 1 Type: Nating: 1	ИB	
СКТ	Circuit Description	Trip	Poles	,	4	i	3	(С	Poles	Trip	Circu	it Description	СКТ
1	EXITS LOT 23	20 A	1	34 VA	29 VA					1	20 A		LL LOT 23	2
3	EX POD LOT 23	20 A	1			112 VA	3054			1	20 A	EX	ENTRANCE	4
5	EX LL LOT 23	20 A	1					58 VA	348 VA	1	20 A	EX	LL LOT 23	6
7	EX LL LOT 23	20 A	1	1042	902 VA					1	20 A	EX	LL LOT 23	8
9	EX LL LOT 23	20 A	1			984 VA	28 VA			1	20 A	E	X Lighting	10
11	EX LOT 27 EXIT	20 A	1					52 VA	2058	1	20 A	EX EN	TRANCE AREA	12
13	EX LL LOT 27	20 A	1	662 VA	1102					1	20 A	EX	LL LOT 27	14
15	EX LL LOT 27	20 A	1			1312	756 VA			1	20 A	EX	ENTRANCE	16
17	EX LOT 27 STAIRS	20 A	1					150 VA						18
19	EX LOT 23 ELEC	20 A	1	360 VA	0 VA					1	20 A		Spare	20
21							0 VA			1	20 A		Spare	22
23	Space		1						0 VA	1	20 A		Spare	24
25	Space		1		0 VA					1	20 A		Spare	26
27	Space		1				0 VA			1	20 A		Spare	28
29	Space		1						0 VA	1	20 A		Spare	30
		Total	Load:	4.13	kVA	6.25	kVA	2.67	kVA					-
Load	Classification		С	onnecte	ed C	emand F	actor	Estimat	ed	•		Panel	Totals	
_ightir	ng			13042 V	′A	125.00	%	16303	VA					
										Tota	I Conr	. Load:	13042 VA	
										Total	Est. D	emand:	16303 VA	
											Total	Conn.:	16 A	
										Total	Est. D	emand:	20 A	
lotes	: 1) "EX" IN PANEL SC	HEDU	LE IND	ICATES	AND EX	(ISTING E	BREAKE	R AND B	RANCH	CIRCU	IIT SEF	RVED.		
	TOTAL CONNEC	TED									ES	TIMATEI	D DEMAND	

Supp	Location: LOT 23 ELECTF oly From: EP-24 Voltage: 120/208 Wye-						ng: Surf ıre: Typ 1 A				A.I.C. R Mains Iains R	Type:		
СКТ	Circuit Description	Trip	Poles	,	4		В		С	Poles	Trip	Circu	uit Description	СК
1	EX Resistive Heat	20 A	2	1450	1450					2	20 A	EX I	Resistive Heat	2
3						1450	1450							4
5	EX Resistive Heat	20 A	2					1450	901 VA	3	20 A		EX DAC-3	6
7				1450	901 VA	4								8
9	EX RECEPTACLE	20 A	1			45 VA	901 VA							10
11	EX FA	20 A	1					0 VA	45 VA	1	20 A	EX F	RECEPTACLE	12
13	EX HEAT TRACE	20 A	1	180 VA	180 V	4				1	20 A	EX	ELEV SUMP	14
15	EX Receptacle	20 A	1			720 VA	180 VA			1	20 A	ΕX	Receptacle	16
17	EX CAB LIGHTS	20 A	1					0 VA	408 VA	1	20 A		EX EF	18
19	PL6 RECEPT	20 A	1	1440	180 V	4				1	30 A		EX Power	20
21	PL6 RECEPT	20 A	1			1260	180 VA			1	30 A		EX Power	22
23	Spare	20 A	1					0 VA	0 VA	1	20 A		Spare	24
25	Spare	20 A	1	0 VA	0 VA					1	20 A		Spare	26
27	Spare	20 A	1			0 VA	0 VA			1	20 A		Spare	28
29	Spare	20 A	1					0 VA	0 VA	1	20 A		Spare	30
		Total	Load:	7.23	kVA	6.19	kVA	2.80	kVA					
Load	Classification		(Connecte	ed [Demand F	actor	Estima	ted	i		Panel	Totals	
Lightir	ng			2790 V	A	125.00)%	3488	VA					
Motor	1			3110 V	A	121.72	2%	3785	VA	Tota	I Conn	Load:	16220 VA	
Other				0 VA		0.00%	6	0 V	A	Total	Est. De	mand:	17593 VA	
Powe	r			360 V	A	100.00)%	360 \	/A		Total	Conn.:	45 A	
Recep	otacle			1080 V	A	100.00)%	1080	VA	Total	Est. De	mand:	49 A	
Resis	tive Heat			8880 V	Α	100.00)%	8880	VA					
Notes	3: 1) "EX" IN PANEL SC	CHEDU	LE IND	ICATES	AND EX	KISTING I	BREAKE	R AND E	BRANCH	CIRCU	IIT SER	VED.		
	TOTAL CONNEC	TED									EST	IMATE	D DEMAND	
	16.22 kVA										17.	59 kVA	(49 A)	

	Location: LOT 23 ELECTF ply From: L24 Voltage: 480/277 Wye					Mounti Enclosu	ng: Surf I re: Typo 1 A				Mains	Rating: 1 Type: Nating: 1	ИΒ	
СКТ	Circuit Description	Trip	Poles	,	A	ı	3		С	Poles	Trip	Circu	it Description	СК
1	EX LL LOT 23	20 A	1	232 VA	2628					1	20 A	EX	LL LOT 23	2
3	EX LL LOT 23	20 A	1			522 VA	50 VA			1	20 A	EX	LL LOT 23	4
5	EX Lighting	20 A	1					84 VA	428 VA	1	20 A	EX ST	ORAGE LOT 23	6
7	EX Lighting	20 A	1	84 VA	0 VA					1	20 A		Spare	8
9	EX LL LOT 27	20 A	1			638 VA	986 VA			1	20 A	EX	LL LOT 27	10
11	EX UH3	20 A	3					1275	1275	3	20 A		EX UH2	12
13				1275	1275									14
15						1275	1275							16
17	EX UH1	20 A	3					2162	3745	1	20 A		Lighting	18
19			~~~	2162	3381					1	20 A		Lighting	20
21				,	7	2162	3175			_ 1 _	20 A		Lighting	22
23					1 3				3430	1	20 A	~~~	Lighting	24
25					0 Y A				Luu	uqu	20A	~~~	vijarė vuvu Sparė	26
27					1 1		0 VA			1	20 A		Spare	28
~ 	Spare	20 A	سېس	~~~	~~~			0 VA	0 VA	1	20 A		Spare	30
	-		Load:	11.04	4 kVA	10.08	kVA		kVA		_		- 1	
Load	l Classification			Connecte	ed D	emand F	actor	Estimat	ed			Panel	Totals	
Light	ing			19383 \	/A	125.00	%	24229	VA					
Moto	-			14134 \	/A	111.47	%	15755	VA	Tota	I Conr	. Load:	33517 VA	
													39983 VA	
												Conn.:		
										Total		emand:		
Note	s: 1) "EX" IN PANEL SO	CHEDU	LE IND	DICATES	AND EX	(ISTING E	BREAKE	R AND E	BRANCH	CIRCU	IT SEF	RVED.		
	TOTAL CONNEC	TED											D DEMAND	
	33.52 kVA										39	.98 kVA	(48 A)	

Supp	ocation: LOT 24 ELECTR ly From: Voltage: 480/277 Wye-						ng: Surf ire: Type 1 A				Mains	Rating: 10,000 Type: MB Rating: 200 A	
СКТ	Circuit Description	Trip	Poles	,	4		В		C	Poles	Trip	Circuit Description	СКТ
1	EX DPAP	20 A	3	1109	1109					3	20 A	EX DAC2	2
3						1109	1109						4
5								1109	1109				6
7	EX JP1	20 A	3	1386	6651					3	30 A	EX EUH-1	8
9						1386	6651						10
11								1386	6651				12
13	EX EUH-3	25 A	3	4988	4988					3	25 A	EX EUH-2	14
15						4988	4988					==	16
17								4988	4988				18
19	EX MOTOR	20 A	3	1109	4610					3	45 A	EX T10	20
21						1109	3540						22
23								1109	3030				24
25	EX Spare	20 A	3	0 VA						1		Space	26
27						0 VA				1		Space	28
29								0 VA		1		Space	30
31	EX Spare	20 A	1	0 VA						1		Space	32
33	EX Spare	20 A	3			0 VA				1		Space	34
35								0 VA		1		Space	36
37				0 VA						1		Space	38
39	EX Spare	20 A	1			0 VA				1		Space	40
41	EX Spare	20 A	1					0 VA		1		Space	42

tes: 1) EXISTING PANELBOARD LOCATED AT LOT 24 SHOW!	N FOR REFERENCE ONLY.
2) "EX" IN PANEL SCHEDULE INDICATES AND EXISTING	
TOTAL CONNECTED	ESTIMATED DEMAND
TOTAL CONNECTED 75.2 kVA	ESTIMATED DEMAND 75.84 kVA (91 A)

СКТ	Circuit Description	Trip	Poles		4	E	3	(С	Poles	Trip	Circu	it Description	СКТ
1	EX Blue Light	20 A	1		360 VA					1	20 A		K Blue Light	2
3	EX Security	20 A	1			1000	1000			1	20 A	Е	X Security	4
5	EX Blue Light	20 A	1					180 VA	500 VA	1	20 A	Е	X Security	6
7	EX Blue Light	20 A	1	360 VA	1180					1	20 A	Е	X Security	8
9	EX Power	20 A	1			180 VA	1000			1	20 A	Е	X Security	10
11	Spare	20 A	1					0 VA	1310	2	20 A		EX CU-1	12
13	EX Receptacle	20 A	1	180 VA	1310									14
15	EX PAY STATION	20 A	1			180 VA	180 VA			1	20 A	~EXE	LEV L LOT 23	16
17	Space		1						1040	2	20 A	BO	OSTER BP-1	18
19	Space		1		1040					-				20
		Total	Load:	4.61	kVA	3.54	kVA	3.03	kVA	Lun	نسس			·····
Load	Classification		(Connecte	ed D	emand F	actor	Estimat	ed			Panel	Totals	
Moto				4701 V		113.50		5335 \						
Powe	er			5760 V		100.00		5760 \					11181 VA	
Rece	ptacle			720 V	4	100.00	%	720 V	/A	Total			11815 VA	
												Conn.:	_	
										Total	Est. Do	emand:	33 A	






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Ph 937-224-0861 Fax 937-224-5777 www.heapy.com



01/13/2022 BP#2 - ADDNEDUM #2

01/13/2022 BP#2 - ADDNEDUM #2

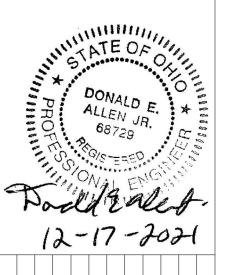LOT D (25)	LOT 24
LOT 27	LOT 23
	NORTH

DRAWN BY:	JJT
ENGINEER:	JJT
CHECKED BY:	DA




BP#2 - PARK & GARAGE

PANELBOARDS

JOB NUMBER
98090.40
DRAWING NUMBER


12/17/2021 ER **E003**

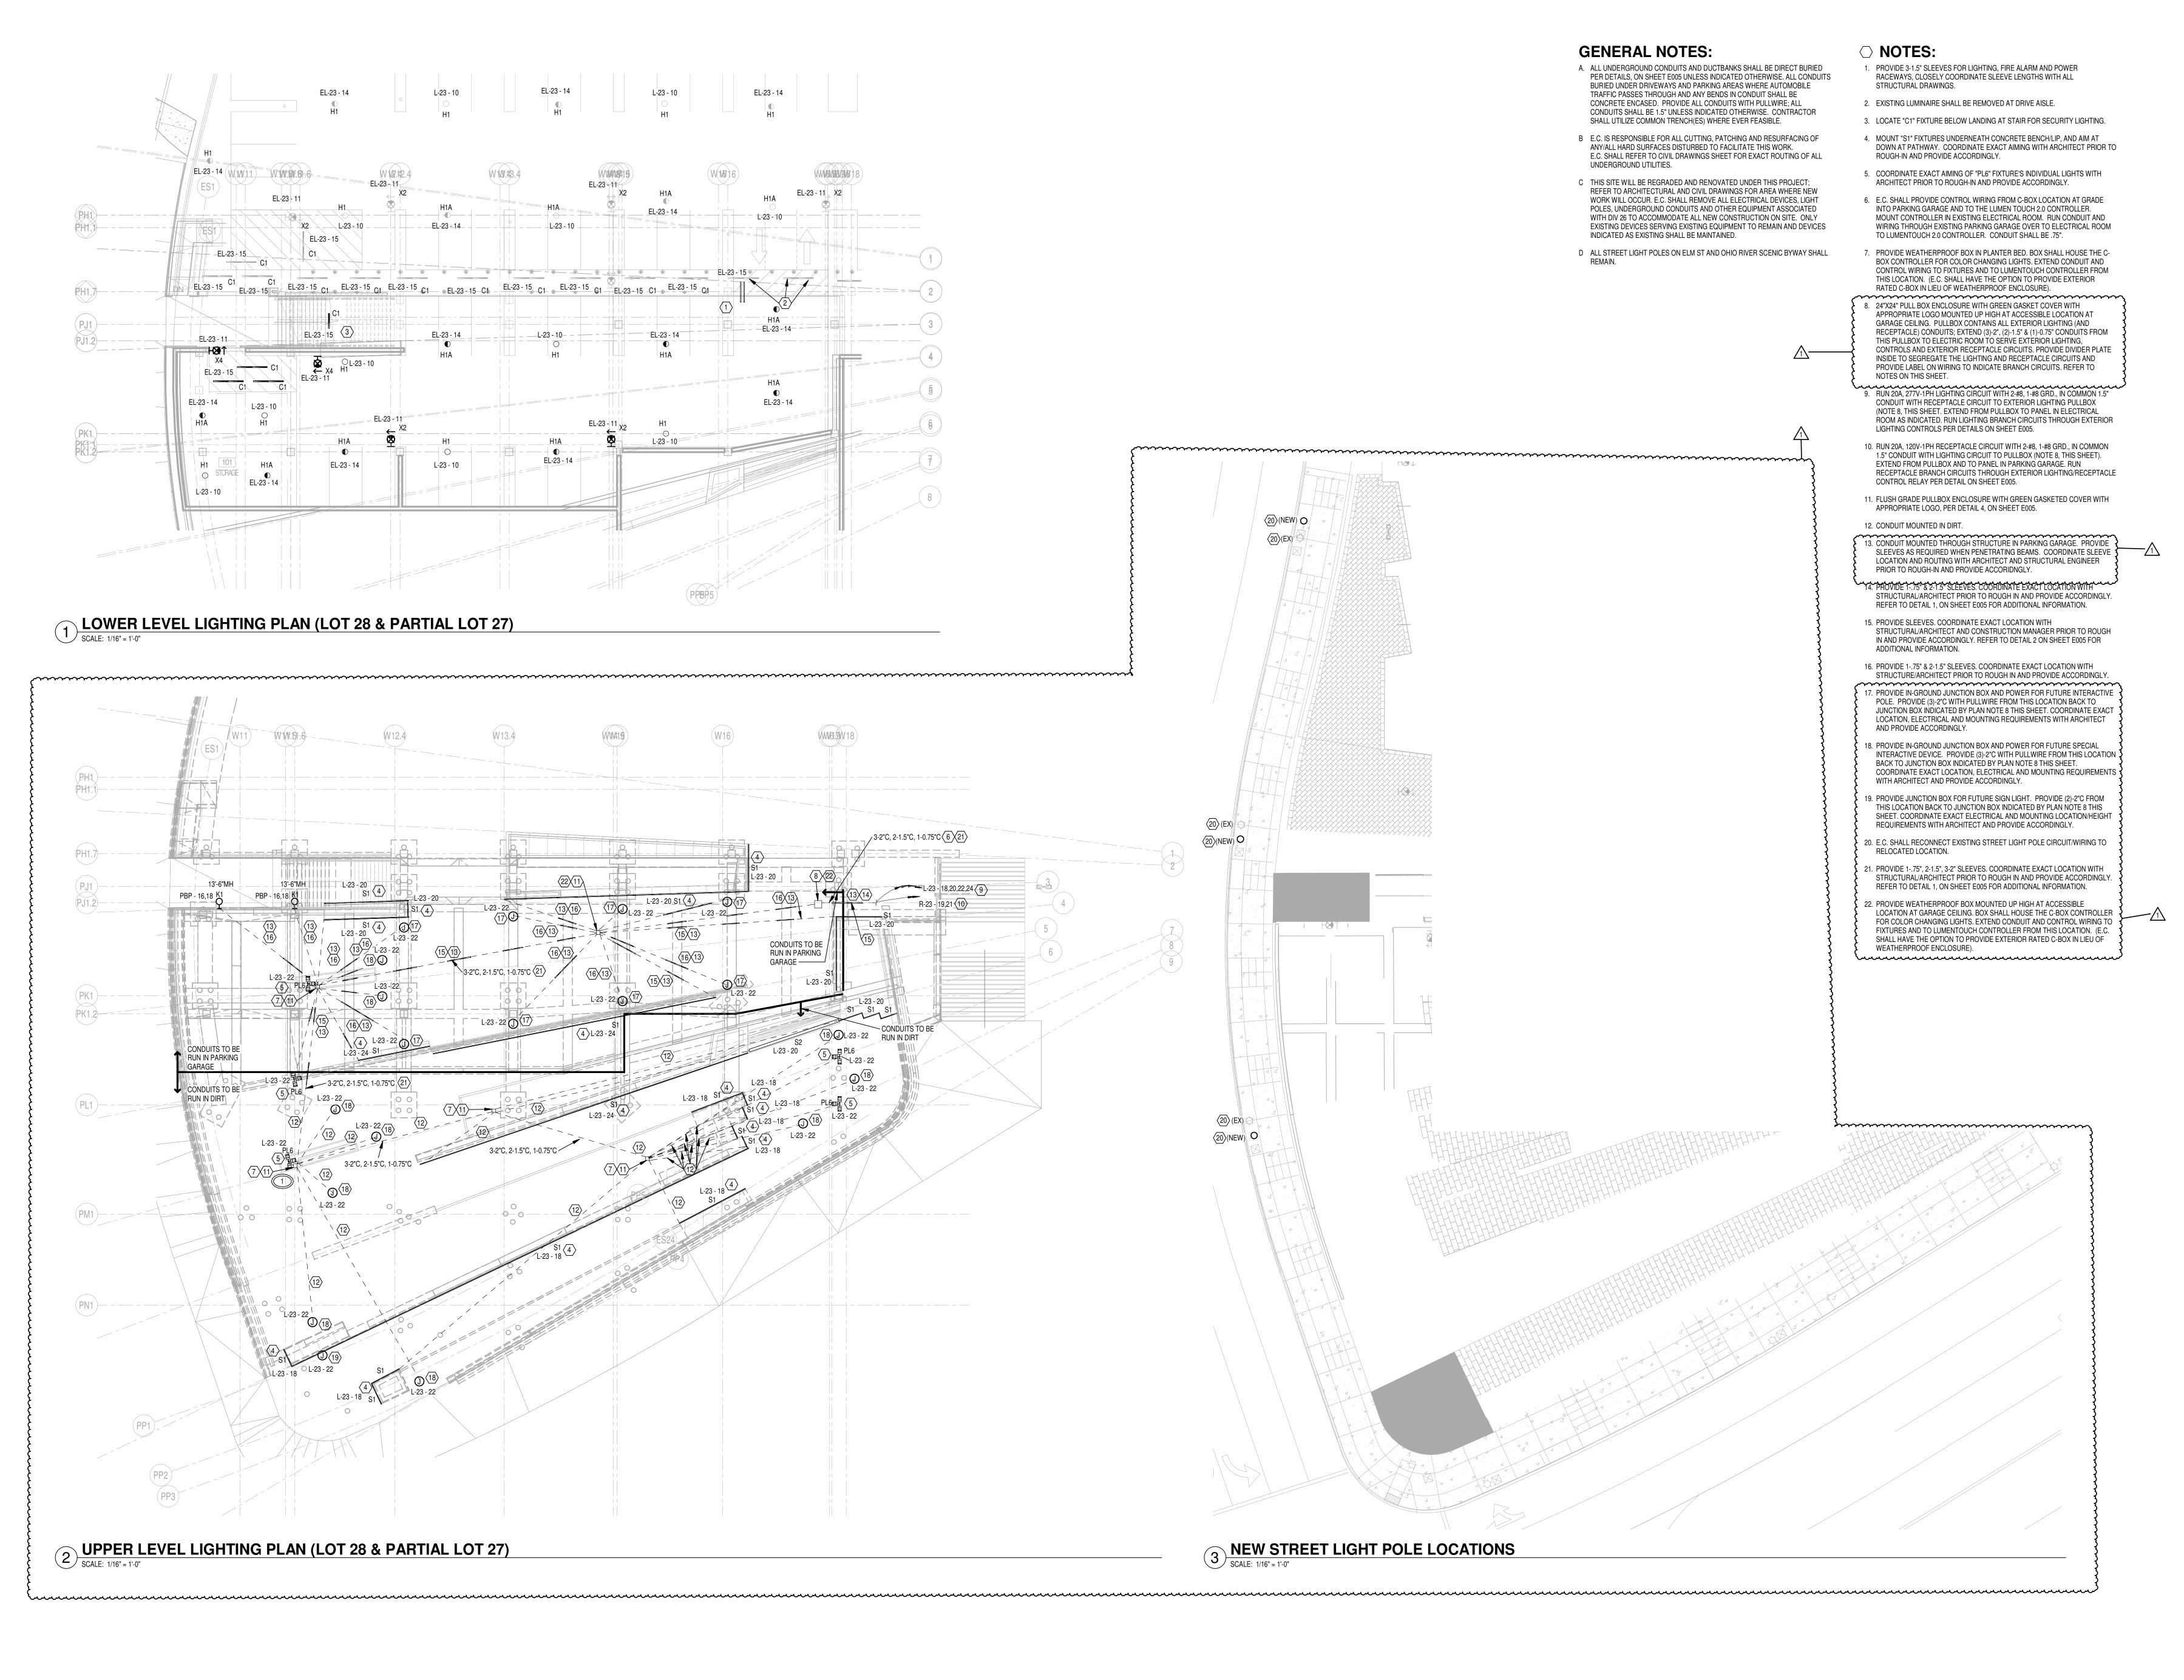





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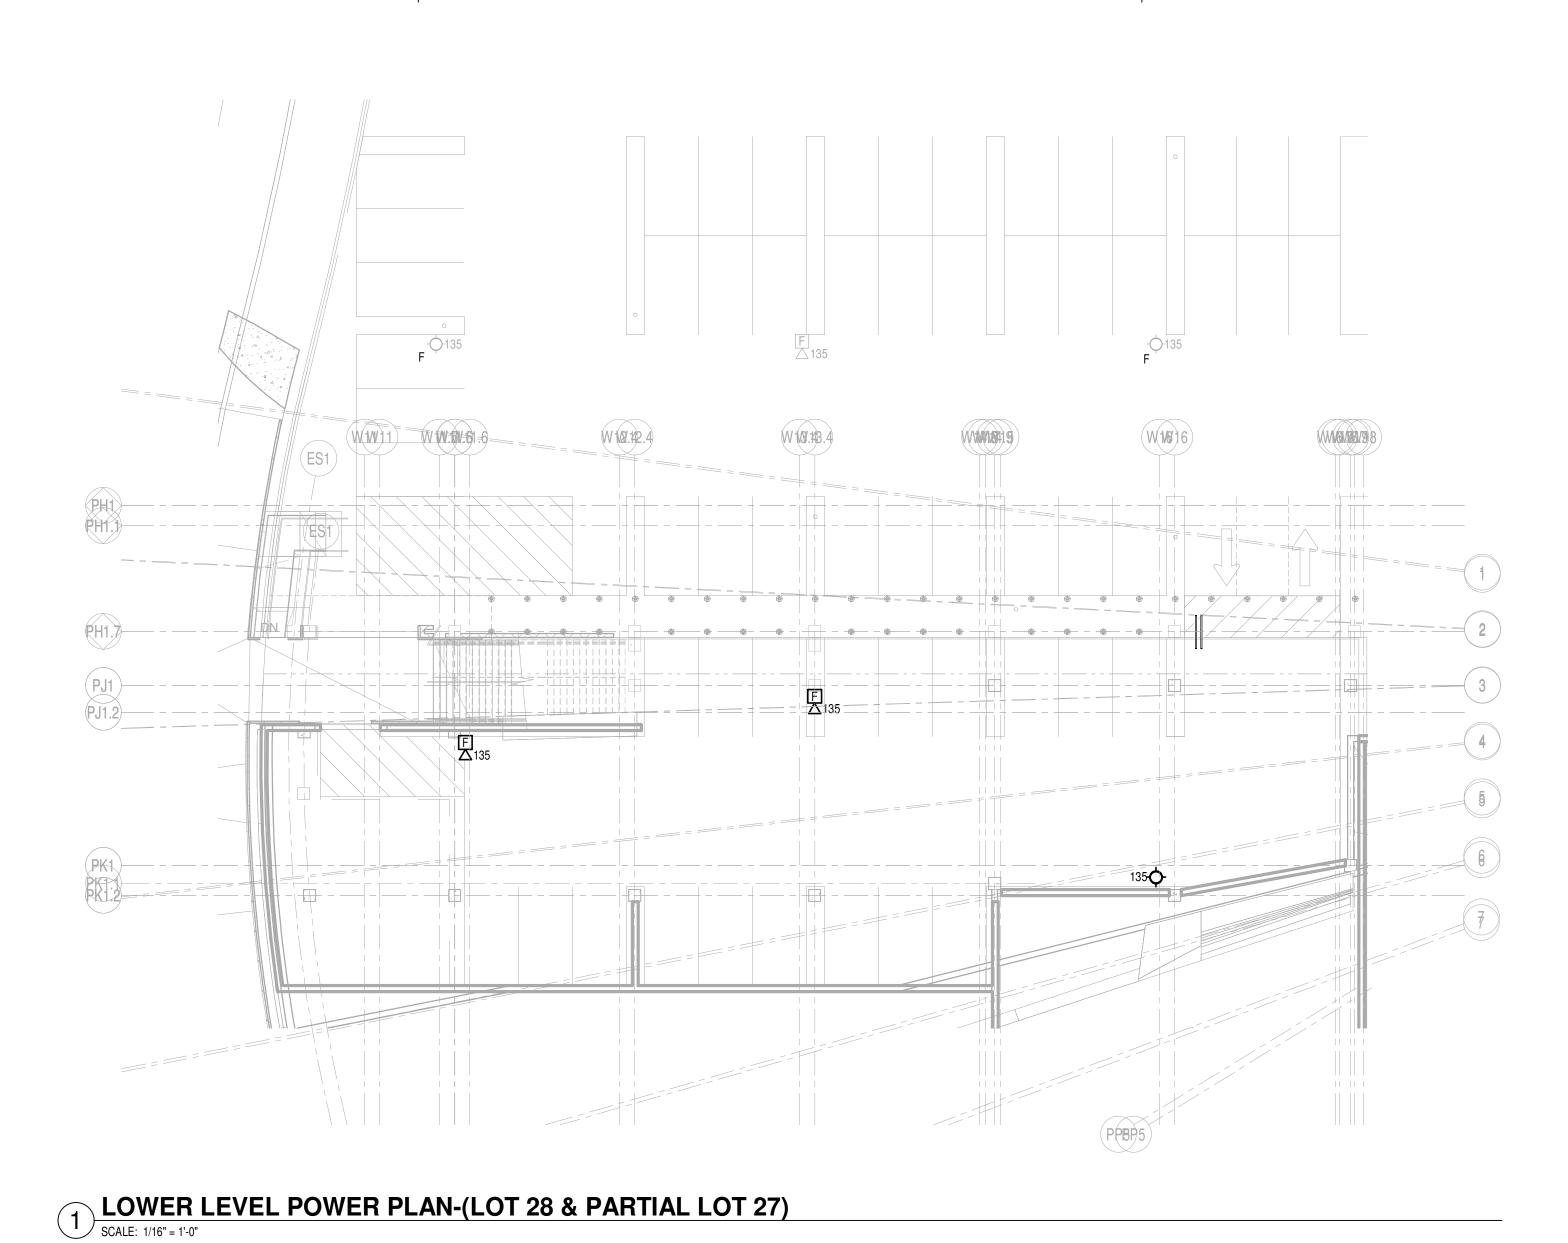
THE BANKS

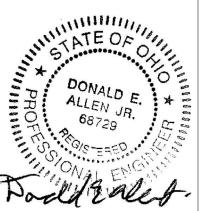Public Partnership BP#2 - PARK &

GARAGE

LIGHTING PLANS LOT 28

98090.40 DRAWING NUMBER




○ PLAN NOTES

2 EXISTING (LOT 23) ELECTRIC ROOM ENLARGED

SCALE: 1/8" = 1'-0"

 PROVIDE NEW LUMENPULSE LUMEN TOUCH 2.0 (LT02) OR EQUAL. S1 AND S2 FIXTURES DMX TO BE DAISY CHAINED. PROVIDE DMX COMPATIBILITY WIRING FROM S1 AND S2 TO THE LT02. PROVIDE ALL THE COMPONENTS NECESSARY TO MAKE A COMPLETE AND OPERATIONAL SYSTEM AND INSTALLATION.

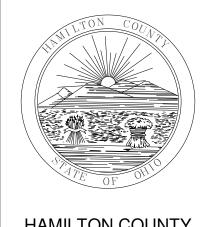


HAMILTON COUNTY RIVERFRONT PARKING AND INFRASTRUCTURE IMPROVEMENTS



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Padd Ealet 12-17-2021

3/2022 BP#2 - ADDNEDUM #2

LOT D LOT 24

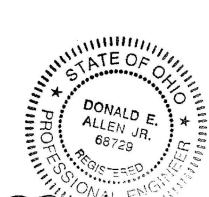LOT 27 23

LOT 28

DRAWN BY:

JJT

ENGINEER:

JJT

CHECKED BY:

DA



PRAWING TITLE
POWER PLANS LOT 28

JOB NUMBER
98090.40 12/17/2021
DRAWING NUMBER